

Owner/Applicant DAWSON CANYON LLC 11777 SAN VICENTE BLVD, STE. 780 LOS ANGELES, CA 90049 TEL: (949) 842-3074 CONTACT: MATT ENGLHARD

Project Address

2019 CALIFORNIA PLUMBING CODE 2019 CALIFORNIA MECHANICAL CODE 2019 CALIFORNIA ELECTRICAL CODE 2019 CALIFORNIA FIRE CODE 2019 CALIFORNIA ENERGY CODE

2019 CALIFORNIA BUILDING CODE 2019 CALIFORNIA GREEN BUILDING STANDARDS Applicant's Representative 18831 BARDEEN AVE., SUITE 100 IRVINE, CA 92612 (949) 862-2161 (949) 863-0851

CONTACT: ANDY WIYANTO M-SC MANUFACTURING-SERVICE COMMERCIAL

File Number DEIR (CEQ200092), GPA200007 CZ2000028, LLA200028, GE0200040 AND HANS190024. PP220039, TPM38551 AND THE RELATED CASES ARE BEING PROCESSED CONCURRENTLY

Assessors Parcel Number 283-160-046 283-190-044 Construction Type

CONCRETE TILT-UP BUILDING BUILDING OCCUPANCY: S-1 / B CONSTRUCTION TYPE : III-B

ESFR SYSTEM

THE LAND REFERRED TO IN THIS COMMITMENT IS SITUATED IN THE UNINCORPORATED AREA OF THE COUNTY OF RIVERSIDE, STATE OF CALIFORNIA, AND IS DESCRIBED AS

PARCEL 2 OF NOTICE OF LOT LINE ADJUSTMENT NO. LLA200028, RECORDED JUNE 21, 2021 AS INSTRUMENT NO. 2021-0373323 OF OFFICIAL RECORDS OF RIVERSIDE COUNTY, CALIFORNIA, BEING THOSE PORTIONS OF THE LAND DESCRIBED IN PARCELS QUARTER OF SECTION 35, TOWNSHIP 4 SOUTH, RANGE 6 WEST, SAN BERNARDINO MERIDIAN, IN THE UNINCORPORATED TERRITORY OF THE COUNTY OF RIVERSIDE, STATE OF CALIFORNIA, RECORDED JUNE 30, 1987 AS INSTRUMENT NO. 186951, OF OFFICIAL RECORDS OF SAID COUNTY, BOUNDED AS FOLLOWS:

ON THE NORTHWEST BY THE SOUTHEASTERLY LINE OF DAWSON CANYON ROAD AS DESCRIBED IN PARCEL 1 OF "CORPORATION QUITCLAIM DEED", RECORDED MAY 03, 2002 AS DOCUMENT NO. 2002-236679, OF OFFICIAL RECORDS OF SAID COUNTY;

AND BOUNDED EASTERLY BY THE FOLLOWING DESCRIBED LINE: COMMENCING AT THE WESTERLY TERMINUS OF THAT CERTAIN MOST SOUTHERLY LINE OF SAID PARCEL 6, DESCRIBED AS HAVING A BEARING AND DISTANCE OF "NORTH 89" 51' 27" EAST, 840.06 FEET", SAID WESTERLY TERMINUS ALSO BEING ON THE EASTERLY LINE OF TEMESCAL CANYON ROAD (40.00 FEET HALF-WIDE) AS SHOWN ON PARCEL MAP NO. 31196, AS PER MAP FILED IN BOOK 208, PAGES 50 THROUGH 53, INCLUSIVE OF PARCEL MAPS, IN THE OFFICE OF THE COUNTY RECORDER OF SAID COUNTY; THENCE ALONG SAID MOST SOUTHERLY LINE OF PARCEL 6, NORTH 89° 51' 27" EAST, 586.31 FEET TO A POINT ON THE MOST SOUTHERLY LINE OF SAID PARCEL 8. SAID POINT BEING THE TRUE POINT OF BEGINNING: THENCE NORTH 27° 54' 55" EAST 499.99 FEET TO THE BEGINNING OF A TANGENT CURVE, CONCAVE WESTERLY AND HAVING A RADIUS OF 1080.00 FEET; THENCE

LENGTH OF 598.43 FEET; THENCE TANGENT TO SAID CURVE, NORTH 03' 46' 59" WEST 269.31 FEET TO A POINT ON THAT CERTAIN NORTHERLY CURVED LINE OF SAID PARCEL 8 DESCRIBED AS HAVING A RADIUS OF 700.00 FEET AND A LENGTH OF 143.85 FEET, SAID POINT BEING THE END POINT OF THIS DESCRIPTION.

APN: PORTIONS OF APNS 283-160-046 AND 283-190-044

NORTHERLY ALONG SAID CURVE, THROUGH A CENTRAL ANGLE OF 31° 44' 51", AN ARC




CONCRETE PAVING
SEE "C" DRWGS. FOR THICKNESS LANDSCAPED AREA PATH OF TRAVEL ASPHALT CONCRETE PAVING SEE "C" DRWGS. FOR THICKNESS 26' WIDE FIRELANE STANDARD PARKING STALL (9' X 18') EXISTING PUBLIC FIRE HYDRANT STANDARD PARKING
STALL W/ 2' OVERHANG PRIVATE FIRE HYDRANT-APPROXIMATE LOCATION COMPACT PARKING STALL
(8.5' X 16') MAX. 40% OF REQUIRED ////// ACCESSIBLE PARKING (VAN) STALL (12' X 18') + 5' W/ ACCESSIBLE PARKING _____ STALL (9' X 18') + 5' W/ ACCESSIBLE AISLE EV PARKING CLEAN AIR/VANPOOL/EV

(PROVIDE CONDUIT FOR

FUTURE EV CHARGING)

EV AMBULATORY PARKING

_____ STALL (10' X 18')

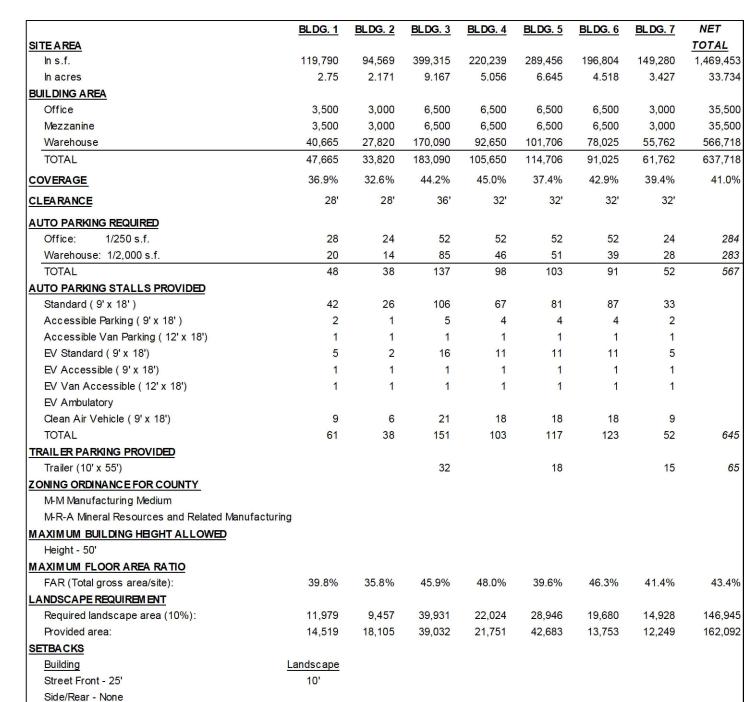



hpa, inc. 18831 bardeen avenue - ste #100 irvine, ca tel: 949 •863 •1770 fax: 949 • 863 • 0851 email: hpa@hparchs.com



Owner: DAWSON CANYON LLC.

11777 San Vicente Blvd, Ste. 780 Los Angeles, CA 90049 tel: (949) 296-7006 fax: (949) 842-3074

Project:

TEMESCAL VALLEY COMMERCE CENTER

> DAWSON CANYON RD. **CORONA, CA 92883**


Consultants:

THIENES Structural: Mechanical Plumbing: Electrical: Landscape: HUNTER LANDSCAPE Fire Protection: Soils Engineer:

Master Site Plan


Project Number: Drawn by: 11/10/22 Date: Revision:

DAWSON CANYON ROAD

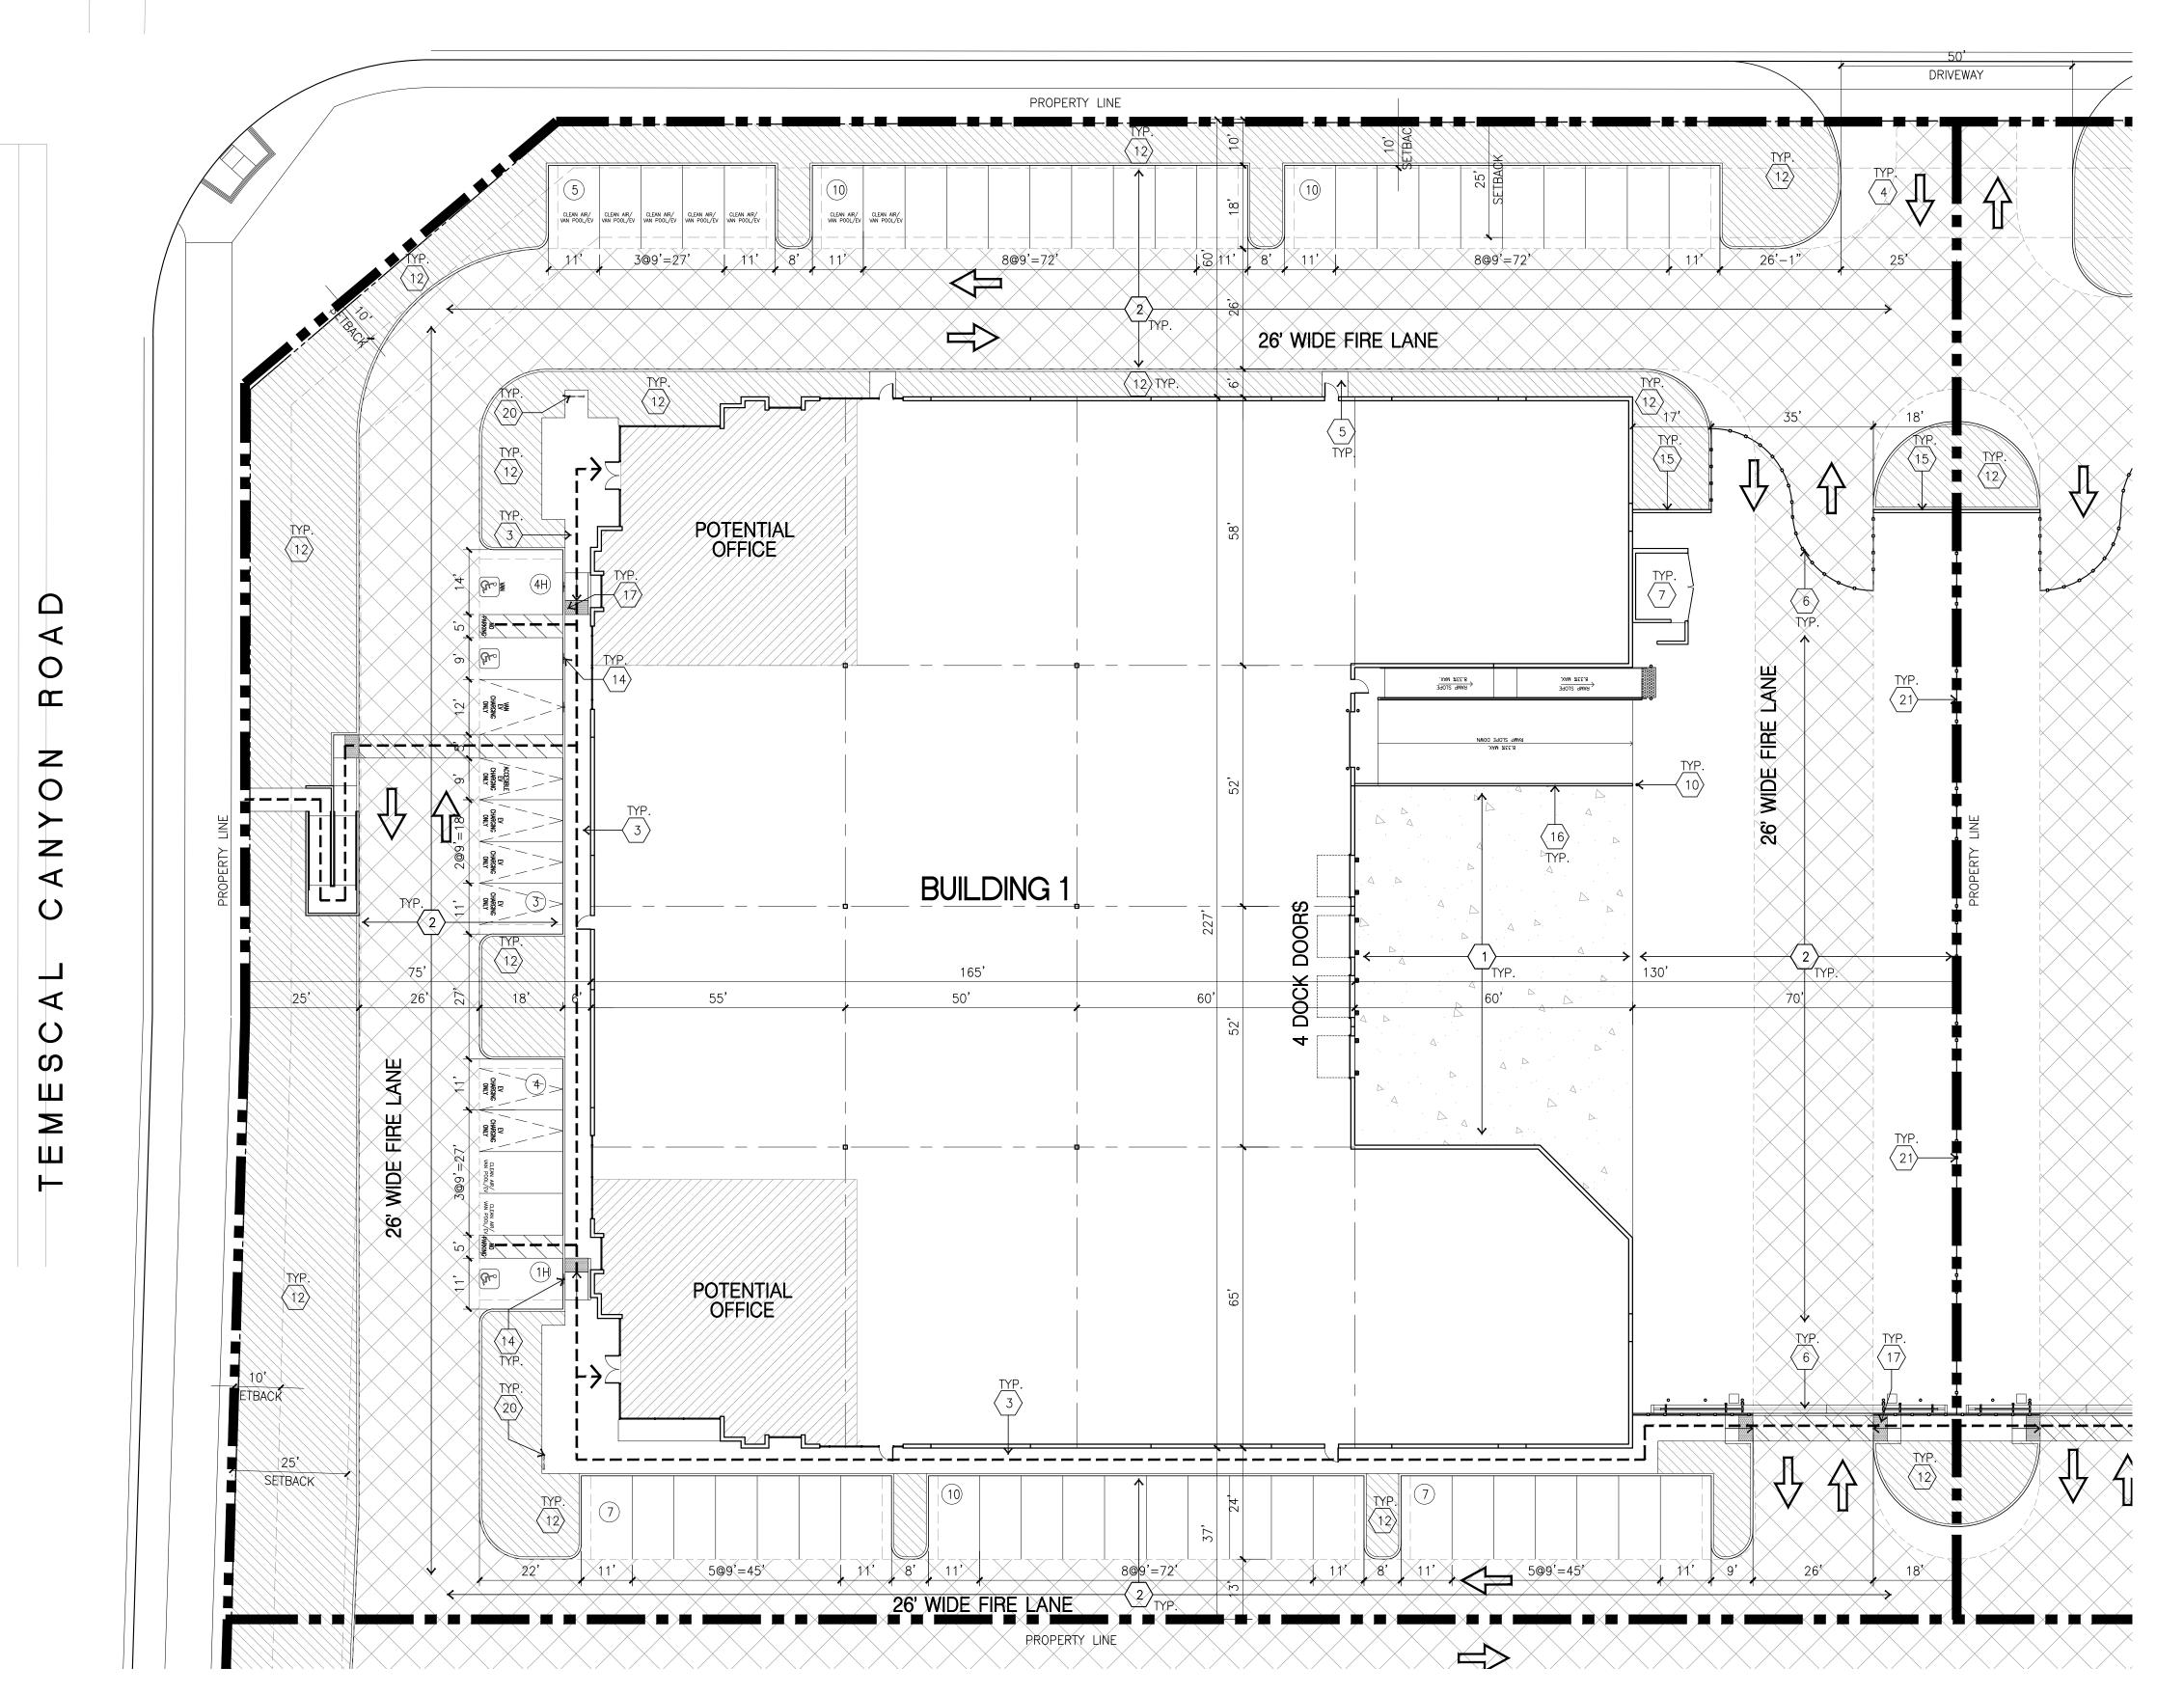

OVERALL SITE PLAN
scale: 1" = 20'-0"



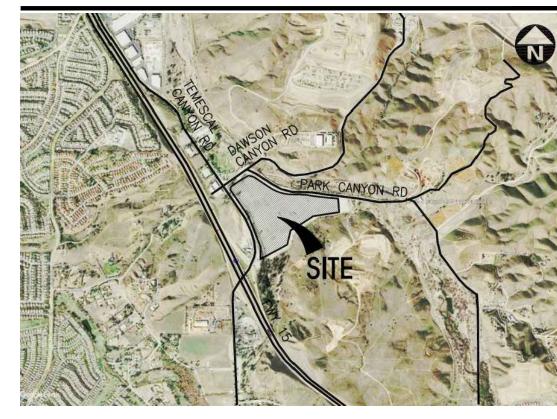

PROJECT INFORMATION

Code Analysis Construction Type 2019 CALIFORNIA BUILDING CODE CONCRETE TILT-UP BUILDING 2019 CALIFORNIA PLUMBING CODE 2019 CALIFORNIA MECHANICAL CODE 2019 CALIFORNIA ELECTRICAL CODE 2019 CALIFORNIA FIRE CODE

BUILDING OCCUPANCY : S-1 / B CONSTRUCTION TYPE : III-B 2019 CALIFORNIA GREEN BUILDING STANDARDS CODE FIRE SPRINKLER BUILDING

APN

Applicant's Representatives HPA, INC. 18831 BARDEEN AVE., SUITE 100 IRVINE, CA 92612 (949) 862-2161 (949) 863-0851

2019 CALIFORNIA ENERGY CODE

283-160-046 283-190-044 CONTACT: ANDY WIYANTO

INCOMPLETE. IT IS MEANT AS A COMPARATIVE AID IN EXAMINING

ALTERNATE DEVELOPMENT STRATEGIES AND ANY QUANTITIES

INDICATED ARE SUBJECT TO REVISION AS MORE RELIABLE

THIS IS A CONCEPTUAL PLAN. IT IS BASED ON PRELIMINARY INFORMATION WHICH IS NOT FULLY VERIFIED AND MAY BE

LEGAL DESCRIPTION

INFORMATION BECOMES AVAILABLE.

THE LAND REFERRED TO IN THIS COMMITMENT IS SITUATED IN THE UNINCORPORATED AREA OF THE COUNTY OF RIVERSIDE, STATE OF CALIFORNIA, AND IS DESCRIBED AS FOLLOWS:

PARCEL 2 OF NOTICE OF LOT LINE ADJUSTMENT NO. LLA200028, RECORDED JUNE 21, 2021 AS INSTRUMENT NO. 2021-0373323 OF OFFICIAL RECORDS OF RIVERSIDE COUNTY, CALIFORNIA, BEING THOSE PORTIONS OF THE LAND DESCRIBED IN PARCELS 6, 7 AND 8 OF "CORPORATION GRANT DEED", IN THE EAST HALF OF THE NORTHEAST QUARTER OF SECTION 34, TOWNSHIP 4 SOUTH, RANGE 6 WEST AND THE NORTHWEST QUARTER OF SECTION 35, TOWNSHIP 4 SOUTH, RANGE 6 WEST, SAN BERNARDINO MERIDIAN, IN THE UNINCORPORATED TERRITORY OF THE COUNTY OF RIVERSIDE, STATE OF CALIFORNIA, RECORDED JUNE 30, 1987 AS INSTRUMENT NO. 186951, OF OFFICIAL RECORDS OF SAID COUNTY, BOUNDED AS FOLLOWS:

ON THE NORTHWEST BY THE SOUTHEASTERLY LINE OF DAWSON CANYON ROAD AS DESCRIBED IN PARCEL 1 OF "CORPORATION QUITCLAIM DEED", RECORDED MAY 03, 2002 AS DOCUMENT NO. 2002-236679, OF OFFICIAL RECORDS OF SAID COUNTY;

AND BOUNDED EASTERLY BY THE FOLLOWING DESCRIBED LINE: COMMENCING AT THE WESTERLY TERMINUS OF THAT CERTAIN MOST SOUTHERLY LINE OF SAID PARCEL 6, DESCRIBED AS HAVING A BEARING AND DISTANCE OF "NORTH 89" 51' 27" EAST, 840.06 FEET", SAID WESTERLY TERMINUS ALSO BEING ON THE EASTERLY LINE OF TEMESCAL CANYON ROAD (40.00 FEET HALF-WIDE) AS SHOWN ON PARCEL MAP NO. 31196, AS PER MAP FILED IN BOOK 208, PAGES 50 THROUGH 53, INCLUSIVE OF PARCEL MAPS, IN THE OFFICE OF THE COUNTY RECORDER OF SAID COUNTY; THENCE ALONG SAID MOST SOUTHERLY LINE OF PARCEL 6, NORTH 89' 51' 27" EAST, 586.31 FEET TO A POINT ON THE MOST SOUTHERLY LINE OF SAID PARCEL 8, SAID POINT BEING THE TRUE POINT OF BEGINNING, THENCE NORTH 27" 54' 55" EAST 499.99 FEET TO THE BEGINNING OF A TANGENT CURVE, CONCAVE WESTERLY AND HAVING A RADIUS OF 1080.00 FEET; THENCE NORTHERLY ALONG SAID CURVE, THROUGH A CENTRAL ANGLE OF 31° 44' 51", AN ARC LENGTH OF 598.43 FEET; THENCE TANGENT TO SAID CURVE, NORTH 03' 46' 59" WEST 269.31 FEET TO A POINT ON THAT CERTAIN NORTHERLY CURVED LINE OF SAID PARCEL 8 DESCRIBED AS HAVING A RADIUS OF 700.00 FEET AND A LENGTH OF 143.85 FEET,

APN: PORTIONS OF APNS 283-160-046 AND 283-190-044

SAID POINT BEING THE END POINT OF THIS DESCRIPTION.

TABULATION

Side/Rear - None

	BLDG. 1
SITE AREA	
In s.f.	119,790
In acres	2.75
BUILDING AREA	
Office	3,500
Mezzanine	3,500
Warehouse	40,665
TOTAL	47,665
COVERAGE	36.9%
CLEARANCE	28'
AUTO PARKING REQUIRED	
Office: 1/250 s.f.	28
Warehouse: 1/2,000 s.f.	20
TOTAL	48
AUTO PARKING STALLS PROVIDED	
Standard (9' x 18')	42
Accessible Parking (9' x 18')	2
Accessible Van Parking (12' x 18')	1
EV Standard (9' x 18')	5
EV Accessible (9' x 18')	1
EV Van Accessible (12' x 18')	1
EV Ambulatory	
Clean Air Vehicle (9' x 18')	9
TOTAL	61
TRAILER PARKING PROVIDED	
Trailer (10' x 55')	
ZONING ORDINANCE FOR COUNTY	
M-M Manufacturing Medium	
M-R-A Mineral Resources and Related Manufacturing	
MAXIMUM BUILDING HEIGHT ALLOWED	
Height - 50'	
MAXIMUM FLOOR AREA RATIO	
FAR (Total gross area/site):	39.8%
LANDSCAPE REQUIREMENT	
Required landscape area (10%):	11,979
Provided area:	14,519
SETBACKS	
Building	Landscape
Street Front - 25'	10'

SITE PLAN KEYNOTES

- \langle 1 angle HEAVY BROOM FINISH CONCRETE PAVEMENT.
- \langle 2 \rangle ASPHALT CONCRETE (AC) PAVING.
- 3 CONCRETE WALKWAY, MEDIUM BROOM FINISH.
- \langle 4 \rangle driveway aprons to be constructed per civil drawings.
- \langle 5 \rangle 5'-6" x 5'-6" x 4" THICK CONCRETE EXTERIOR LANDING PAD TYP. AT ALL EXTERIOR MAN DOORS TO LANDSCAPED AREAS. FINISH TO BE MEDIUM BROOM
- \ PROVIDE 8' HIGH METAL GATES W/ KNOX-BOX PER FIRE DEPARTMENT
- / STANDARDS PER DRIVEWAY. \langle 7 \rangle Trash enclosure per city standard.
- \langle 8 angle APPROXIMATE LOCATION OF TRANSFORMER.
- \langle 9 \rangle PRE-CAST CONCRETE WHEEL STOP.
- $\langle 10 \rangle$ concrete filled guard post "6 dia. u.n.o. at 42" h.
- (11) DESIGNATED SMOKING AREA.
- $\langle 12 \rangle$ LANDSCAPE. ALL LANDSCAPE AREAS INDICATED BY SHADING.
- (14) ACCESSIBLE PARKING STALL SIGN.
- \langle 15 \rangle 14'-0" SCREEN WALL

3) MONUMENT SIGN.

- \langle 16angle42" HIGH CONCRETE GUARDWALL.
- $\langle 17 \rangle$ TRUNCATED DOME.
- $\langle 18 \rangle$ NOT USED. (19) EXTERIOR CONCRETE STAIR WITH GUARDWALL AND HANDRAIL
- \langle 20 \rangle EXTERIOR BIKE RACK.
- $\langle 21 \rangle$ 8' HIGH METAL FENCE

SITE PLAN GENERAL NOTES

- 1. THE SITE PLAN BASED ON THE SOILS REPORT PREPARED BY:
- 2. IF SOILS ARE EXPANSIVE IN NATURE, USE STEEL REINFORCING FOR ALL SITE CONCRETE.
- 3. ALL DIMENSIONS ARE TO THE FACE OF CONCRETE WALL, FACE OF CONCRETE CURB OR GRID LINE U.N.O.
- 4. SEE "C" PLANS FOR ALL CONCRETE CURBS, GUTTERS AND SWALES. 5. THE ENTIRE PROJECT SHALL BE PERMANENTLY MAINTAINED WITH AN AUTOMATIC IRRIGATION SYSTEM.
- 6. SEE "C" DRAWINGS FOR POINT OF CONNECTIONS TO OFF-SITE UTILITIES. CONTRACTOR SHALL VERIFY ACTUAL UTILITY LOCATIONS.
- 7. PROVIDE POSITIVE DRAINAGE AWAY FROM BLDG. SEE "C" DRAWINGS.
- 8. CONTRACTOR TO REFER TO "C" DRAWINGS FOR ALL HORIZONTAL CONTROL DIMENSIONS. SITE PLANS ARE FOR GUIDANCE AND STARTING LAYOUT POINTS.
- 9. SEE "C"DRAWINGS FOR FINISH GRADE ELEVATIONS.
- 10. CONCRETE SIDEWALKS TO BE A MINIMUM OF 4" THICK W/ TOOLED JOINTS AT 6' O.C. EXPANSION/CONSTRUCTION JOINTS SHALL BE A MAXIMUM 12' EA. WAY.
- EXPANSION JOINTS TO HAVE COMPRESSIVE EXPANSION FILLER MATERIAL OF 1/4". FINISH TO BE A MEDIUM BROOM FINISH U.N.O.
- 11. PAINT CURBS AND PROVIDE SIGNS TO INFORM OF FIRE LANES AS REQUIRED BY FIRE DEPARTMENT.
- 12. CONSTRUCTION DOCUMENTS PERTAINING TO THE LANDSCAPE AND IRRIGATION OF THE ENTIRE PROJECT SITE SHALL BE SUBMITTED TO THE BUILDING DEPARTMENT AND APPROVED BY PUBLIC FACILITIES DEVELOPMENT PRIOR TO ISSUANCE OF
- 13. PRIOR TO FINAL CITY INSPECTION, THE LANDSCAPE ARCHITECT SHALL SUBMIT A CERTIFICATE OF COMPLETION TO PUBLIC FACILITIES DEVELOPMENT.
- 14. ALL LANDSCAPE AND IRRIGATION DESIGNS SHALL MEET CURRENT CITY STANDARDS AS LISTED IN GUIDELINES OR AS OBTAINED FROM PUBLIC FACILITIES
- 15. LANDSCAPED AREAS SHALL BE DELINEATED WITH A MINIMUM SIX INCHES (6") HIGH CURB.

SITE LEGEND


LANDSCAPED AREA SEE "C" DRWGS. FOR THICKNESS PATH OF TRAVEL ASPHALT CONCRETE PAVING _____ SEE "C" DRWGS. FOR THICKNESS 26' WIDE FIRELANE EXISTING PUBLIC FIRE HYDRANT STANDARD PARKING
STALL W/ 2' OVERHANG PRIVATE FIRE HYDRANT-APPROXIMATE LOCATION ACCESSIBLE PARKING (VAN) STALL (12' X 18') + 5' W/
ACCESSIBLE AISLE ACCESSIBLE PARKING STALL (9' X 18') + 5' ////// W/ ACCESSIBLE AISLE EV PARKING CLEAN AIR/VANPOOL/EV

> (PROVIDE CONDUIT FOR **FUTURE EV CHARGING)**

EV AMBULATORY PARKING

_____ STALL (10' X 18')

KEY MAP

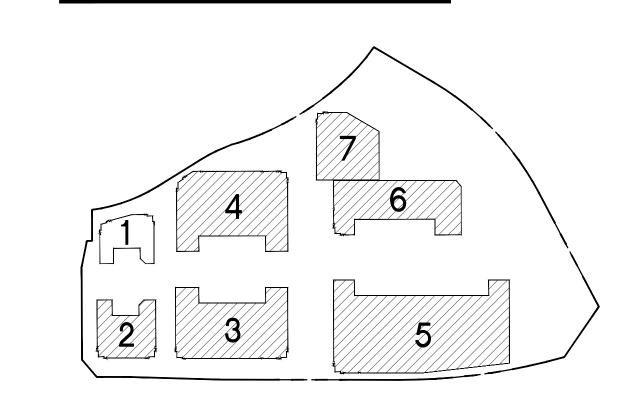



hpa, inc. 18831 bardeen avenue - ste. #100 irvine, ca tel: 949 •863 •1770 fax: 949 • 863 • 0851 email: hpa@hparchs.com



Owner: DAWSON CANYON LLC.

11777 San Vicente Blvd, Ste. 780 Los Angeles, CA 90049 tel: (949) 296-7006 fax: (949) 842-3074



TEMESCAL VALLEY COMMERCE CENTER

> DAWSON CANYON RD. CORONA, CA 92883



THIENES Structural:

Plumbing: Electrical: Landscape: HUNTER LANDSCAPE


Mechanical:

Fire Protection:

DCW3 Soils Engineer:

Overall site plan

Project Number: Drawn by: Date: Revision:

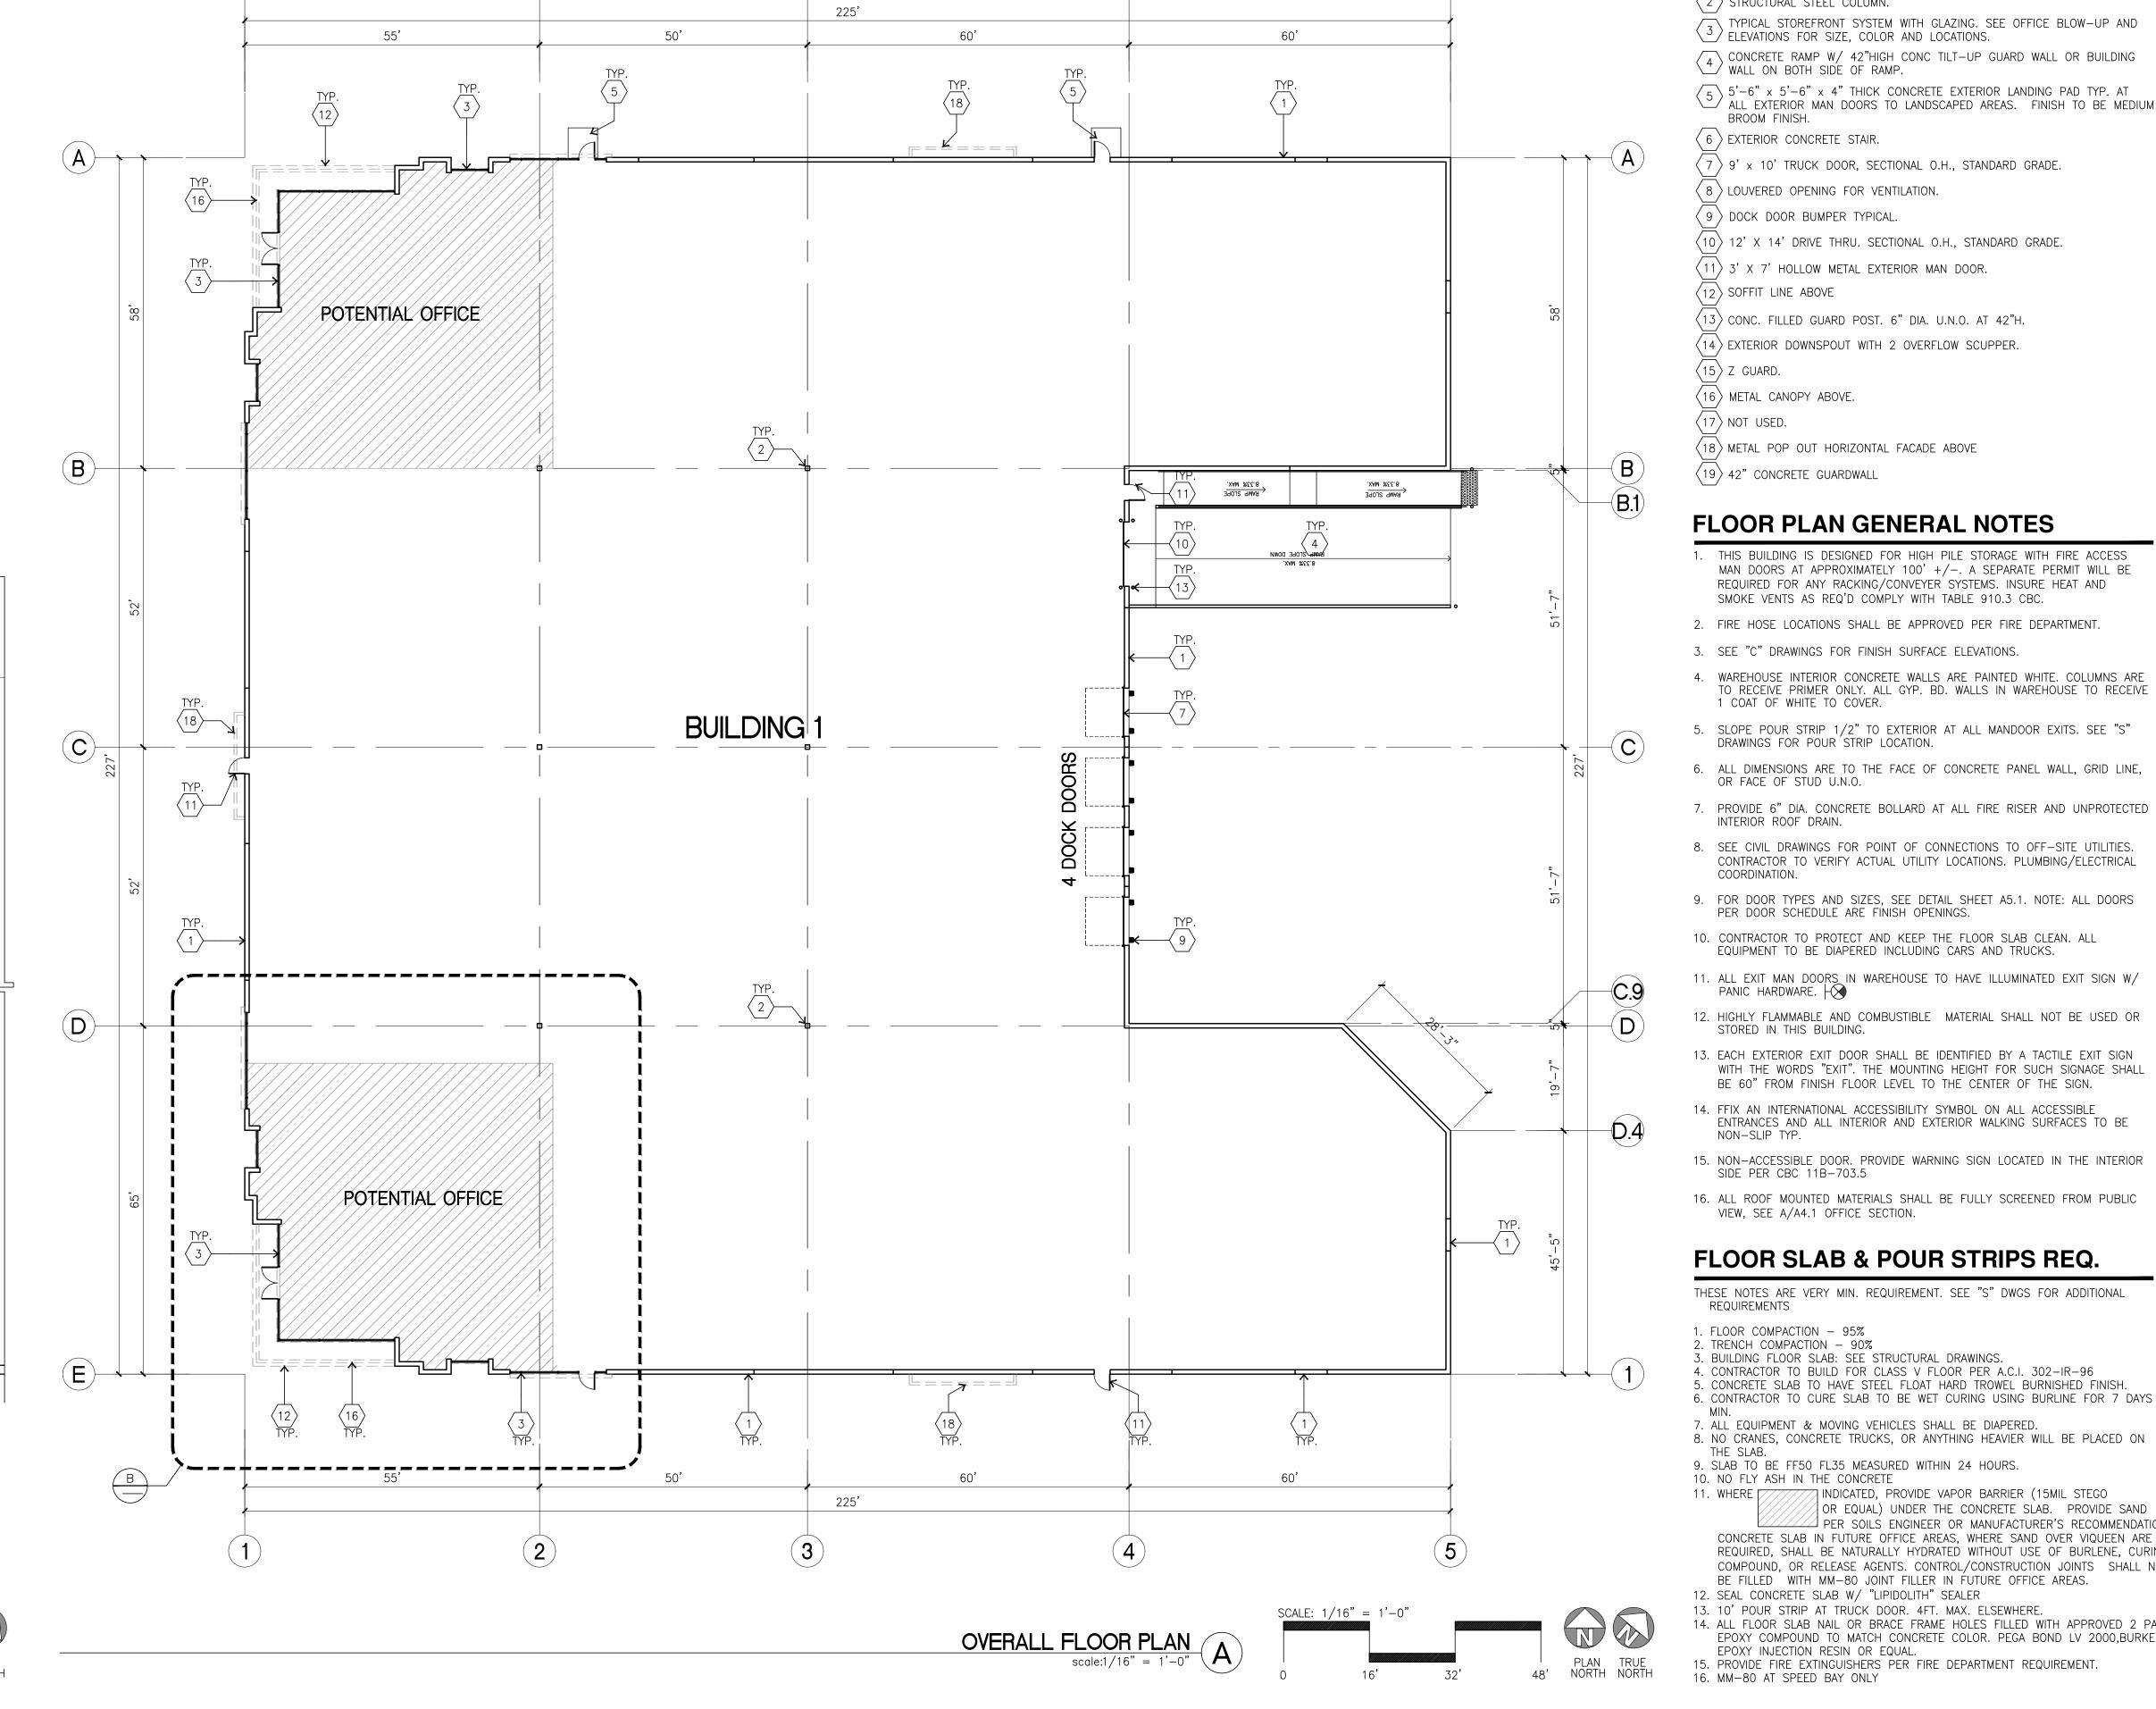

+ ~ ~ +

(16)—

POTENTIAL OFFICE

6'-2"

FLOOR PLAN KEYNOTES

 $\langle 1 \rangle$ CONCRETE TILT-UP PANEL.

 $\langle 2 \rangle$ STRUCTURAL STEEL COLUMN.

TYPICAL STOREFRONT SYSTEM WITH GLAZING. SEE OFFICE BLOW-UP AND $\stackrel{3}{\longrightarrow}$ ELEVATIONS FOR SIZE, COLOR AND LOCATIONS. CONCRETE RAMP W/ 42"HIGH CONC TILT-UP GUARD WALL OR BUILDING WALL ON BOTH SIDE OF RAMP.

5 5'-6" x 5'-6" x 4" THICK CONCRETE EXTERIOR LANDING PAD TYP. AT ALL EXTERIOR MAN DOORS TO LANDSCAPED AREAS. FINISH TO BE MEDIUM

BROOM FINISH. $\langle 6 \rangle$ EXTERIOR CONCRETE STAIR.

 $\langle 7 \rangle$ 9' x 10' TRUCK DOOR, SECTIONAL O.H., STANDARD GRADE.

 $\langle 8 \rangle$ LOUVERED OPENING FOR VENTILATION.

(9) DOCK DOOR BUMPER TYPICAL. (10) 12' X 14' DRIVE THRU. SECTIONAL O.H., STANDARD GRADE.

 $\langle 11 \rangle$ 3' X 7' HOLLOW METAL EXTERIOR MAN DOOR.

 $\langle 13 \rangle$ conc. Filled guard post. 6" dia. u.n.o. at 42"h.

 $\langle 14 \rangle$ EXTERIOR DOWNSPOUT WITH 2 OVERFLOW SCUPPER.

 $\langle 15 \rangle$ Z GUARD.

 $\langle 16 \rangle$ METAL CANOPY ABOVE.

 $\langle 17 \rangle$ NOT USED.

(18) METAL POP OUT HORIZONTAL FACADE ABOVE

FLOOR PLAN GENERAL NOTES

1. THIS BUILDING IS DESIGNED FOR HIGH PILE STORAGE WITH FIRE ACCESS MAN DOORS AT APPROXIMATELY 100' +/-. A SEPARATE PERMIT WILL BE REQUIRED FOR ANY RACKING/CONVEYER SYSTEMS. INSURE HEAT AND SMOKE VENTS AS REQ'D COMPLY WITH TABLE 910.3 CBC.

2. FIRE HOSE LOCATIONS SHALL BE APPROVED PER FIRE DEPARTMENT.

3. SEE "C" DRAWINGS FOR FINISH SURFACE ELEVATIONS.

4. WAREHOUSE INTERIOR CONCRETE WALLS ARE PAINTED WHITE. COLUMNS ARE TO RECEIVE PRIMER ONLY. ALL GYP. BD. WALLS IN WAREHOUSE TO RECEIVE 1 COAT OF WHITE TO COVER.

5. SLOPE POUR STRIP 1/2" TO EXTERIOR AT ALL MANDOOR EXITS. SEE "S" DRAWINGS FOR POUR STRIP LOCATION.

6. ALL DIMENSIONS ARE TO THE FACE OF CONCRETE PANEL WALL, GRID LINE, OR FACE OF STUD U.N.O.

INTERIOR ROOF DRAIN. 8. SEE CIVIL DRAWINGS FOR POINT OF CONNECTIONS TO OFF-SITE UTILITIES. CONTRACTOR TO VERIFY ACTUAL UTILITY LOCATIONS. PLUMBING/ELECTRICAL

9. FOR DOOR TYPES AND SIZES, SEE DETAIL SHEET A5.1. NOTE: ALL DOORS PER DOOR SCHEDULE ARE FINISH OPENINGS.

10. CONTRACTOR TO PROTECT AND KEEP THE FLOOR SLAB CLEAN. ALL EQUIPMENT TO BE DIAPERED INCLUDING CARS AND TRUCKS.

11. ALL EXIT MAN DOORS IN WAREHOUSE TO HAVE ILLUMINATED EXIT SIGN W/PANIC HARDWARE. -12. HIGHLY FLAMMABLE AND COMBUSTIBLE MATERIAL SHALL NOT BE USED OR

STORED IN THIS BUILDING. 13. EACH EXTERIOR EXIT DOOR SHALL BE IDENTIFIED BY A TACTILE EXIT SIGN WITH THE WORDS "EXIT". THE MOUNTING HEIGHT FOR SUCH SIGNAGE SHALL

BE 60" FROM FINISH FLOOR LEVEL TO THE CENTER OF THE SIGN. 14. FFIX AN INTERNATIONAL ACCESSIBILITY SYMBOL ON ALL ACCESSIBLE ENTRANCES AND ALL INTERIOR AND EXTERIOR WALKING SURFACES TO BE

15. NON-ACCESSIBLE DOOR. PROVIDE WARNING SIGN LOCATED IN THE INTERIOR SIDE PER CBC 11B-703.5

16. ALL ROOF MOUNTED MATERIALS SHALL BE FULLY SCREENED FROM PUBLIC VIEW, SEE A/A4.1 OFFICE SECTION.

FLOOR SLAB & POUR STRIPS REQ.

THESE NOTES ARE VERY MIN. REQUIREMENT. SEE "S" DWGS FOR ADDITIONAL

1. FLOOR COMPACTION - 95%

2. TRENCH COMPACTION - 90% 3. BUILDING FLOOR SLAB: SEE STRUCTURAL DRAWINGS. 4. CONTRACTOR TO BUILD FOR CLASS V FLOOR PER A.C.I. 302-IR-96

5. CONCRETE SLAB TO HAVE STEEL FLOAT HARD TROWEL BURNISHED FINISH. 6. CONTRACTOR TO CURE SLAB TO BE WET CURING USING BURLINE FOR 7 DAYS

7. ALL EQUIPMENT & MOVING VEHICLES SHALL BE DIAPERED. 8. NO CRANES, CONCRETE TRUCKS, OR ANYTHING HEAVIER WILL BE PLACED ON

THE SLAB. 9. SLAB TO BE FF50 FL35 MEASURED WITHIN 24 HOURS.

10. NO FLY ASH IN THE CONCRETE 11. WHERE ///// INDICATED, PROVIDE VAPOR BARRIER (15MIL STEGO OR EQUAL) UNDER THE CONCRETE SLAB. PROVIDE SAND PER SOILS ENGINEER OR MANUFACTURER'S RECOMMENDATION. CONCRETE SLAB IN FUTURE OFFICE AREAS, WHERE SAND OVER VIQUEEN ARE REQUIRED, SHALL BE NATURALLY HYDRATED WITHOUT USE OF BURLENE, CURING COMPOUND, OR RELEASE AGENTS. CONTROL/CONSTRUCTION JOINTS SHALL NOT

12. SEAL CONCRETE SLAB W/ "LIPIDOLITH" SEALER 13. 10' POUR STRIP AT TRUCK DOOR. 4FT. MAX. ELSEWHERE. 14. ALL FLOOR SLAB NAIL OR BRACE FRAME HOLES FILLED WITH APPROVED 2 PART EPOXY COMPOUND TO MATCH CONCRETE COLOR. PEGA BOND LV 2000,BURKE

EPOXY INJECTION RESIN OR EQUAL. 15. PROVIDE FIRE EXTINGUISHERS PER FIRE DEPARTMENT REQUIREMENT.



hpa, inc. 18831 bardeen avenue - ste. #100 irvine, ca tel: 949 •863 •1770 fax: 949 • 863 • 0851 email: hpa@hparchs.com



11777 San Vicente Blvd, Ste. 780 Los Angeles, CA 90049 tel: (949) 296-7006 fax: (949) 842-3074

TEMESCAL VALLEY COMMERCE CENTER

> DAWSON CANYON RD. CORONA, CA 92883



THIENES Structural: Mechanical: TBD Plumbing: TBD Electrical: Landscape: HUNTER LANDSCAPE Fire Protection:


DCW3


Title: Overall Floor plan

Project Number: Drawn by: 11/10/22 Date:

Revision:

Soils Engineer:

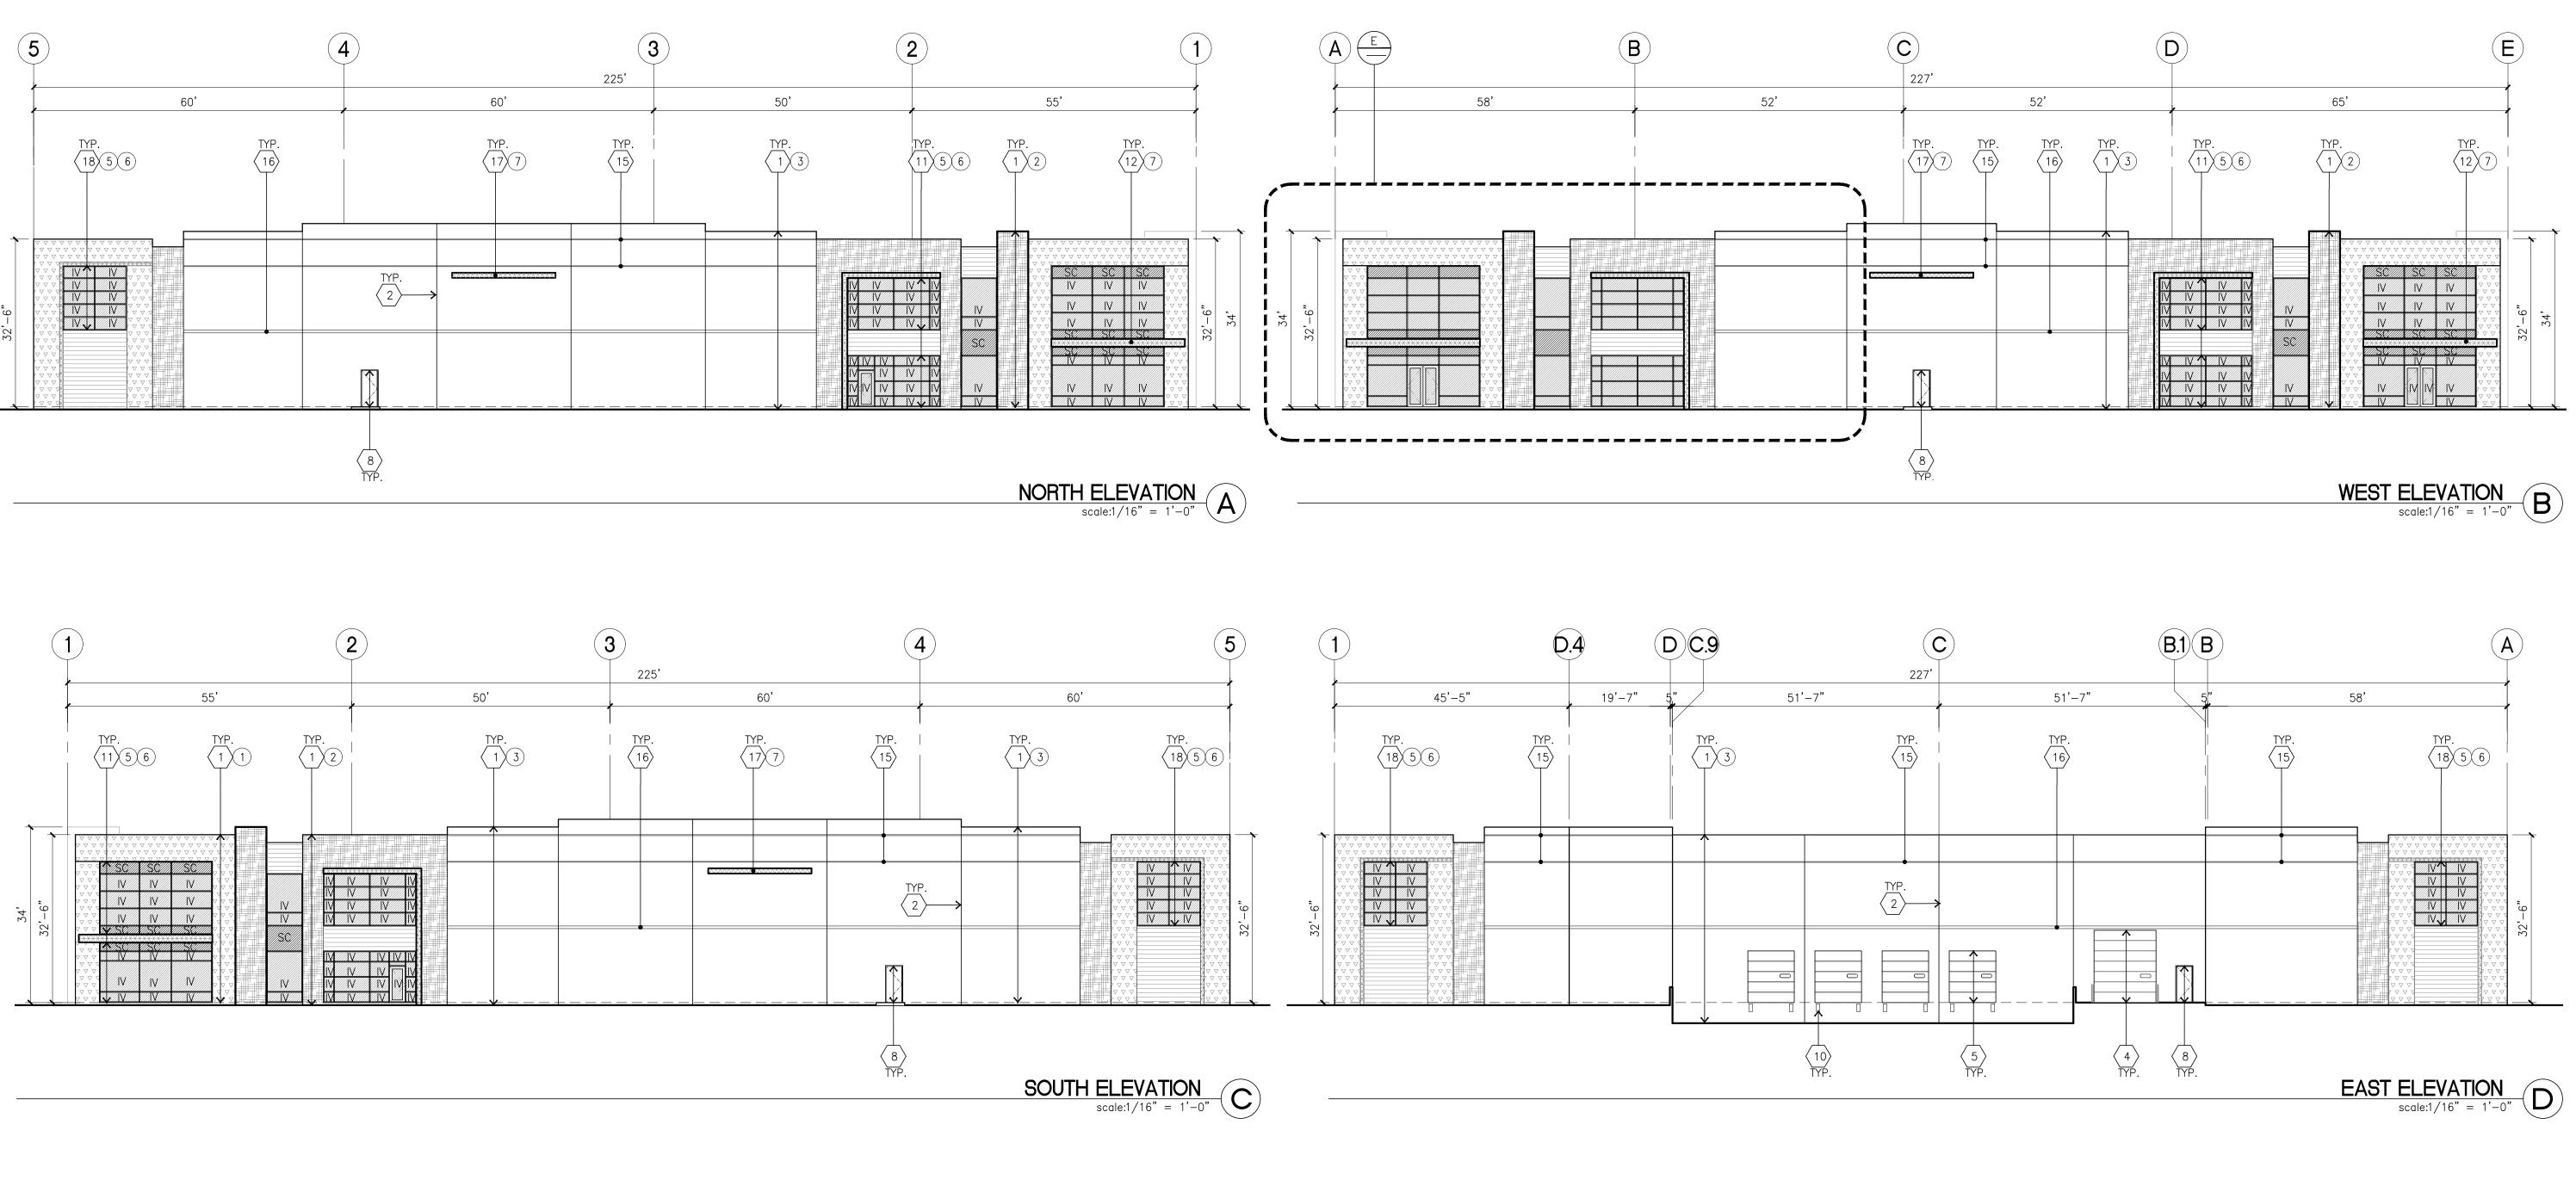

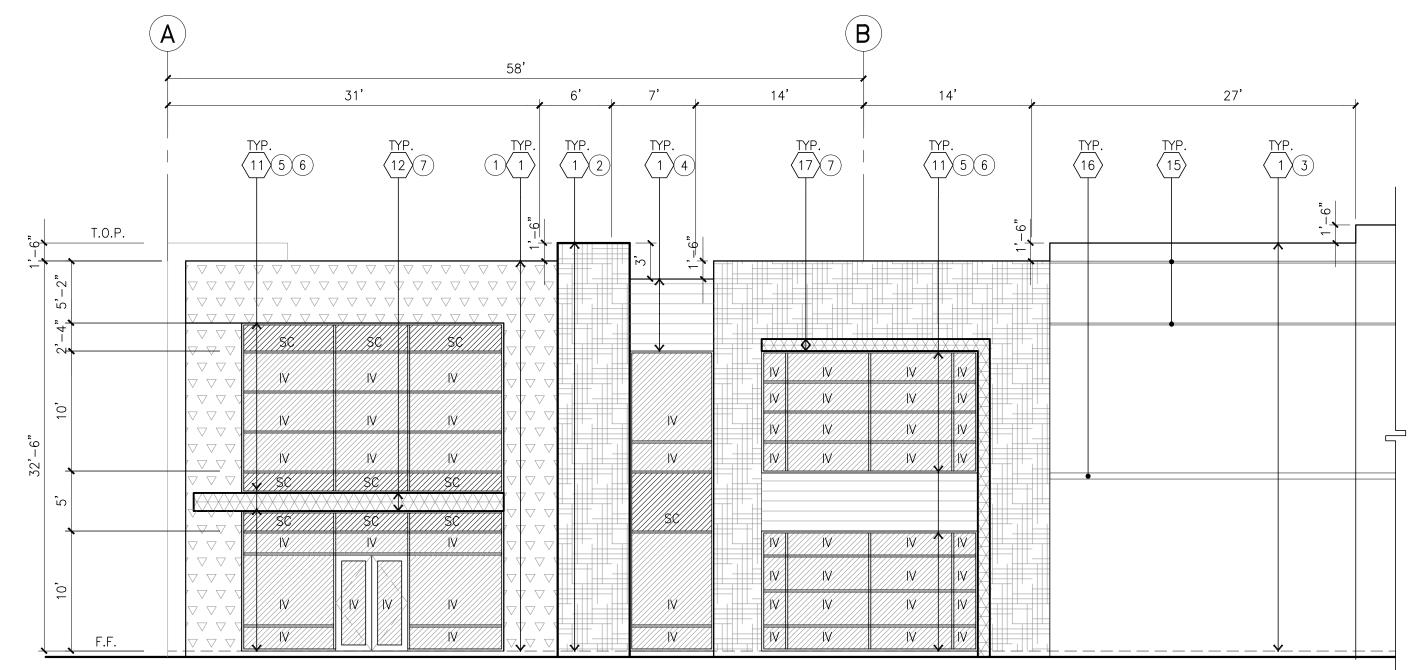

ENLARGED WEST ELEVATION

scale: 1/8" = 1'-0"

ELEVATION KEYNOTES

 \langle 1 \rangle CONCRETE TILT-UP PANEL.

 $\langle 2 \rangle$ PANEL JOINT.

 $\langle 3 \rangle$ NOT USED.

12' X 14' OVERHEAD DOOR @ DRIVE THRU. PROVIDE COMPLETE ✓ WEATHER—STRIPPING PROTECTION ALL AROUND.

9' X 10' OVERHEAD DOOR @ DRIVE THRU. PROVIDE COMPLETE WEATHER-STRIPPING PROTECTION ALL AROUND.

6 CONCRETE STAIR, LANDING AND GUARDRAIL W/ METAL PIPE HANDRAIL. PROVIDE NON SKID NOSING TO MEET ADA REQUIREMENTS. PROVIDE CONTRASTING COLORED 3" WIDE WARNING STRIPE INTEGRAL TO CONCRETE AT TOP LANDING AND BOTTOM TREAD PER ADA REQUIREMENTS. $\sqrt{}$ 4' X 8' METAL LOUVER OPENING FOR VENTILATION. PAINT TO MATCH

/ BUILDING COLOR. \ HOLLOW METAL DOORS. PROVIDE COMPLETE WEATHER STRIPING ALL

AROUND DOOR.

9 EXTERIOR DOWN SPOUTS W/ 2 OVERFLOW SCUPPERS.

 $0 \, \rangle$ DOCK DOOR BUMPER TYPICAL. ALUMINUM STOREFRONT FRAMING WITH TEMPERED GLAZING AT ALL DOORS, $^\prime$ SIDELITES ADJACENT TO DOORS AND GLAZING WITH BOTTOMS LESS THAN 18" ABOVE FINISH FLOOR ELEVATION.

2 METAL CANOPY.

3 INTERIOR ROOF DRAIN W/ 2 OVERFLOW SCUPPERS.

 $\langle 14 \rangle$ CONC. FILLED GUARD POST. 6" DIA. U.N.O. AT 42"H. 2" HORIZONTAL REVEAL WITH 3/8" CHAMFER. REVEAL COLOR TO MATCH ADJACENT BUILDING FIELD COLOR. U.N.O.

6" HORIZONTAL REVEAL WITH 3/8" CHAMFER. REVEAL COLOR TO MATCH ADJACENT BUILDING FIELD COLOR. U.N.O. 7 METAL POP OUT HORIZONTAL FACADE ABOVE

(18) ALUMINUM STOREFRONT FRAMING WITH GLAZING

ELEVATION GENERAL NOTES

1. ALL PAINT COLOR CHANGES TO OCCUR AT INSIDE CORNERS UNLESS NOTED

2. ALL PAINT FINISHES ARE TO BE FLAT UNLESS NOTED OTHERWISE.

3. T.O.P. EL.= TOP OF PARAPET ELEVATION.

4. F.F. = FINISH FLOOR ELEVATION.

5. STOREFRONT CONSTRUCTION: GLASS, METAL ATTACHMENTS AND LINTELS SHALL BE DESIGNED TO RESIST - MPH. EXPOSURE "C" WINDS. CONTRACTOR SHALL SUBMIT SHOP DRAWINGS PRIOR TO INSTALLATION.

6. CONTRACTOR SHALL FULLY PAINT ONE CONCRETE PANEL W/ SELECTED COLORS. ARCHITECT AND OWNER SHALL APPROVE PRIOR TO PAINTING REMAINDER OF BUILDING.

7. BACK SIDE OF PARAPETS TO HAVE SMOOTH FINISH AND BE PAINTED WITH 8. FOR SPANDREL GLAZING, ALLOW SPACE BEHIND SPANDREL TO BREATH.

PROVIDE 1" DIAMETER HOLES AT CONCRETE WALL. 9. USE ADHESIVE BACK WOOD STRIPS FOR ALL REVEAL FORMS.

10. THE FIRST COAT OF PAINT TO BE ROLLED-ON AND THE SECOND COAT TO BE SPRAYED-ON

11. ALL ROLL-UP DOORS AND SERVICE DOORS TO BE PAINTED TO MATCH BUILDING COLOR.

ELEVATION COLOR LEGEND/SCHED.

PAINT. COLOR: SW 7525 TREE BRANCH (288C7) PAINT. COLOR: SW 7638 JOGGING PATH (247-C2)

PAINT. COLOR: SW 9166 DRIFT OF MIST (238-C2) PAINT. COLOR: SW METAL PANEL - LONGBOARD LIGHT BAMBOO

MULLIONS COLOR : CLEAR ANODIZED

6 GLAZING COLOR : BLUE REFLECTIVE

METAL CANOPY WITH DUNN EDWARDS DEA 160 HOPE CHEST

GLAZING LEGEND

NOTE: ALL EXTERIOR AND INTERIOR GLAZING SHALL BE TEMPERED.

SPANDREL GLASS
WITH CONCRETE BEHIND ///// INSULATED VISION GLASS

SINGLE LITE VISION GLASS

IV : INSULATED VISION GLASS
1/4" VISTACOOL PACIFICA + 1/4" SOLARBAN 60 CLEAR 1" INSULATED GLASS UNIT WITH 1/2" AIRSPACE AND 1/4" LITES U: 0.27 SHGC: 0.21 VLT: 26% MINIMUM VT TO BE 0.42 PER 2016 CEC TABLE 140.3—B

SC: SPANDREL WITH CONCRETE BEHIND 1/4" VISTACOOL PACIFICA WITH WARM GRAY OPACICOAT PAINTED ON REFLECTIVE. INSTALLED ON CONCRETE.

V : VISION GLASS 1/4" VISTACOOL PACIFICA

MULLIONS : ANODIZED CLEAR.



hpa, inc. 18831 bardeen avenue - ste. #100 irvine, ca tel: 949 •863 •1770 fax: 949 • 863 • 0851 email: hpa@hparchs.com

Owner: DAWSON CANYON LLC.

11777 San Vicente Blvd, Ste. 780 Los Angeles, CA 90049 tel: (949) 296-7006 fax: (949) 842-3074

TEMESCAL VALLEY COMMERCE CENTER

DAWSON CANYON RD.

CORONA, CA 92883

THIENES Structural: TBD Mechanical: TBD Plumbing: TBD


Landscape: HUNTER LANDSCAPE Fire Protection: DCW3 Soils Engineer:

Electrical:

Title: Elevations

Project Number: Drawn by: 11/10/22

Date: Revision:

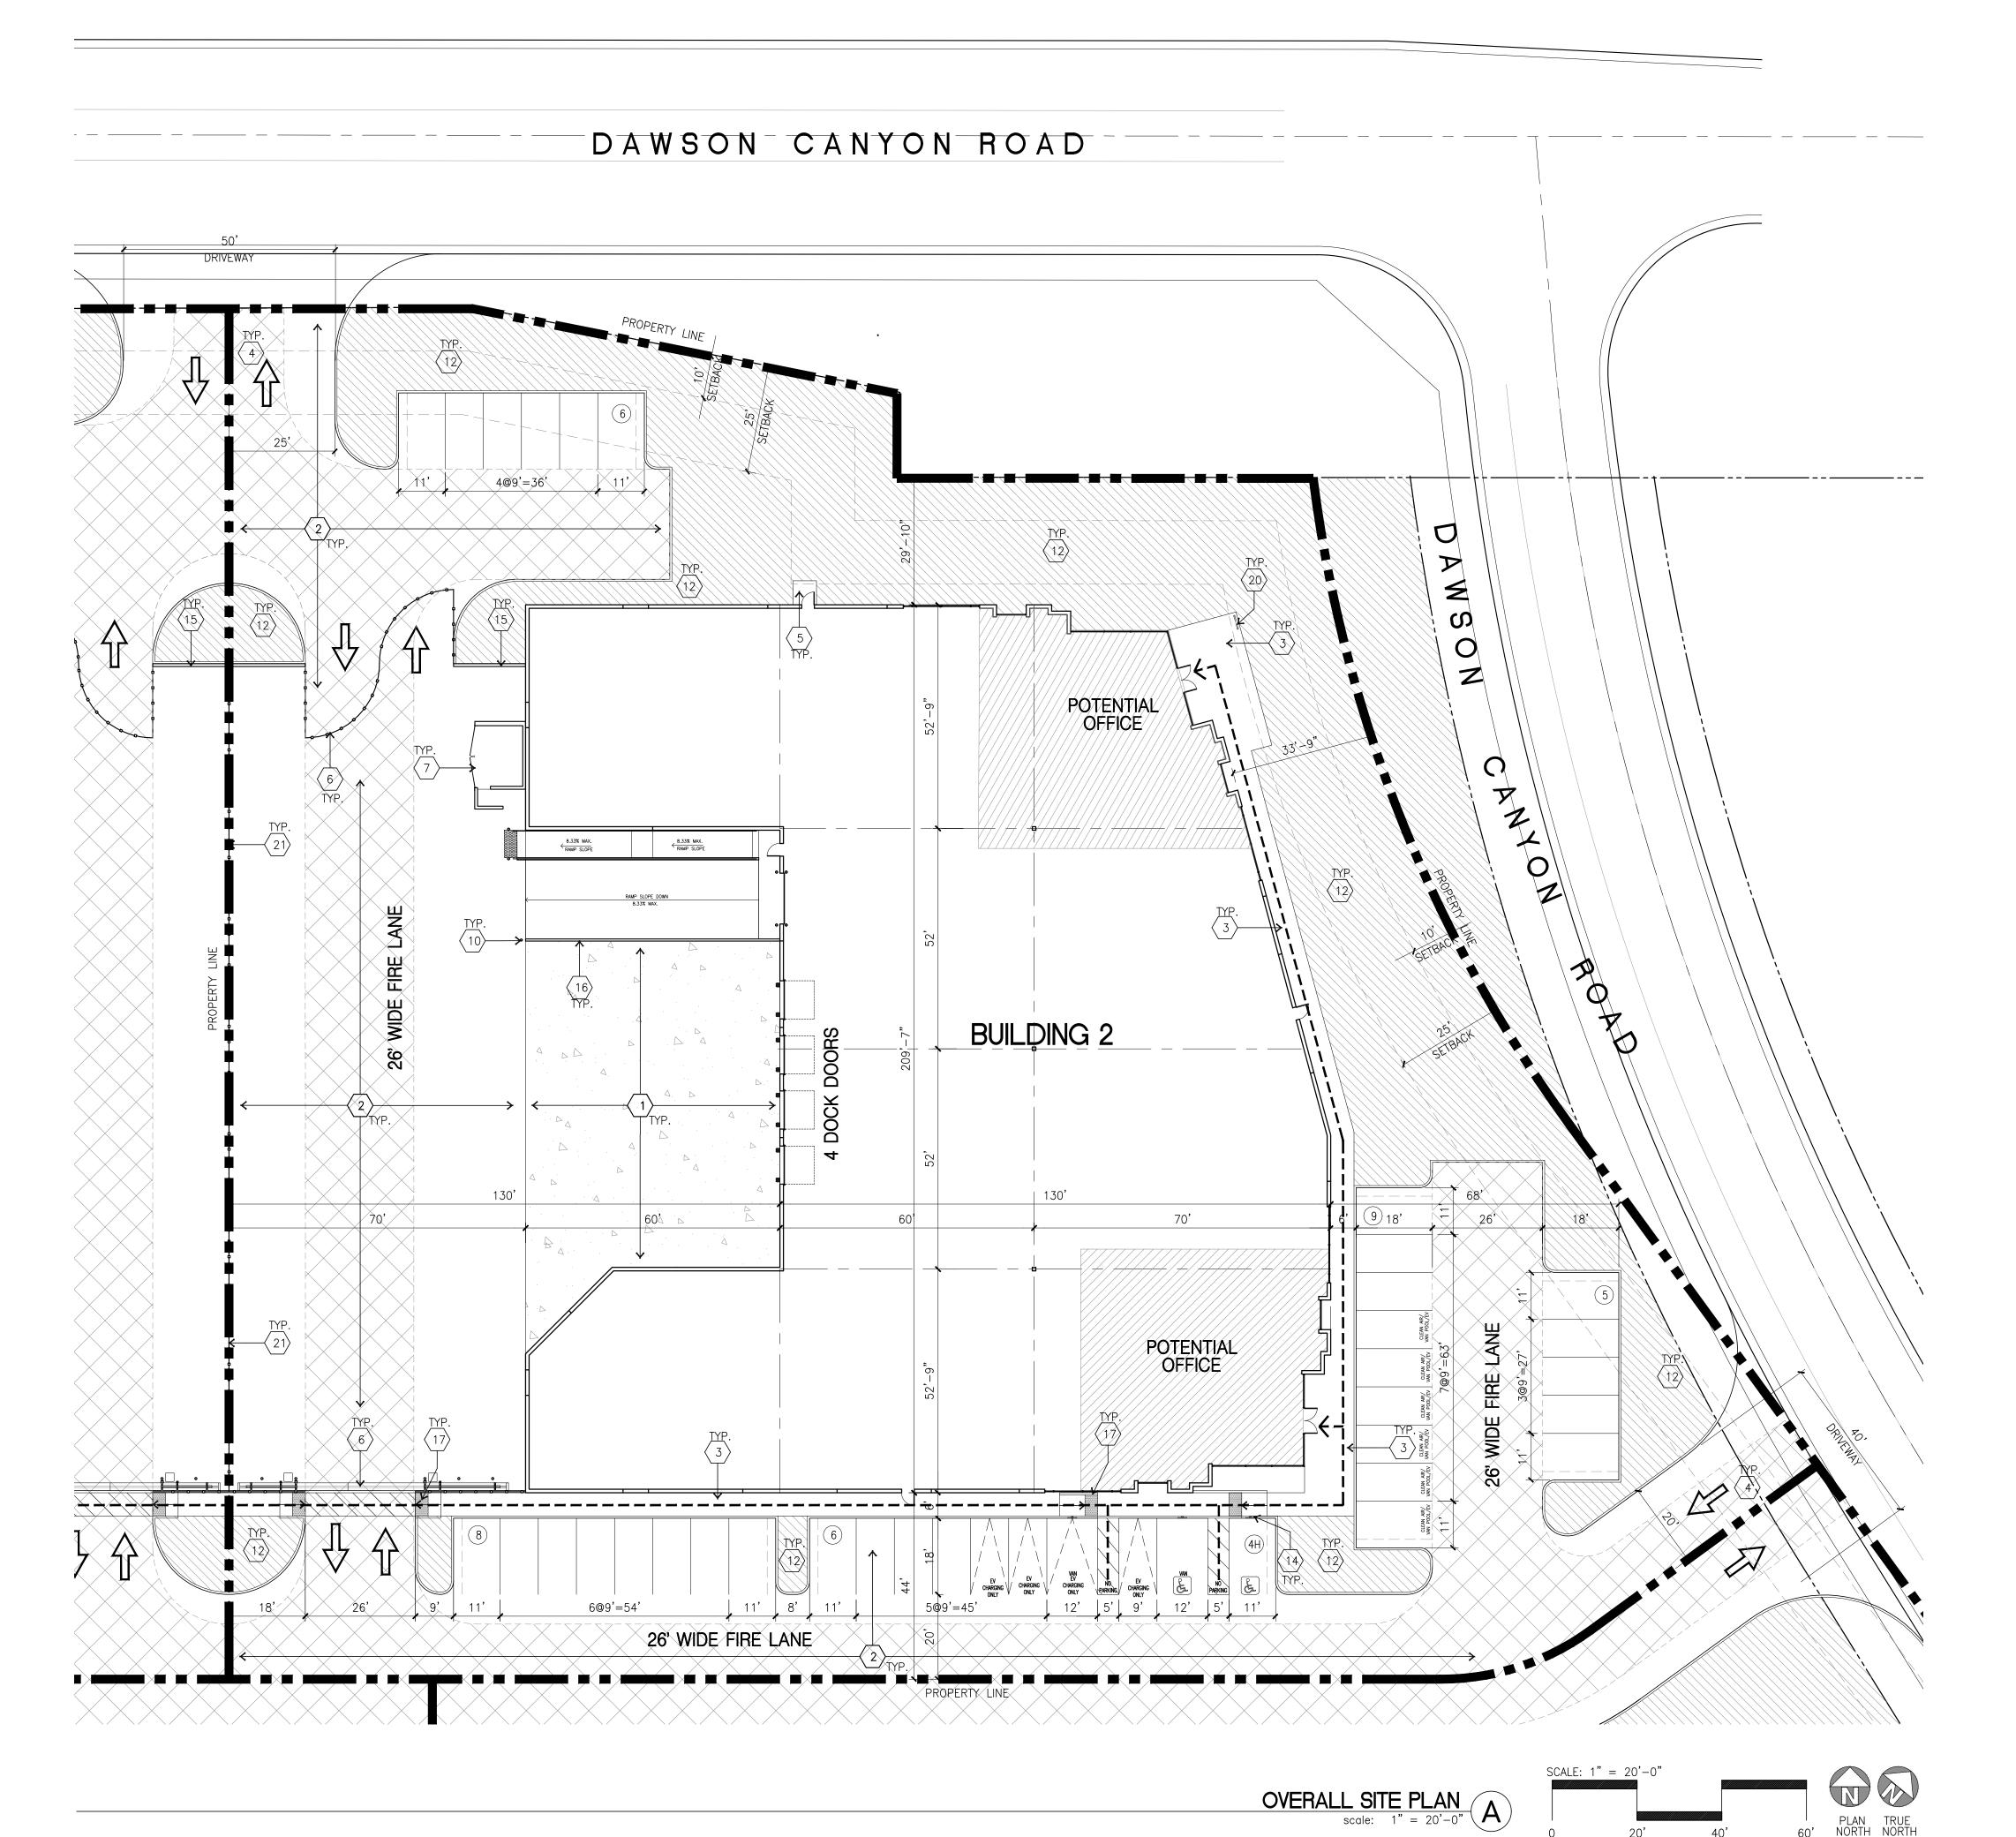

AERIAL MAP



PROJECT INFORMATION

Code Analysis 2019 CALIFORNIA BUILDING CODE 2019 CALIFORNIA PLUMBING CODE 2019 CALIFORNIA MECHANICAL CODE 2019 CALIFORNIA ELECTRICAL CODE 2019 CALIFORNIA FIRE CODE 2019 CALIFORNIA GREEN BUILDING STANDARDS CODE 2019 CALIFORNIA ENERGY CODE

BUILDING OCCUPANCY : S-1 / B CONSTRUCTION TYPE : III-B FIRE SPRINKLER BUILDING

283-160-046

283-190-044

Construction Type

CONCRETE TILT-UP BUILDING

HPA, INC. 18831 BARDEEN AVE., SUITE 100 IRVINE, CA 92612 (949) 862-2161(949) 863-0851 CONTACT: ANDY WIYANTO

Applicant's Representatives

THIS IS A CONCEPTUAL PLAN. IT IS BASED ON PRELIMINARY INFORMATION WHICH IS NOT FULLY VERIFIED AND MAY BE INCOMPLETE. IT IS MEANT AS A COMPARATIVE AID IN EXAMINING ALTERNATE DEVELOPMENT STRATEGIES AND ANY QUANTITIES INDICATED ARE SUBJECT TO REVISION AS MORE RELIABLE

LEGAL DESCRIPTION

INFORMATION BECOMES AVAILABLE.

THE LAND REFERRED TO IN THIS COMMITMENT IS SITUATED IN THE UNINCORPORATED AREA OF THE COUNTY OF RIVERSIDE, STATE OF CALIFORNIA, AND IS DESCRIBED AS FOLLOWS:

PARCEL 2 OF NOTICE OF LOT LINE ADJUSTMENT NO. LLA200028, RECORDED JUNE 21, 2021 AS INSTRUMENT NO. 2021—0373323 OF OFFICIAL RECORDS OF RIVERSIDE COUNTY, CALIFORNIA, BEING THOSE PORTIONS OF THE LAND DESCRIBED IN PARCELS 6, 7 AND 8 OF "CORPORATION GRANT DEED", IN THE EAST HALF OF THE NORTHEAST QUARTER OF SECTION 34, TOWNSHIP 4 SOUTH, RANGE 6 WEST AND THE NORTHWEST QUARTER OF SECTION 35, TOWNSHIP 4 SOUTH, RANGE 6 WEST, SAN BERNARDINO MERIDIAN, IN THE UNINCORPORATED TERRITORY OF THE COUNTY OF RIVERSIDE, STATE OF CALIFORNIA, RECORDED JUNE 30, 1987 AS INSTRUMENT NO. 186951, OF OFFICIAL RECORDS OF SAID COUNTY, BOUNDED AS FOLLOWS:

ON THE NORTHWEST BY THE SOUTHEASTERLY LINE OF DAWSON CANYON ROAD AS DESCRIBED IN PARCEL 1 OF "CORPORATION QUITCLAIM DEED", RECORDED MAY 03, 2002 AS DOCUMENT NO. 2002-236679, OF OFFICIAL RECORDS OF SAID COUNTY;

AND BOUNDED EASTERLY BY THE FOLLOWING DESCRIBED LINE: COMMENCING AT THE WESTERLY TERMINUS OF THAT CERTAIN MOST SOUTHERLY LINE OF SAID PARCEL 6, DESCRIBED AS HAVING A BEARING AND DISTANCE OF "NORTH 89" 51' 27" EAST, 840.06 FEET", SAID WESTERLY TERMINUS ALSO BEING ON THE EASTERLY LINE OF TEMESCAL CANYON ROAD (40.00 FEET HALF-WIDE) AS SHOWN ON PARCEL MAP NO. 31196, AS PER MAP FILED IN BOOK 208, PAGES 50 THROUGH 53, INCLUSIVE OF PARCEL MAPS, IN THE OFFICE OF THE COUNTY RECORDER OF SAID COUNTY; THENCE ALONG SAID MOST SOUTHERLY LINE OF PARCEL 6, NORTH 89' 51' 27" EAST, 586.31 FEET TO A POINT ON THE MOST SOUTHERLY LINE OF SAID PARCEL 8, SAID POINT BEING THE TRUE POINT OF BEGINNING; THENCE NORTH 27" 54' 55" EAST 499.99 FEET TO THE BEGINNING OF A TANGENT CURVE, CONCAVE WESTERLY AND HAVING A RADIUS OF 1080.00 FEET; THENCE NORTHERLY ALONG SAID CURVE, THROUGH A CENTRAL ANGLE OF 31" 44' 51", AN ARC LENGTH OF 598.43 FEET; THENCE TANGENT TO SAID CURVE, NORTH 03' 46' 59" WEST 269.31 FEET TO A POINT ON THAT CERTAIN NORTHERLY CURVED LINE OF SAID PARCEL 8 DESCRIBED AS HAVING A RADIUS OF 700.00 FEET AND A LENGTH OF 143.85 FEET, SAID POINT BEING THE END POINT OF THIS DESCRIPTION.

TABULATION

APN: PORTIONS OF APNS 283-160-046 AND 283-190-044

	BLDG.
SITE AREA	
In s.f.	94,56
In acres	2.17
BUILDING AREA	
Office	3,00
Mezzanine	3,00
Warehouse	27,82
TOTAL	33,82
COVERAGE	32.69
CLEARANCE	2
AUTO PARKING REQUIRED	
Office: 1/250 s.f.	2
Warehouse: 1/2,000 s.f.	1
TOTAL	3
AUTO PARKING STALLS PROVIDED	
Standard (9' x 18')	2
Accessible Parking (9' x 18')	
Accessible Van Parking (12' x 18')	
EV Standard (9' x 18')	
EV Accessible (9'x 18')	
EV Van Accessible (12' x 18')	
EV Ambulatory	
Clean Air Vehicle (9' x 18')	
TOTAL	3
TRAILER PARKING PROVIDED	
Trailer (10' x 55')	
ZONING ORDINANCE FOR COUNTY	
M-M Manufacturing Medium	
M-R-A Mineral Resources and Related Manufacturing	
MAXIMUM BUILDING HEIGHT ALLOWED	
Height - 50'	
MAXIMUM FLOOR AREA RATIO	
FAR (Total gross area/site):	35.89
LANDSCAPE REQUIREMENT	
Required landscape area (10%):	9,45
Provided area:	18,10
SETBACKS	
Building	
Street Front - 25'	
	I

Side/Rear - None

SITE PLAN KEYNOTES

- \langle 1 angle HEAVY BROOM FINISH CONCRETE PAVEMENT. \langle 2 \rangle ASPHALT CONCRETE (AC) PAVING. (3) CONCRETE WALKWAY, MEDIUM BROOM FINISH.
 - \langle 4 angle driveway aprons to be constructed per civil drawings.
 - \langle 5 \rangle 5'-6" x 5'-6" x 4" THICK CONCRETE EXTERIOR LANDING PAD TYP. AT ALL $^{\prime}$ EXTERIOR MAN DOORS TO LANDSCAPED AREAS. FINISH TO BE MEDIUM BROOM
 - PROVIDE 8' HIGH METAL GATES W/ KNOX-BOX PER FIRE DEPARTMENT / STANDARDS PER DRIVEWAY.
 - \langle 7 \rangle TRASH ENCLOSURE PER CITY STANDARD.
 - \langle 8 angle APPROXIMATE LOCATION OF TRANSFORMER.
 - \langle 9 \rangle PRE-CAST CONCRETE WHEEL STOP.
 - $\langle 10
 angle$ concrete filled guard post "6 dia. u.n.o. at 42" h. \langle 11 \rangle DESIGNATED SMOKING AREA.

 - (12) LANDSCAPE. ALL LANDSCAPE AREAS INDICATED BY SHADING.
 - (13) MONUMENT SIGN. (14) ACCESSIBLE PARKING STALL SIGN.
 - $\langle 15 \rangle 14'-0"$ SCREEN WALL
 - (16) 42" HIGH CONCRETE GUARDWALL.
 - $\langle 17 \rangle$ TRUNCATED DOME.
 - $\langle 18 \rangle$ NOT USED. (19) EXTERIOR CONCRETE STAIR WITH GUARDWALL AND HANDRAIL
 - $\langle 20 \rangle$ EXTERIOR BIKE RACK.
 - $\langle 21 \rangle$ 8' HIGH METAL FENCE

SITE PLAN GENERAL NOTES

- 1. THE SITE PLAN BASED ON THE SOILS REPORT PREPARED BY:
- 2. IF SOILS ARE EXPANSIVE IN NATURE, USE STEEL REINFORCING FOR ALL SITE
- 3. ALL DIMENSIONS ARE TO THE FACE OF CONCRETE WALL, FACE OF CONCRETE CURB OR GRID LINE U.N.O.
- 4. SEE "C" PLANS FOR ALL CONCRETE CURBS, GUTTERS AND SWALES.
- 5. THE ENTIRE PROJECT SHALL BE PERMANENTLY MAINTAINED WITH AN AUTOMATIC IRRIGATION SYSTEM.
- 6. SEE "C" DRAWINGS FOR POINT OF CONNECTIONS TO OFF-SITE UTILITIES. CONTRACTOR SHALL VERIFY ACTUAL UTILITY LOCATIONS.
- 7. PROVIDE POSITIVE DRAINAGE AWAY FROM BLDG. SEE "C" DRAWINGS.
- 8. CONTRACTOR TO REFER TO "C" DRAWINGS FOR ALL HORIZONTAL CONTROL DIMENSIONS. SITE PLANS ARE FOR GUIDANCE AND STARTING LAYOUT POINTS.
- 9. SEE "C"DRAWINGS FOR FINISH GRADE ELEVATIONS. 10. CONCRETE SIDEWALKS TO BE A MINIMUM OF 4" THICK W/ TOOLED JOINTS AT 6'
- O.C. EXPANSION/CONSTRUCTION JOINTS SHALL BE A MAXIMUM 12' EA. WAY. EXPANSION JOINTS TO HAVE COMPRESSIVE EXPANSION FILLER MATERIAL OF 1/4". FINISH TO BE A MEDIUM BROOM FINISH U.N.O.
- 11. PAINT CURBS AND PROVIDE SIGNS TO INFORM OF FIRE LANES AS REQUIRED BY FIRE DEPARTMENT. 12. CONSTRUCTION DOCUMENTS PERTAINING TO THE LANDSCAPE AND IRRIGATION OF THE ENTIRE PROJECT SITE SHALL BE SUBMITTED TO THE BUILDING DEPARTMENT
- AND APPROVED BY PUBLIC FACILITIES DEVELOPMENT PRIOR TO ISSUANCE OF
- 13. PRIOR TO FINAL CITY INSPECTION, THE LANDSCAPE ARCHITECT SHALL SUBMIT A CERTIFICATE OF COMPLETION TO PUBLIC FACILITIES DEVELOPMENT. 14. ALL LANDSCAPE AND IRRIGATION DESIGNS SHALL MEET CURRENT CITY
- STANDARDS AS LISTED IN GUIDELINES OR AS OBTAINED FROM PUBLIC FACILITIES
- 15. LANDSCAPED AREAS SHALL BE DELINEATED WITH A MINIMUM SIX INCHES (6")

SITE LEGEND


LANDSCAPED AREA SEE "C" DRWGS. FOR THICKNESS PATH OF TRAVEL ASPHALT CONCRETE PAVING SEE "C" DRWGS. FOR THICKNESS 26' WIDE FIRELANE EXISTING PUBLIC FIRE HYDRANT STANDARD PARKING STALL W/ 2'OVERHANG PRIVATE FIRE HYDRANT-APPROXIMATE LOCATION ACCESSIBLE PARKING (VAN) STALL (12' X 18') + 5' W/ACCESSIBLE AISLE ACCESSIBLE PARKING STALL (9' X 18') + 5' ///// W/ ACCESSIBLE AISLE EV PARKING CLEAN AIR/VANPOOL/EV

> (PROVIDE CONDUIT FOR **FUTURE EV CHARGING)**

EV AMBULATORY PARKING

_____ STALL (10' X 18')

KEY MAP

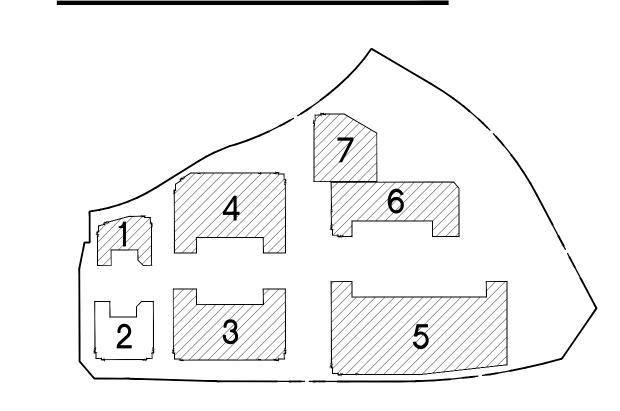



hpa, inc. 18831 bardeen avenue - ste. #100 irvine, ca tel: 949 •863 •1770 fax: 949 • 863 • 0851 email: hpa@hparchs.com



Owner: DAWSON CANYON LLC.

11777 San Vicente Blvd, Ste. 780 Los Angeles, CA 90049 tel: (949) 296-7006 fax: (949) 842-3074



TEMESCAL VALLEY

COMMERCE CENTER

DAWSON CANYON RD. CORONA, CA 92883

Consultants:

THIENES


Mechanical Plumbing: Electrical:


Structural:

Landscape: HUNTER LANDSCAPE Fire Protection: DCW3

Overall site plan

Project Number: Drawn by: 11/10/22 Date: Revision:

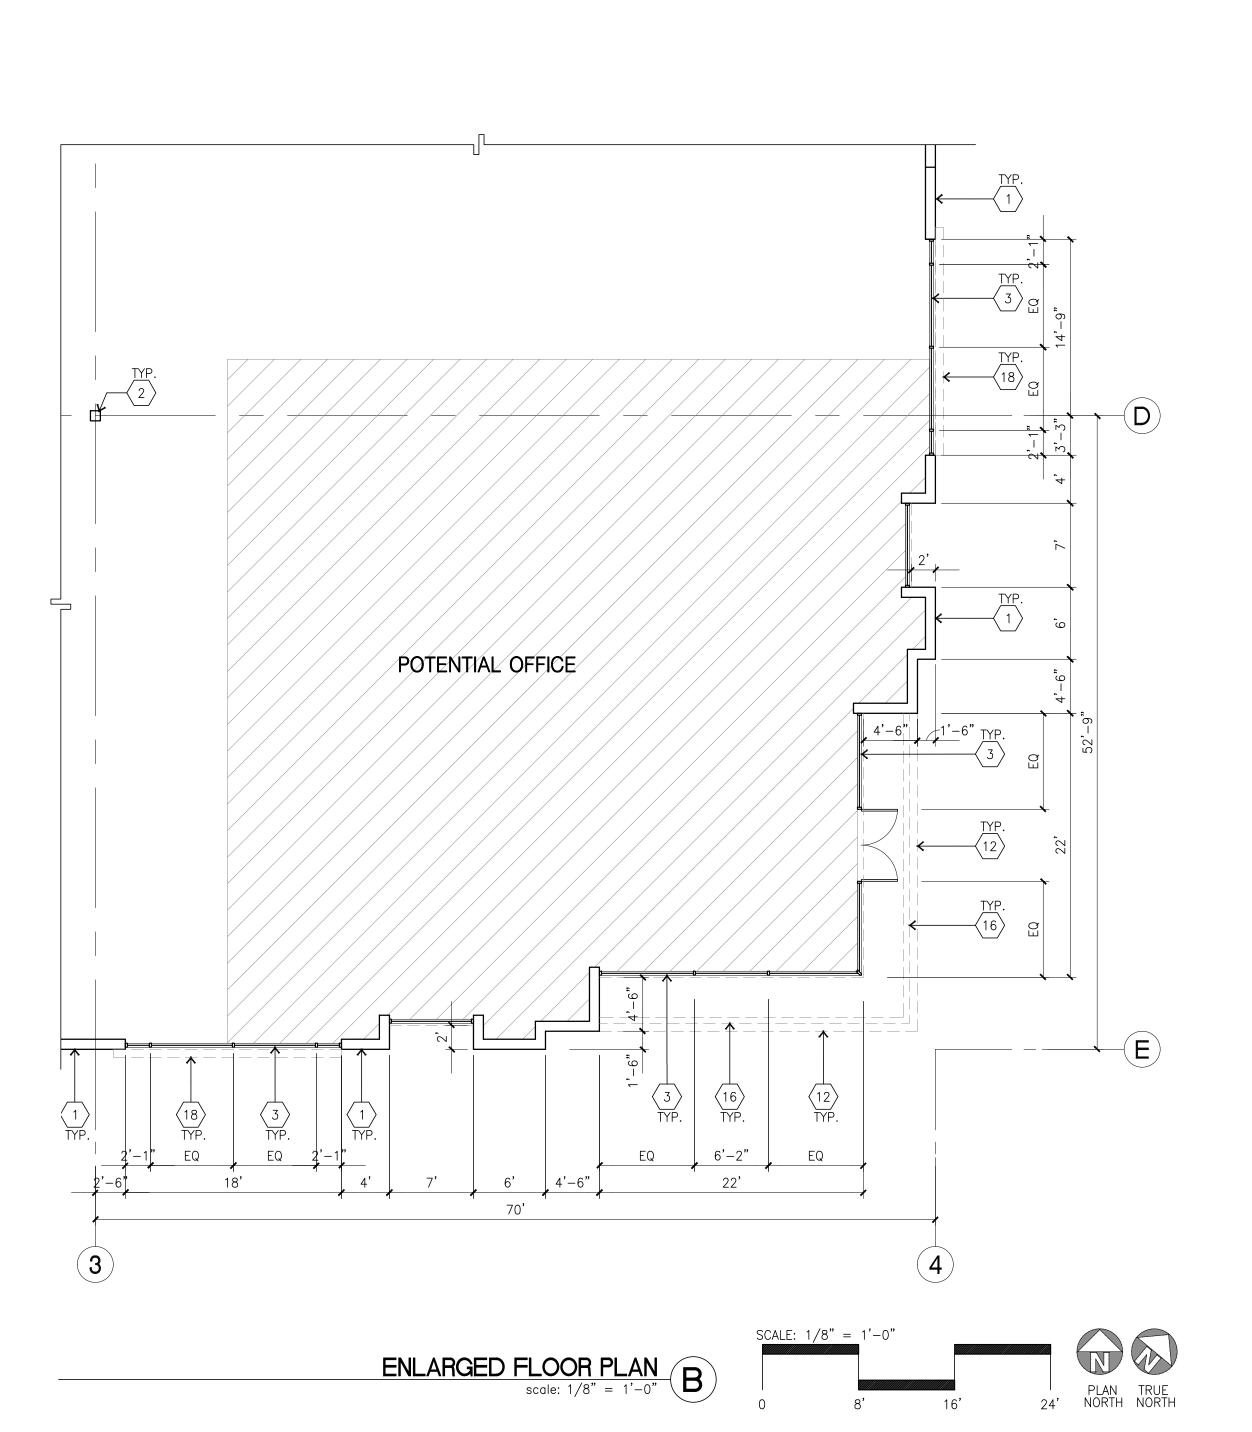

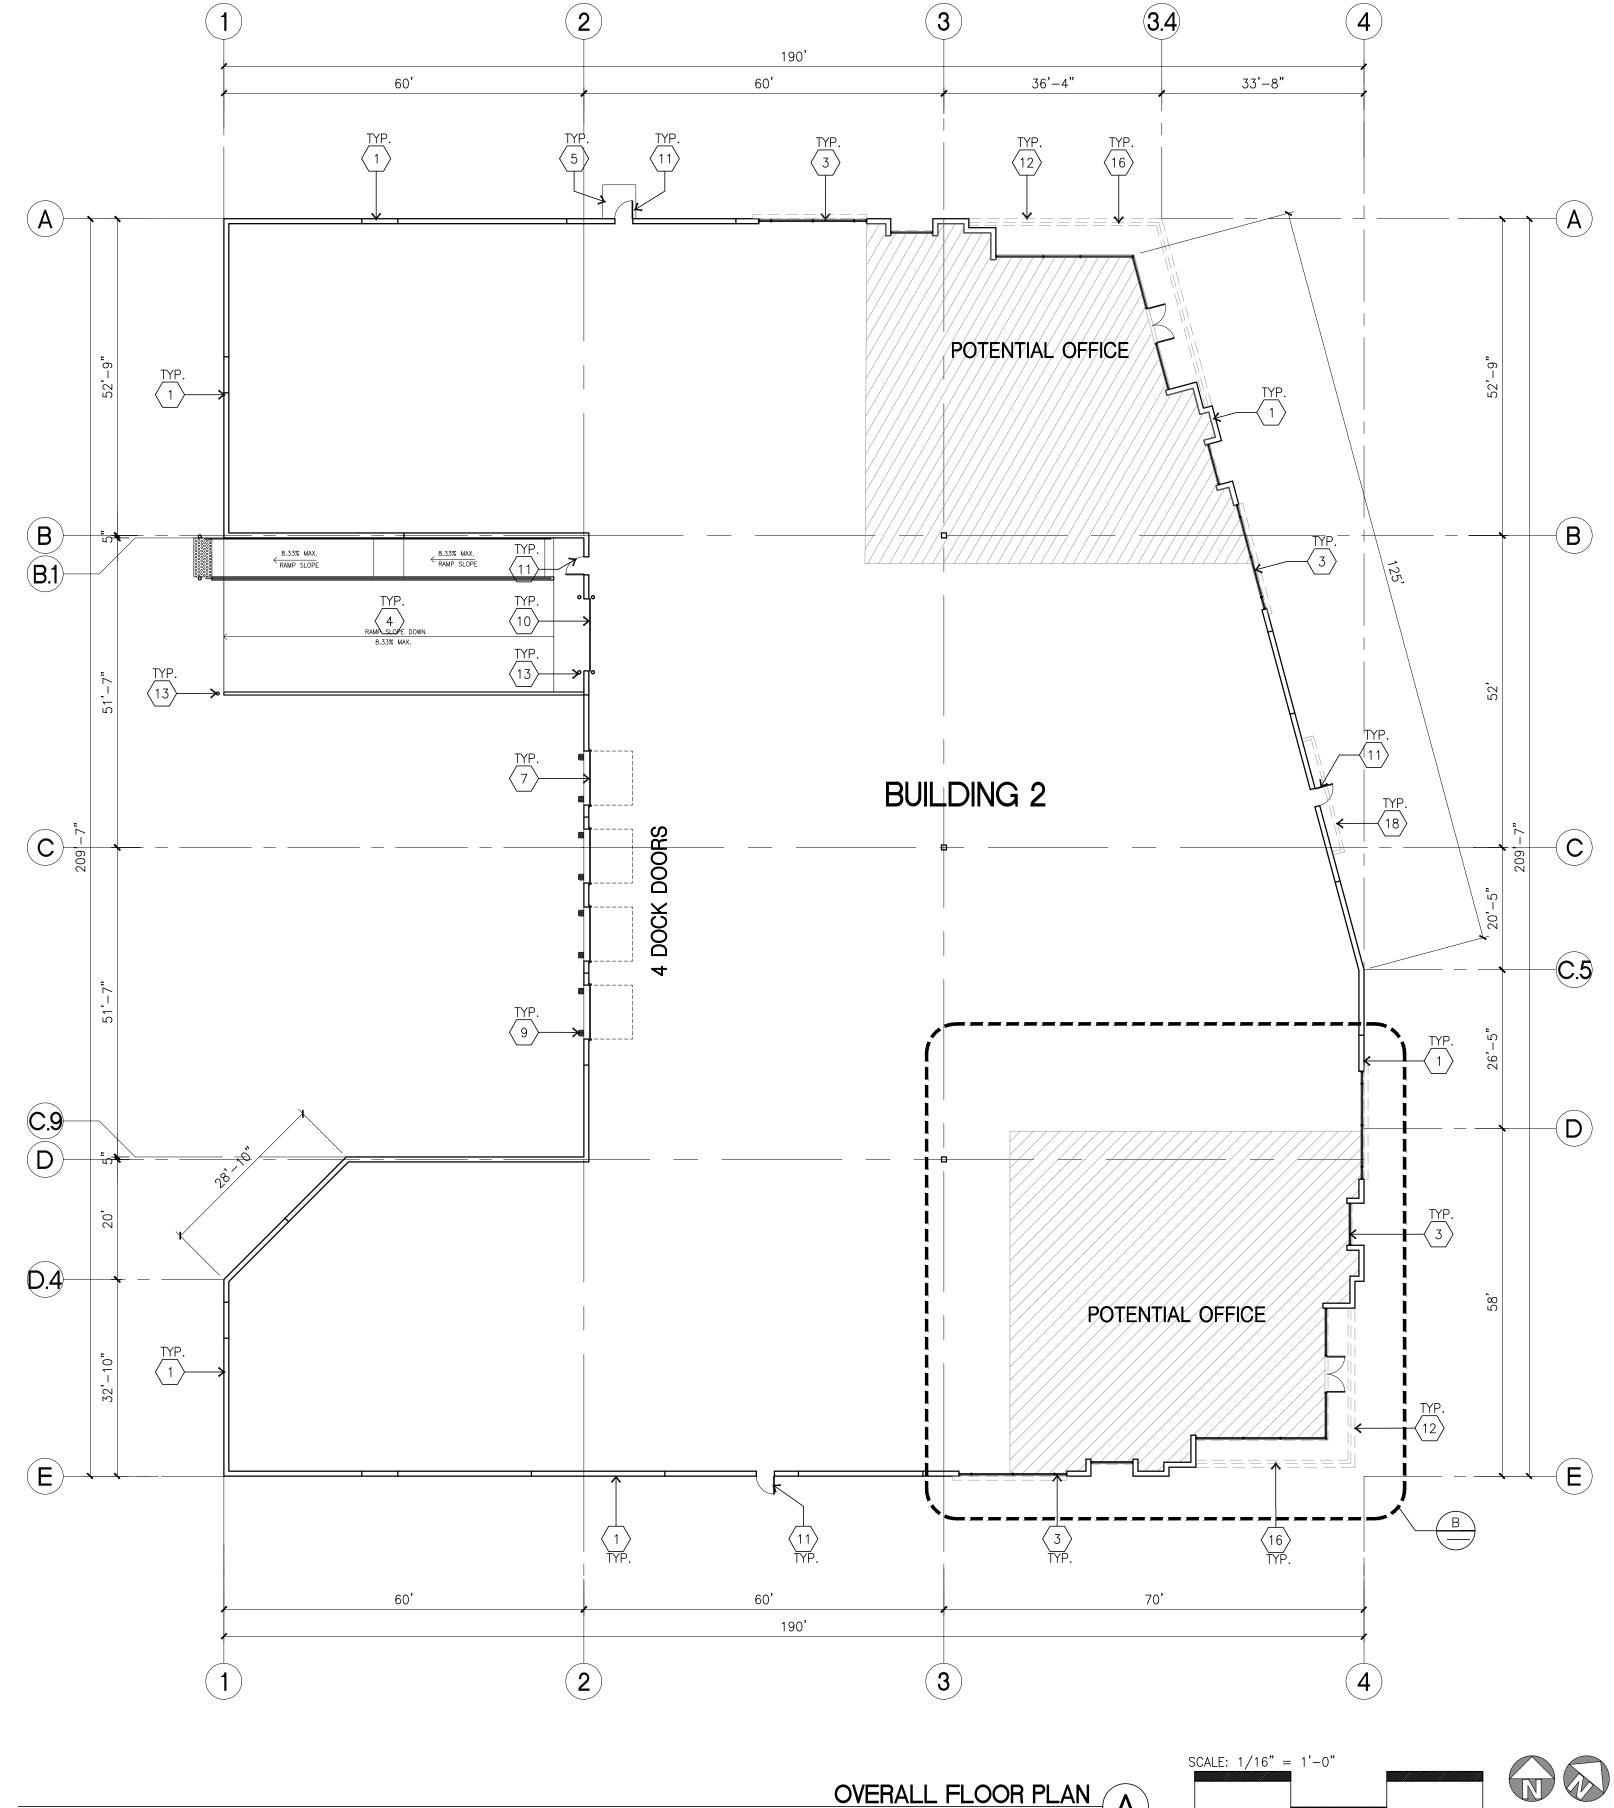

 $\langle 1 \rangle$ CONCRETE TILT-UP PANEL.

 $\langle 2 \rangle$ STRUCTURAL STEEL COLUMN.

TYPICAL STOREFRONT SYSTEM WITH GLAZING. SEE OFFICE BLOW-UP AND $\stackrel{3}{\longrightarrow}$ ELEVATIONS FOR SIZE, COLOR AND LOCATIONS. CONCRETE RAMP W/ 42"HIGH CONC TILT-UP GUARD WALL OR BUILDING WALL ON BOTH SIDE OF RAMP.

5 5'-6" x 5'-6" x 4" THICK CONCRETE EXTERIOR LANDING PAD TYP. AT ALL EXTERIOR MAN DOORS TO LANDSCAPED AREAS. FINISH TO BE MEDIUM

BROOM FINISH.

 $\langle 6 \rangle$ EXTERIOR CONCRETE STAIR. $\langle 7 \rangle$ 9' x 10' TRUCK DOOR, SECTIONAL O.H., STANDARD GRADE.

 $\langle 8 \rangle$ LOUVERED OPENING FOR VENTILATION.

(9) DOCK DOOR BUMPER TYPICAL.

 $\langle 10 \rangle$ 12' X 14' DRIVE THRU. SECTIONAL O.H., STANDARD GRADE.

 $\langle 11 \rangle$ 3' X 7' HOLLOW METAL EXTERIOR MAN DOOR. (12) SOFFIT LINE ABOVE

(13) CONC. FILLED GUARD POST. 6" DIA. U.N.O. AT 42"H.

 $\langle 14 \rangle$ EXTERIOR DOWNSPOUT WITH 2 OVERFLOW SCUPPER.

 $\langle 15 \rangle$ Z GUARD.

 $\langle 16 \rangle$ METAL CANOPY ABOVE.

 $\langle 17 \rangle$ NOT USED.

 $\langle 18 \rangle$ METAL POP OUT HORIZONTAL FACADE ABOVE

 $\langle 19 \rangle$ 42" CONCRETE GUARDWALL

FLOOR PLAN GENERAL NOTES

1. THIS BUILDING IS DESIGNED FOR HIGH PILE STORAGE WITH FIRE ACCESS MAN DOORS AT APPROXIMATELY 100' + /-. A SEPARATE PERMIT WILL BE REQUIRED FOR ANY RACKING/CONVEYER SYSTEMS. INSURE HEAT AND SMOKE VENTS AS REQ'D COMPLY WITH TABLE 910.3 CBC.

2. FIRE HOSE LOCATIONS SHALL BE APPROVED PER FIRE DEPARTMENT.

3. SEE "C" DRAWINGS FOR FINISH SURFACE ELEVATIONS.

4. WAREHOUSE INTERIOR CONCRETE WALLS ARE PAINTED WHITE. COLUMNS ARE TO RECEIVE PRIMER ONLY. ALL GYP. BD. WALLS IN WAREHOUSE TO RECEIVE 1 COAT OF WHITE TO COVER.

5. SLOPE POUR STRIP 1/2" TO EXTERIOR AT ALL MANDOOR EXITS. SEE "S" DRAWINGS FOR POUR STRIP LOCATION.

6. ALL DIMENSIONS ARE TO THE FACE OF CONCRETE PANEL WALL, GRID LINE, OR FACE OF STUD U.N.O.

7. PROVIDE 6" DIA. CONCRETE BOLLARD AT ALL FIRE RISER AND UNPROTECTED

INTERIOR ROOF DRAIN. 8. SEE CIVIL DRAWINGS FOR POINT OF CONNECTIONS TO OFF-SITE UTILITIES. CONTRACTOR TO VERIFY ACTUAL UTILITY LOCATIONS. PLUMBING/ELECTRICAL

9. FOR DOOR TYPES AND SIZES, SEE DETAIL SHEET A5.1. NOTE: ALL DOORS PER DOOR SCHEDULE ARE FINISH OPENINGS.

10. CONTRACTOR TO PROTECT AND KEEP THE FLOOR SLAB CLEAN. ALL EQUIPMENT TO BE DIAPERED INCLUDING CARS AND TRUCKS.

11. ALL EXIT MAN DOORS IN WAREHOUSE TO HAVE ILLUMINATED EXIT SIGN W/PANIC HARDWARE.

12. HIGHLY FLAMMABLE AND COMBUSTIBLE MATERIAL SHALL NOT BE USED OR STORED IN THIS BUILDING.

13. EACH EXTERIOR EXIT DOOR SHALL BE IDENTIFIED BY A TACTILE EXIT SIGN WITH THE WORDS "EXIT". THE MOUNTING HEIGHT FOR SUCH SIGNAGE SHALL BE 60" FROM FINISH FLOOR LEVEL TO THE CENTER OF THE SIGN.

14. FFIX AN INTERNATIONAL ACCESSIBILITY SYMBOL ON ALL ACCESSIBLE ENTRANCES AND ALL INTERIOR AND EXTERIOR WALKING SURFACES TO BE

15. NON-ACCESSIBLE DOOR. PROVIDE WARNING SIGN LOCATED IN THE INTERIOR SIDE PER CBC 11B-703.5

16. ALL ROOF MOUNTED MATERIALS SHALL BE FULLY SCREENED FROM PUBLIC VIEW, SEE A/A4.1 OFFICE SECTION.

FLOOR SLAB & POUR STRIPS REQ.

THESE NOTES ARE VERY MIN. REQUIREMENT. SEE "S" DWGS FOR ADDITIONAL REQUIREMENTS

1. FLOOR COMPACTION - 95%

2. TRENCH COMPACTION - 90% 3. BUILDING FLOOR SLAB: SEE STRUCTURAL DRAWINGS. 4. CONTRACTOR TO BUILD FOR CLASS V FLOOR PER A.C.I. 302-IR-96

5. CONCRETE SLAB TO HAVE STEEL FLOAT HARD TROWEL BURNISHED FINISH. 6. CONTRACTOR TO CURE SLAB TO BE WET CURING USING BURLINE FOR 7 DAYS

7. ALL EQUIPMENT & MOVING VEHICLES SHALL BE DIAPERED. 8. NO CRANES, CONCRETE TRUCKS, OR ANYTHING HEAVIER WILL BE PLACED ON

THE SLAB.

9. SLAB TO BE FF50 FL35 MEASURED WITHIN 24 HOURS. 10. NO FLY ASH IN THE CONCRETE

12. SEAL CONCRETE SLAB W/ "LIPIDOLITH" SEALER

11. WHERE ///// INDICATED, PROVIDE VAPOR BARRIER (15MIL STEGO OR EQUAL) UNDER THE CONCRETE SLAB. PROVIDE SAND PER SOILS ENGINEER OR MANUFACTURER'S RECOMMENDATION. CONCRETE SLAB IN FUTURE OFFICE AREAS, WHERE SAND OVER VIQUEEN ARE REQUIRED, SHALL BE NATURALLY HYDRATED WITHOUT USE OF BURLENE, CURING COMPOUND, OR RELEASE AGENTS. CONTROL/CONSTRUCTION JOINTS SHALL NOT BE FILLED WITH MM-80 JOINT FILLER IN FUTURE OFFICE AREAS.

13. 10' POUR STRIP AT TRUCK DOOR. 4FT. MAX. ELSEWHERE. 14. ALL FLOOR SLAB NAIL OR BRACE FRAME HOLES FILLED WITH APPROVED 2 PART EPOXY COMPOUND TO MATCH CONCRETE COLOR. PEGA BOND LV 2000, BURKE

EPOXY INJECTION RESIN OR EQUAL. 15. PROVIDE FIRE EXTINGUISHERS PER FIRE DEPARTMENT REQUIREMENT. 16. MM-80 AT SPEED BAY ONLY



hpa, inc. 18831 bardeen avenue - ste. #100 irvine, ca tel: 949 •863 •1770 fax: 949 • 863 • 0851 email: hpa@hparchs.com



11777 San Vicente Blvd, Ste. 780 Los Angeles, CA 90049 tel: (949) 296-7006 fax: (949) 842-3074

TEMESCAL VALLEY COMMERCE CENTER

> DAWSON CANYON RD. CORONA, CA 92883



THIENES

Structural: Mechanical: TBD Plumbing: TBD Electrical: Landscape: HUNTER LANDSCAPE


Fire Protection: DCW3 Soils Engineer:





Project Number: Drawn by: 11/10/22 Date:


Revision:


Title:

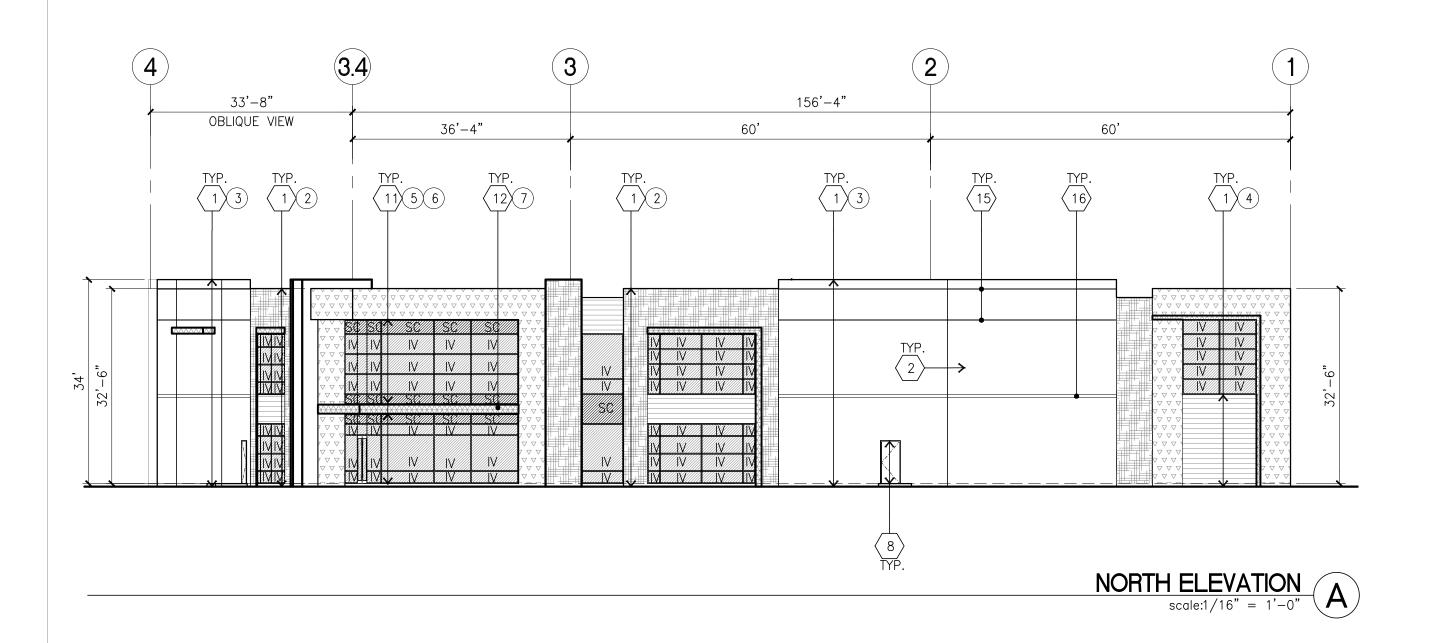


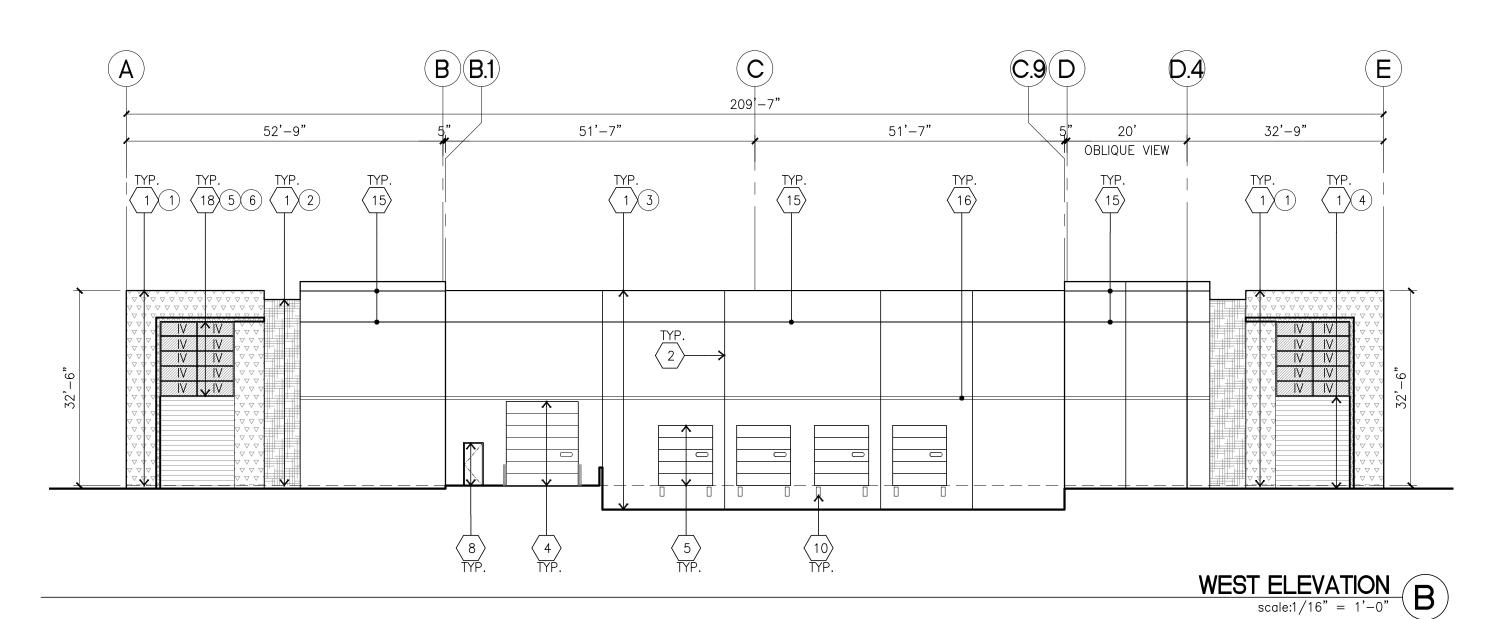

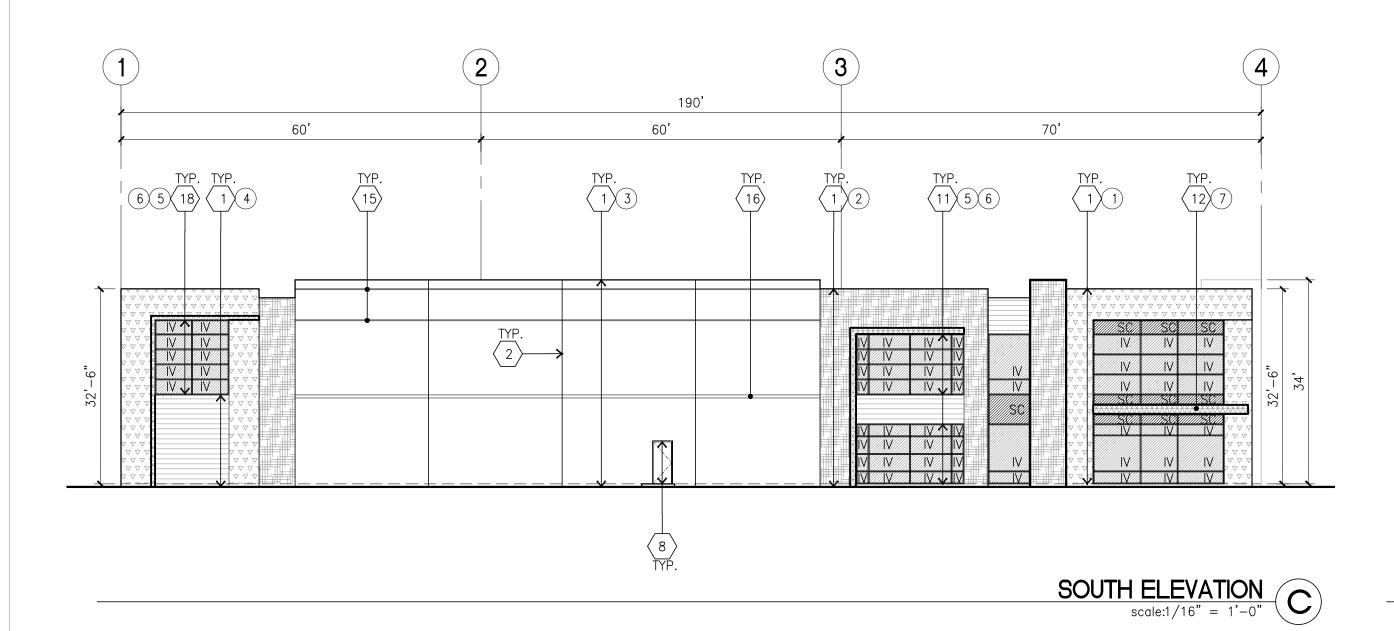

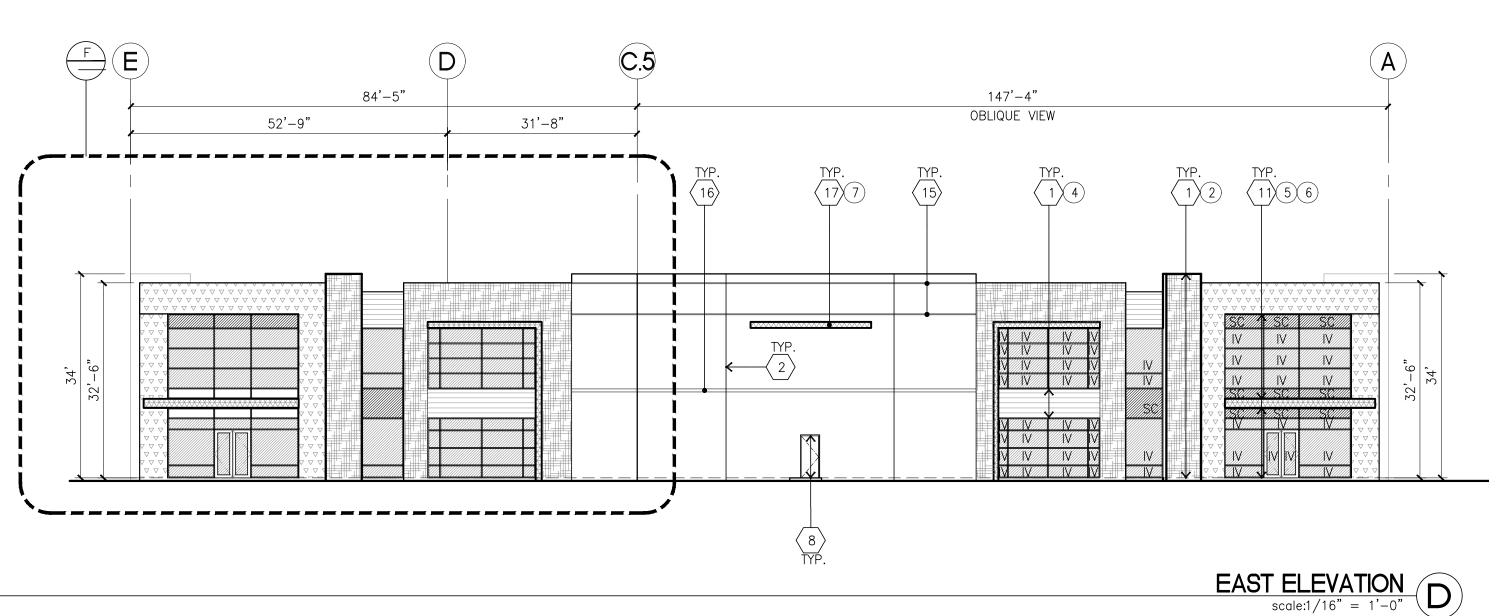

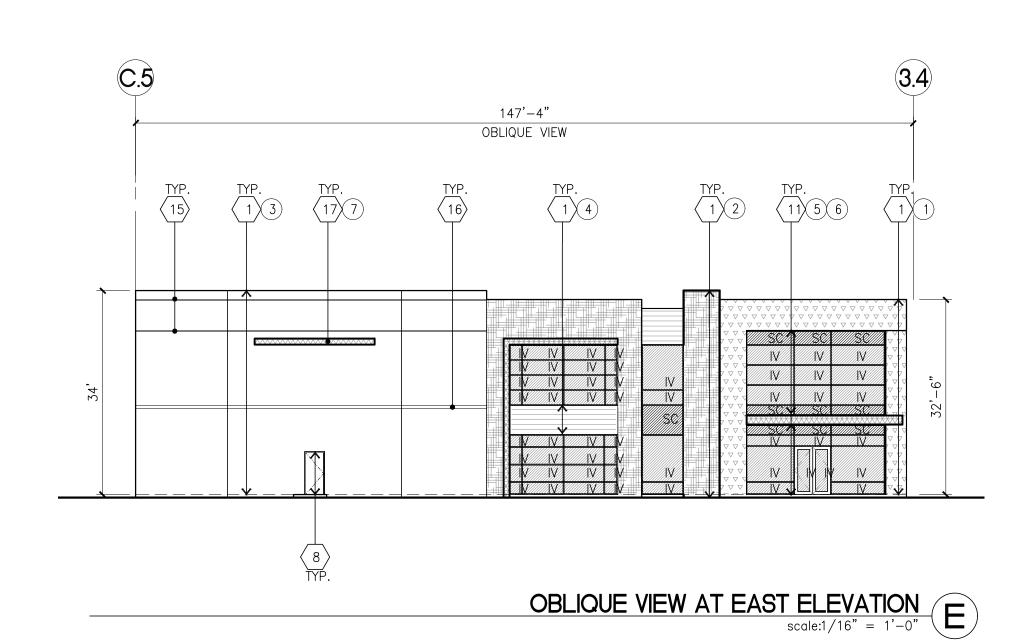

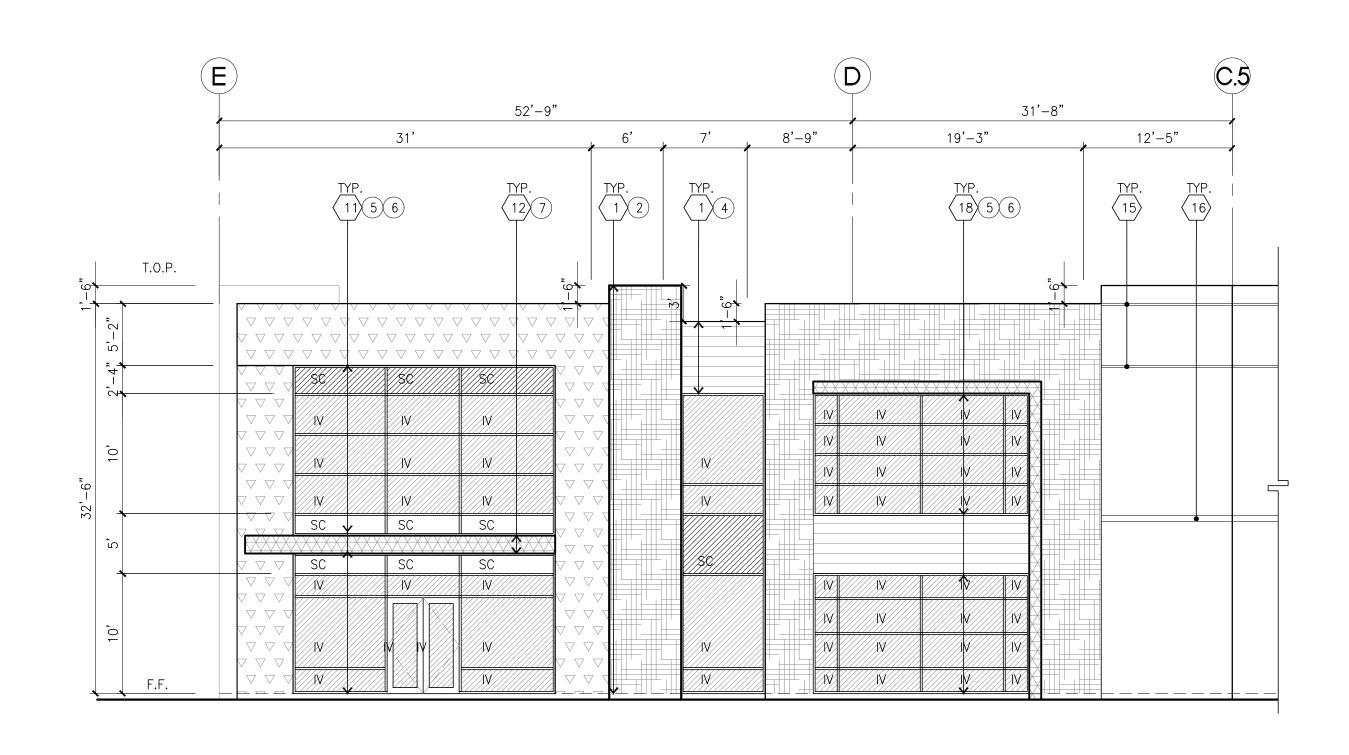

ENLARGED EAST ELEVATION scale: 1/8" = 1'-0"

ELEVATION KEYNOTES

(1) CONCRETE TILT-UP PANEL.

 $\langle 2 \rangle$ PANEL JOINT.

 $\langle 3 \rangle$ NOT USED.

4 12' X 14' OVERHEAD DOOR @ DRIVE THRU. PROVIDE COMPLETE 4/ WEATHER-STRIPPING PROTECTION ALL AROUND.

9' X 10' OVERHEAD DOOR @ DRIVE THRU. PROVIDE COMPLETE WEATHER-STRIPPING PROTECTION ALL AROUND.

6 CONCRETE STAIR, LANDING AND GUARDRAIL W/ METAL PIPE HANDRAIL. PROVIDE NON SKID NOSING TO MEET ADA REQUIREMENTS. PROVIDE CONTRASTING COLORED 3" WIDE WARNING STRIPE INTEGRAL TO CONCRETE AT TOP LANDING AND BOTTOM TREAD PER ADA REQUIREMENTS. 7 4' X 8' METAL LOUVER OPENING FOR VENTILATION. PAINT TO MATCH

✓ BUILDING COLOR. 8 HOLLOW METAL DOORS. PROVIDE COMPLETE WEATHER STRIPING ALL AROUND DOOR.

 \langle 9 \rangle EXTERIOR DOWN SPOUTS W/ 2 OVERFLOW SCUPPERS. 0 DOCK DOOR BUMPER TYPICAL.

ALUMINUM STOREFRONT FRAMING WITH TEMPERED GLAZING AT ALL DOORS, SIDELITES ADJACENT TO DOORS AND GLAZING WITH BOTTOMS LESS THAN 18" ABOVE FINISH FLOOR ELEVATION.

 $\langle 12 \rangle$ METAL CANOPY.

13 INTERIOR ROOF DRAIN W/ 2 OVERFLOW SCUPPERS.

(14) CONC. FILLED GUARD POST. 6" DIA. U.N.O. AT 42"H. 2" HORIZONTAL REVEAL WITH 3/8" CHAMFER. REVEAL COLOR TO MATCH

ADJACENT BUILDING FIELD COLÓR. U.N.O. 6" HORIZONTAL REVEAL WITH 3/8" CHAMFER. REVEAL COLOR TO MATCH ADJACENT BUILDING FIELD COLOR. U.N.O.

 $\langle 17 \rangle$ METAL POP OUT HORIZONTAL FACADE ABOVE $\langle 18 \rangle$ ALUMINUM STOREFRONT FRAMING WITH GLAZING

ELEVATION GENERAL NOTES

1. ALL PAINT COLOR CHANGES TO OCCUR AT INSIDE CORNERS UNLESS NOTED OTHERWISE.

2. ALL PAINT FINISHES ARE TO BE FLAT UNLESS NOTED OTHERWISE.

3. T.O.P. EL.= TOP OF PARAPET ELEVATION.

4. F.F. = FINISH FLOOR ELEVATION.

5. STOREFRONT CONSTRUCTION: GLASS, METAL ATTACHMENTS AND LINTELS SHALL BE DESIGNED TO RESIST - MPH. EXPOSURE "C" WINDS. CONTRACTOR SHALL SUBMIT SHOP DRAWINGS PRIOR TO INSTALLATION.

6. CONTRACTOR SHALL FULLY PAINT ONE CONCRETE PANEL W/ SELECTED COLORS. ARCHITECT AND OWNER SHALL APPROVE PRIOR TO PAINTING REMAINDER OF BUILDING.

7. BACK SIDE OF PARAPETS TO HAVE SMOOTH FINISH AND BE PAINTED WITH

8. FOR SPANDREL GLAZING, ALLOW SPACE BEHIND SPANDREL TO BREATH. PROVIDE 1" DIAMETER HOLES AT CONCRETE WALL.

9. USE ADHESIVE BACK WOOD STRIPS FOR ALL REVEAL FORMS. 10. THE FIRST COAT OF PAINT TO BE ROLLED-ON AND THE SECOND COAT TO BE SPRAYED-ON

11. ALL ROLL-UP DOORS AND SERVICE DOORS TO BE PAINTED TO MATCH BUILDING COLOR.

ELEVATION COLOR LEGEND/SCHED.

PAINT. COLOR: SW 7525 TREE BRANCH (288C7)

PAINT. COLOR: SW 7638 JOGGING PATH (247-C2)

PAINT. COLOR: SW 9166 DRIFT OF MIST (238-C2)

PAINT. COLOR: SW METAL PANEL - LONGBOARD LIGHT BAMBOO

MULLIONS COLOR : CLEAR ANODIZED

6 GLAZING COLOR : BLUE REFLECTIVE METAL CANOPY WITH DUNN EDWARDS DEA 160 HOPE CHEST

GLAZING LEGEND

NOTE: ALL EXTERIOR AND INTERIOR GLAZING SHALL BE TEMPERED.

SPANDREL GLASS WITH CONCRETE BEHIND INSULATED VISION GLASS

SINGLE LITE VISION GLASS

IV: INSULATED VISION GLASS

1/4" VISTACOOL PACIFICA + 1/4" SOLARBAN 60 CLEAR

1" INSULATED GLASS UNIT WITH 1/2" AIRSPACE AND 1/4" LITES

U: 0.27 SHGC: 0.21 VLT: 26%

MINIMUM VT TO BE 0.42 PER 2016 CEC TABLE 140.3—B


SC: SPANDREL WITH CONCRETE BEHIND 1/4" VISTACOOL PACIFICA WITH WARM GRAY OPACICOAT PAINTED ON REFLECTIVE. INSTALLED ON CONCRETE.

V : VISION GLASS 1/4" VISTACOOL PACIFICA

MULLIONS : ANODIZED CLEAR.



hpa, inc. 18831 bardeen avenue - ste. #100 irvine, ca tel: 949 •863 •1770 fax: 949 • 863 • 0851 email: hpa@hparchs.com

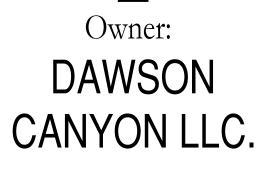

11777 San Vicente Blvd, Ste. 780 Los Angeles, CA 90049 tel: (949) 296-7006 fax: (949) 842-3074

TEMESCAL VALLEY COMMERCE CENTER

DAWSON CANYON RD.

CORONA, CA 92883


Civil:	THIENES
Structural:	-
Mechanical:	TBD
Plumbing:	TBD
Electrical:	TBD

Landscape: HUNTER LANDSCAPE Fire Protection: DCW3 Soils Engineer:


Title: Elevations

Project Number: Drawn by: 11/10/22 Date:

Revision:

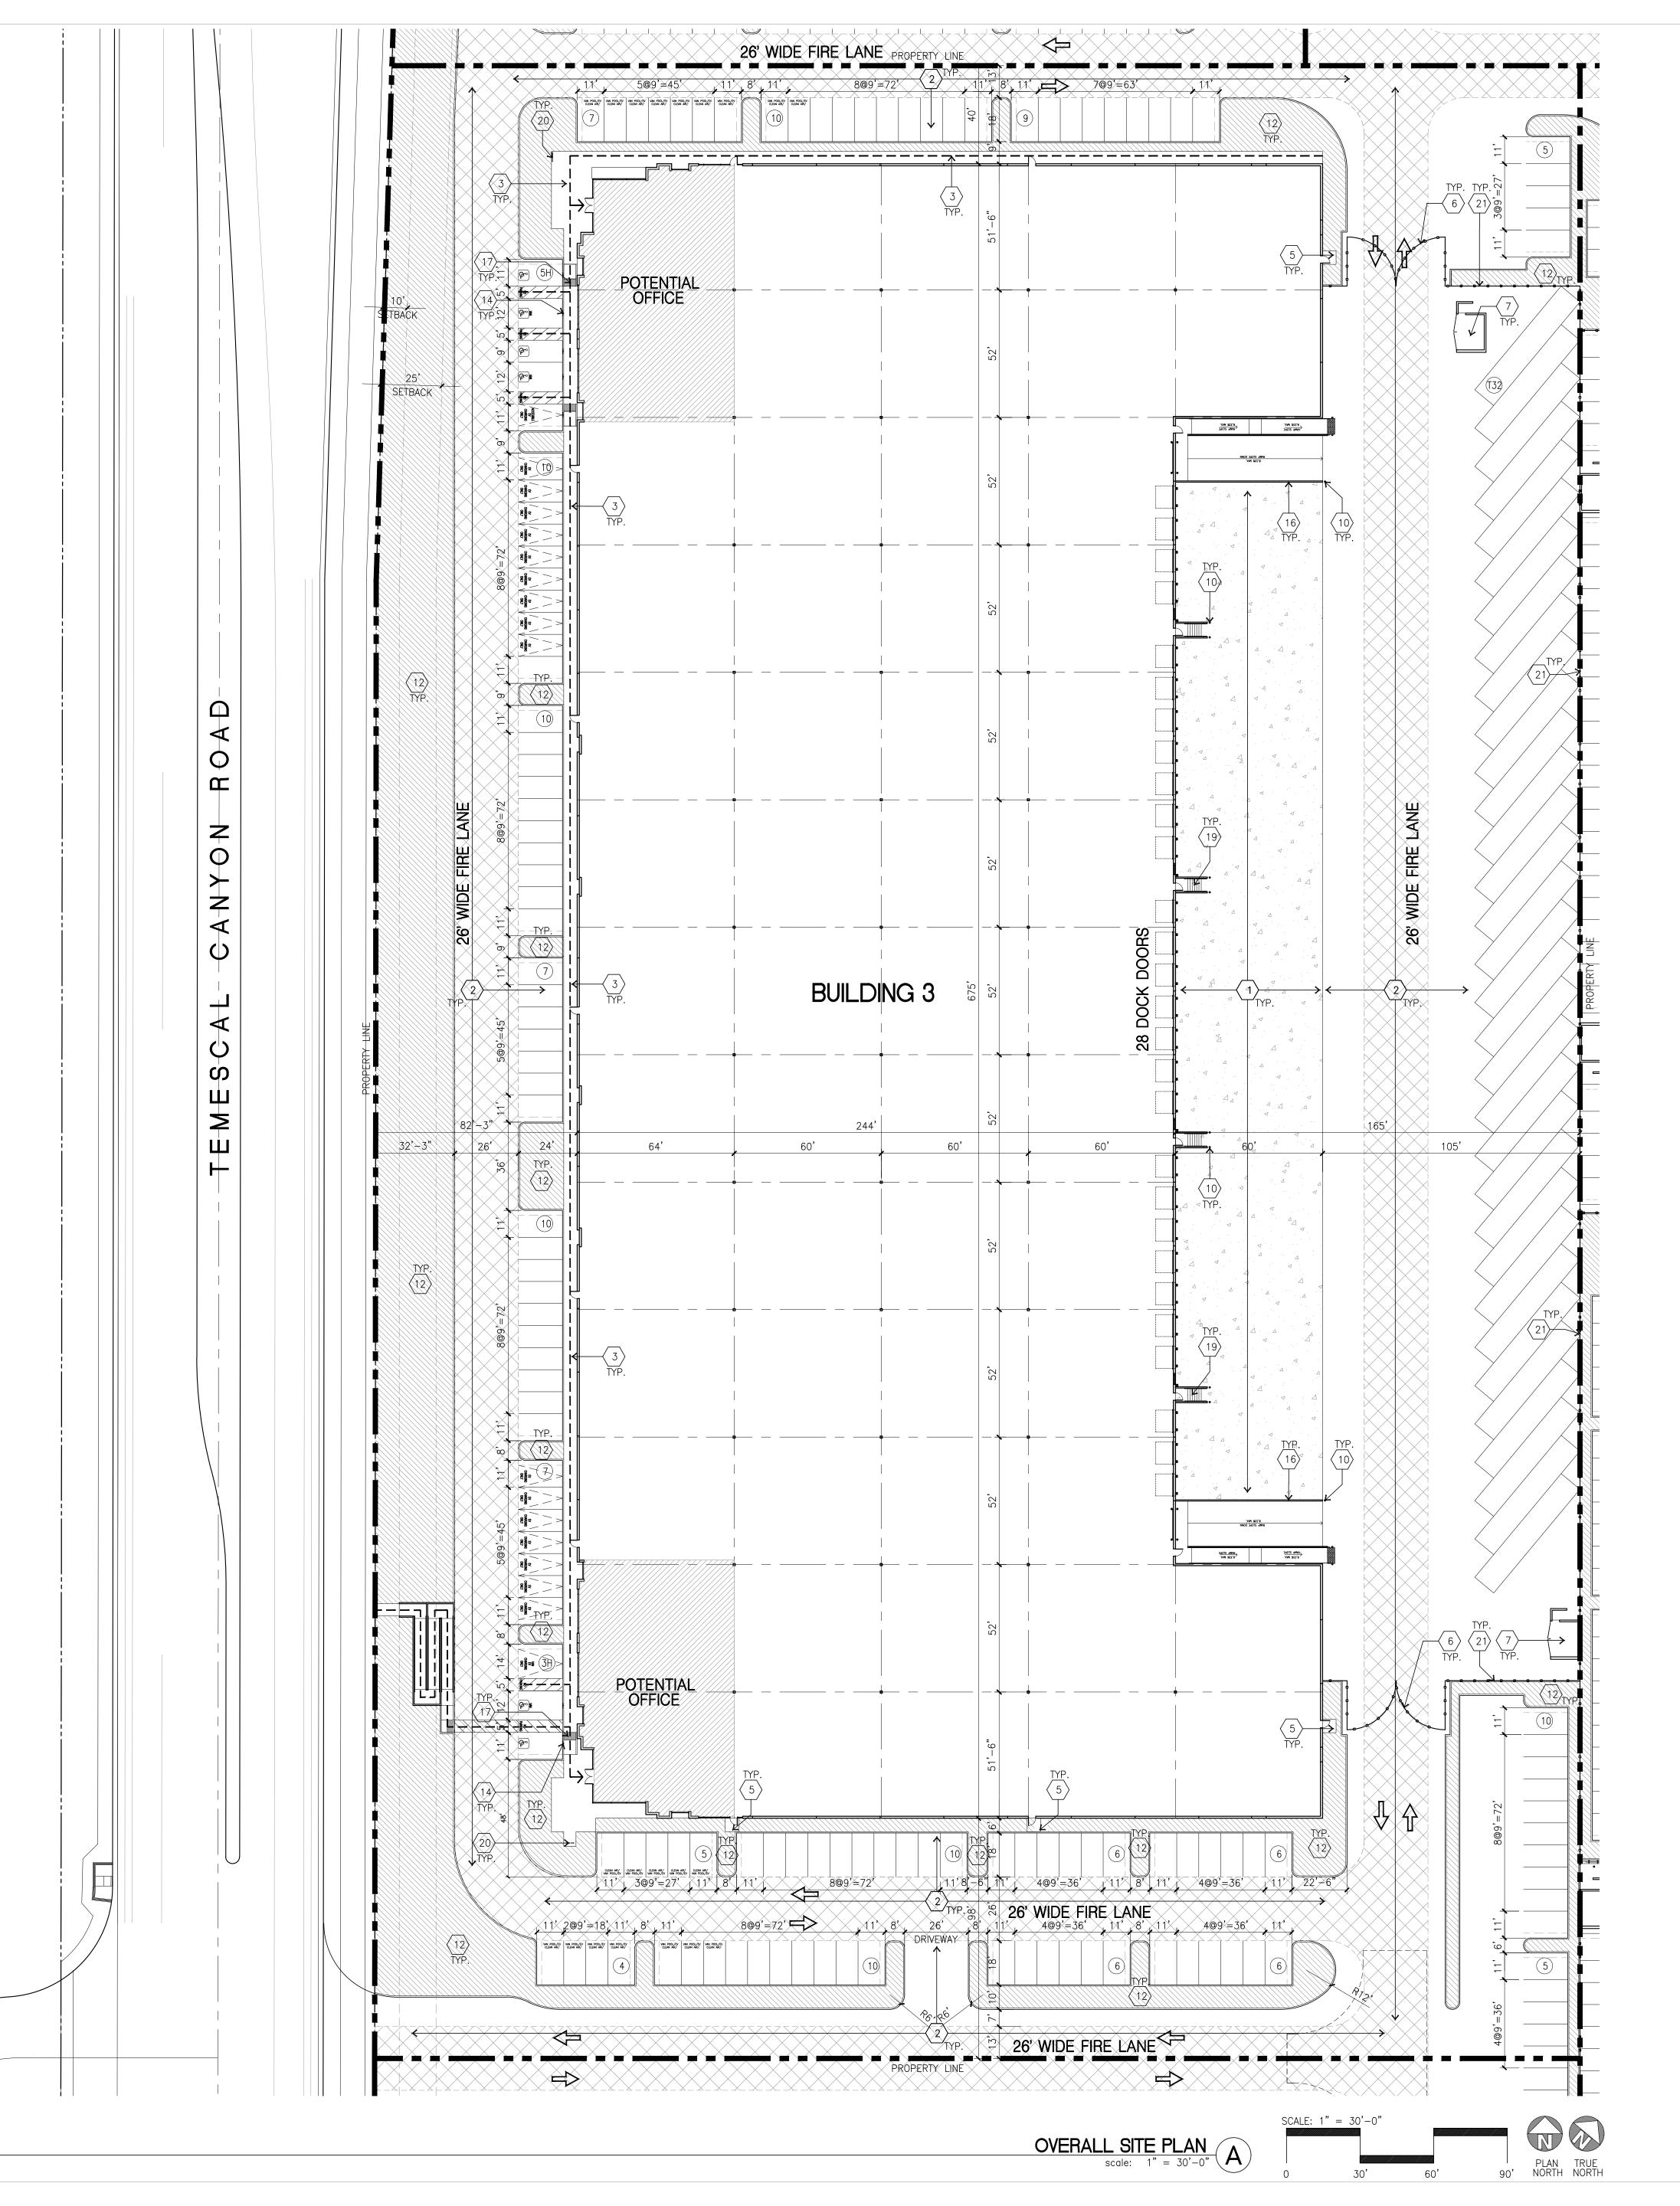

AERIAL MAP

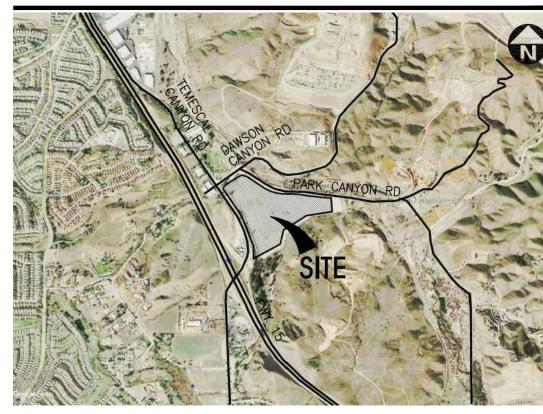

PROJECT INFORMATION

Code Analysis 2019 CALIFORNIA BUILDING CODE 2019 CALIFORNIA PLUMBING CODE

2019 CALIFORNIA MECHANICAL CODE 2019 CALIFORNIA ELECTRICAL CODE 2019 CALIFORNIA FIRE CODE 2019 CALIFORNIA GREEN BUILDING STANDARDS CODE 2019 CALIFORNIA ENERGY CODE

Applicant's Representatives

18831 BARDEEN AVE., SUITE 100 IRVINE, CA 92612

(949) 862-2161(949) 863-0851 CONTACT: ANDY WIYANTO

THIS IS A CONCEPTUAL PLAN. IT IS BASED ON PRELIMINARY INFORMATION WHICH IS NOT FULLY VERIFIED AND MAY BE INCOMPLETE. IT IS MEANT AS A COMPARATIVE AID IN EXAMINING ALTERNATE DEVELOPMENT STRATEGIES AND ANY QUANTITIES INDICATED ARE SUBJECT TO REVISION AS MORE RELIABLE

BUILDING OCCUPANCY : S-1 / B

CONSTRUCTION TYPE : III-B

FIRE SPRINKLER BUILDING

283-160-046

283-190-044

LEGAL DESCRIPTION

INFORMATION BECOMES AVAILABLE.

THE LAND REFERRED TO IN THIS COMMITMENT IS SITUATED IN THE UNINCORPORATED AREA OF THE COUNTY OF RIVERSIDE, STATE OF CALIFORNIA, AND IS DESCRIBED AS FOLLOWS:

PARCEL 2 OF NOTICE OF LOT LINE ADJUSTMENT NO. LLA200028, RECORDED JUNE 21, 2021 AS INSTRUMENT NO. 2021—0373323 OF OFFICIAL RECORDS OF RIVERSIDE COUNTY, CALIFORNIA, BEING THOSE PORTIONS OF THE LAND DESCRIBED IN PARCELS 6, 7 AND 8 OF "CORPORATION GRANT DEED", IN THE EAST HALF OF THE NORTHEAST QUARTER OF SECTION 34, TOWNSHIP 4 SOUTH, RANGE 6 WEST AND THE NORTHWEST QUARTER OF SECTION 35, TOWNSHIP 4 SOUTH, RANGE 6 WEST, SAN BERNARDINO MERIDIAN, IN THE UNINCORPORATED TERRITORY OF THE COUNTY OF RIVERSIDE, STATE OF CALIFORNIA, RECORDED JUNE 30, 1987 AS INSTRUMENT NO. 186951, OF OFFICIAL RECORDS OF SAID COUNTY, BOUNDED AS FOLLOWS:

ON THE NORTHWEST BY THE SOUTHEASTERLY LINE OF DAWSON CANYON ROAD AS DESCRIBED IN PARCEL 1 OF "CORPORATION QUITCLAIM DEED", RECORDED MAY 03, 2002 AS DOCUMENT NO. 2002-236679, OF OFFICIAL RECORDS OF SAID COUNTY;

AND BOUNDED EASTERLY BY THE FOLLOWING DESCRIBED LINE: COMMENCING AT THE WESTERLY TERMINUS OF THAT CERTAIN MOST SOUTHERLY LINE OF SAID PARCEL 6, DESCRIBED AS HAVING A BEARING AND DISTANCE OF "NORTH 89" 51' 27" EAST, 840.06 FEET", SAID WESTERLY TERMINUS ALSO BEING ON THE EASTERLY LINE OF TEMESCAL CANYON ROAD (40.00 FEET HALF-WIDE) AS SHOWN ON PARCEL MAP NO. 31196, AS PER MAP FILED IN BOOK 208, PAGES 50 THROUGH 53, INCLUSIVE OF PARCEL MAPS, IN THE OFFICE OF THE COUNTY RECORDER OF SAID COUNTY; THENCE ALONG SAID MOST SOUTHERLY LINE OF PARCEL 6, NORTH 89' 51' 27" EAST, 586.31 FEET TO A POINT ON THE MOST SOUTHERLY LINE OF SAID PARCEL 8, SAID POINT BEING THE TRUE POINT OF BEGINNING; THENCE NORTH 27" 54' 55" EAST 499.99 FEET TO THE BEGINNING OF A TANGENT CURVE, CONCAVE WESTERLY AND HAVING A RADIUS OF 1080.00 FEET; THENCE NORTHERLY ALONG SAID CURVE, THROUGH A CENTRAL ANGLE OF 31° 44' 51", AN ARC LENGTH OF 598.43 FEET; THENCE TANGENT TO SAID CURVE, NORTH 03' 46' 59" WEST 269.31 FEET TO A POINT ON THAT CERTAIN NORTHERLY CURVED LINE OF SAID PARCEL 8 DESCRIBED AS HAVING A RADIUS OF 700.00 FEET AND A LENGTH OF 143.85 FEET, SAID POINT BEING THE END POINT OF THIS DESCRIPTION.

APN: PORTIONS OF APNS 283-160-046 AND 283-190-044

TABULATION

Side/Rear - None

	BLDG. 3
SITE AREA	
In s.f.	399,315
In acres	9.167
BUILDING AREA	
Office	6,500
Mezzanine	6,500
Warehouse	170,090
TOTAL	183,090
COVERAGE	44.2%
CLEARANCE	36'
AUTO PARKING REQUIRED	
Office: 1/250 s.f.	52
Warehouse: 1/2,000 s.f.	85
TOTAL	137
AUTO PARKING STALLS PROVIDED	
Standard (9' x 18')	106
Accessible Parking (9' x 18')	5
Accessible Van Parking (12' x 18')	1
EV Standard (9' x 18')	16
EV Accessible (9' x 18')	1
EV Van Accessible (12' x 18')	1
EV Ambulatory	
Clean Air Vehicle (9' x 18')	21
TOTAL	151
TRAILER PARKING PROVIDED	
Trailer (10' x 55')	32
ZONING ORDINANCE FOR COUNTY	
M-M Manufacturing Medium	
M-R-A Mineral Resources and Related Manufacturing	
MAXIMUM BUILDING HEIGHT ALLOWED	
Height - 50'	
MAXIMUM FLOOR AREA RATIO	
FAR (Total gross area/site):	45.9%
LANDSCAPE REQUIREMENT	
Required landscape area (10%):	39,931
Provided area:	39,032
SETBACKS	
Building	
Street Front - 25'	
	i

SITE PLAN KEYNOTES

- \langle 1 \rangle HEAVY BROOM FINISH CONCRETE PAVEMENT.
- 2 > ASPHALT CONCRETE (AC) PAVING.
- (3) CONCRETE WALKWAY, MEDIUM BROOM FINISH.
- \langle 4 angle driveway aprons to be constructed per civil drawings.
- $\left(\begin{array}{c}5\end{array}\right)$ 5'-6" x 5'-6" x 4" THICK CONCRETE EXTERIOR LANDING PAD TYP. AT ALL $^\prime$ EXTERIOR MAN DOORS TO LANDSCAPED AREAS. FINISH TO BE MEDIUM BROOM
- PROVIDE 8' HIGH METAL GATES W/ KNOX-BOX PER FIRE DEPARTMENT STANDARDS PER DRIVEWAY.
- 7 TRASH ENCLOSURE PER CITY STANDARD.
- \langle 8 angle APPROXIMATE LOCATION OF TRANSFORMER. \langle 9 \rangle PRE-CAST CONCRETE WHEEL STOP.
- $\langle 10
 angle$ concrete filled guard post "6 dia. u.n.o. at 42" h.
- \langle 11 \rangle DESIGNATED SMOKING AREA.
- \langle 12 angle LANDSCAPE. ALL LANDSCAPE AREAS INDICATED BY SHADING.
- (14) ACCESSIBLE PARKING STALL SIGN.
- $\langle 15 \rangle$ 14'-0" SCREEN WALL

13 MONUMENT SIGN.

- \langle 16 angle 42" HIGH CONCRETE GUARDWALL.
- \langle 17 \rangle TRUNCATED DOME.
- $\langle 18 \rangle$ NOT USED.
- Construction Type (19) EXTERIOR CONCRETE STAIR WITH GUARDWALL AND HANDRAIL CONCRETE TILT-UP BUILDING
 - $\langle 20 \rangle$ EXTERIOR BIKE RACK.
 - $\langle 21 \rangle$ 8' HIGH METAL FENCE

SITE PLAN GENERAL NOTES

- 1. THE SITE PLAN BASED ON THE SOILS REPORT PREPARED BY:
- 2. IF SOILS ARE EXPANSIVE IN NATURE, USE STEEL REINFORCING FOR ALL SITE
- 3. ALL DIMENSIONS ARE TO THE FACE OF CONCRETE WALL, FACE OF CONCRETE CURB OR GRID LINE U.N.O.
- 4. SEE "C" PLANS FOR ALL CONCRETE CURBS, GUTTERS AND SWALES.
- 5. THE ENTIRE PROJECT SHALL BE PERMANENTLY MAINTAINED WITH AN AUTOMATIC IRRIGATION SYSTEM.
- 6. SEE "C" DRAWINGS FOR POINT OF CONNECTIONS TO OFF-SITE UTILITIES. CONTRACTOR SHALL VERIFY ACTUAL UTILITY LOCATIONS.
- 7. PROVIDE POSITIVE DRAINAGE AWAY FROM BLDG. SEE "C" DRAWINGS.
- 8. CONTRACTOR TO REFER TO "C" DRAWINGS FOR ALL HORIZONTAL CONTROL DIMENSIONS. SITE PLANS ARE FOR GUIDANCE AND STARTING LAYOUT POINTS.
- 9. SEE "C"DRAWINGS FOR FINISH GRADE ELEVATIONS.
- 10. CONCRETE SIDEWALKS TO BE A MINIMUM OF 4" THICK W/ TOOLED JOINTS AT 6' O.C. EXPANSION/CONSTRUCTION JOINTS SHALL BE A MAXIMUM 12' EA. WAY. EXPANSION JOINTS TO HAVE COMPRESSIVE EXPANSION FILLER MATERIAL OF 1/4". FINISH TO BE A MEDIUM BROOM FINISH U.N.O.
- 11. PAINT CURBS AND PROVIDE SIGNS TO INFORM OF FIRE LANES AS REQUIRED BY FIRE DEPARTMENT.
- 12. CONSTRUCTION DOCUMENTS PERTAINING TO THE LANDSCAPE AND IRRIGATION OF THE ENTIRE PROJECT SITE SHALL BE SUBMITTED TO THE BUILDING DEPARTMENT AND APPROVED BY PUBLIC FACILITIES DEVELOPMENT PRIOR TO ISSUANCE OF
- 13. PRIOR TO FINAL CITY INSPECTION, THE LANDSCAPE ARCHITECT SHALL SUBMIT A CERTIFICATE OF COMPLETION TO PUBLIC FACILITIES DEVELOPMENT.
- 14. ALL LANDSCAPE AND IRRIGATION DESIGNS SHALL MEET CURRENT CITY STANDARDS AS LISTED IN GUIDELINES OR AS OBTAINED FROM PUBLIC FACILITIES

LANDSCAPED AREA

EXISTING PUBLIC FIRE HYDRANT

APPROXIMATE LOCATION

ACCESSIBLE PARKING (VAN)

STALL (12' X 18') + 5' W/
ACCESSIBLE AISLE

PATH OF TRAVEL

15. LANDSCAPED AREAS SHALL BE DELINEATED WITH A MINIMUM SIX INCHES (6")

SITE LEGEND

SEE "C" DRWGS. FOR THICKNESS ASPHALT CONCRETE PAVING _____ SEE "C" DRWGS. FOR THICKNESS

26' WIDE FIRELANE PRIVATE FIRE HYDRANT-


ACCESSIBLE PARKING STALL (9' X 18') + 5' ////// W/ ACCESSIBLE AISLE

EV PARKING CLEAN AIR/VANPOOL/EV (PROVIDE CONDUIT FOR **FUTURE EV CHARGING)**

EV AMBULATORY PARKING

_____ STALL (10' X 18')

KEY MAP

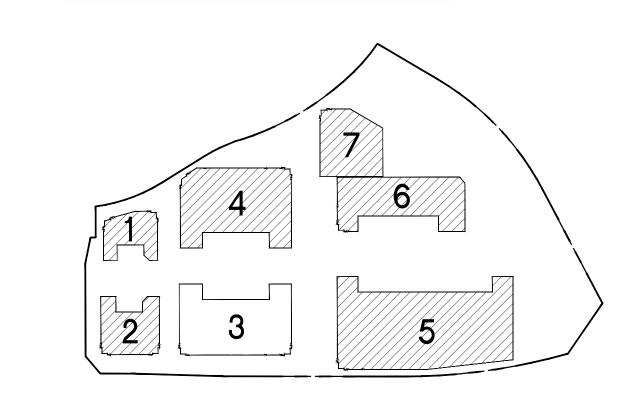



hpa, inc. 18831 bardeen avenue - ste. #100 irvine, ca tel: 949 •863 •1770 fax: 949 • 863 • 0851 email: hpa@hparchs.com



Owner: DAWSON CANYON LLC.

11777 San Vicente Blvd, Ste. 780 Los Angeles, CA 90049 tel: (949) 296-7006 fax: (949) 842-3074



Project:

TEMESCAL VALLEY COMMERCE CENTER

> DAWSON CANYON RD. CORONA, CA 92883

Consultants:


THIENES Structural: Mechanical TBD Plumbing:

Landscape: HUNTER LANDSCAPE Fire Protection: Soils Engineer: DCW3

Electrical:

Overall Site Plan

Project Number: Drawn by: 11/10/22 Date: Revision:

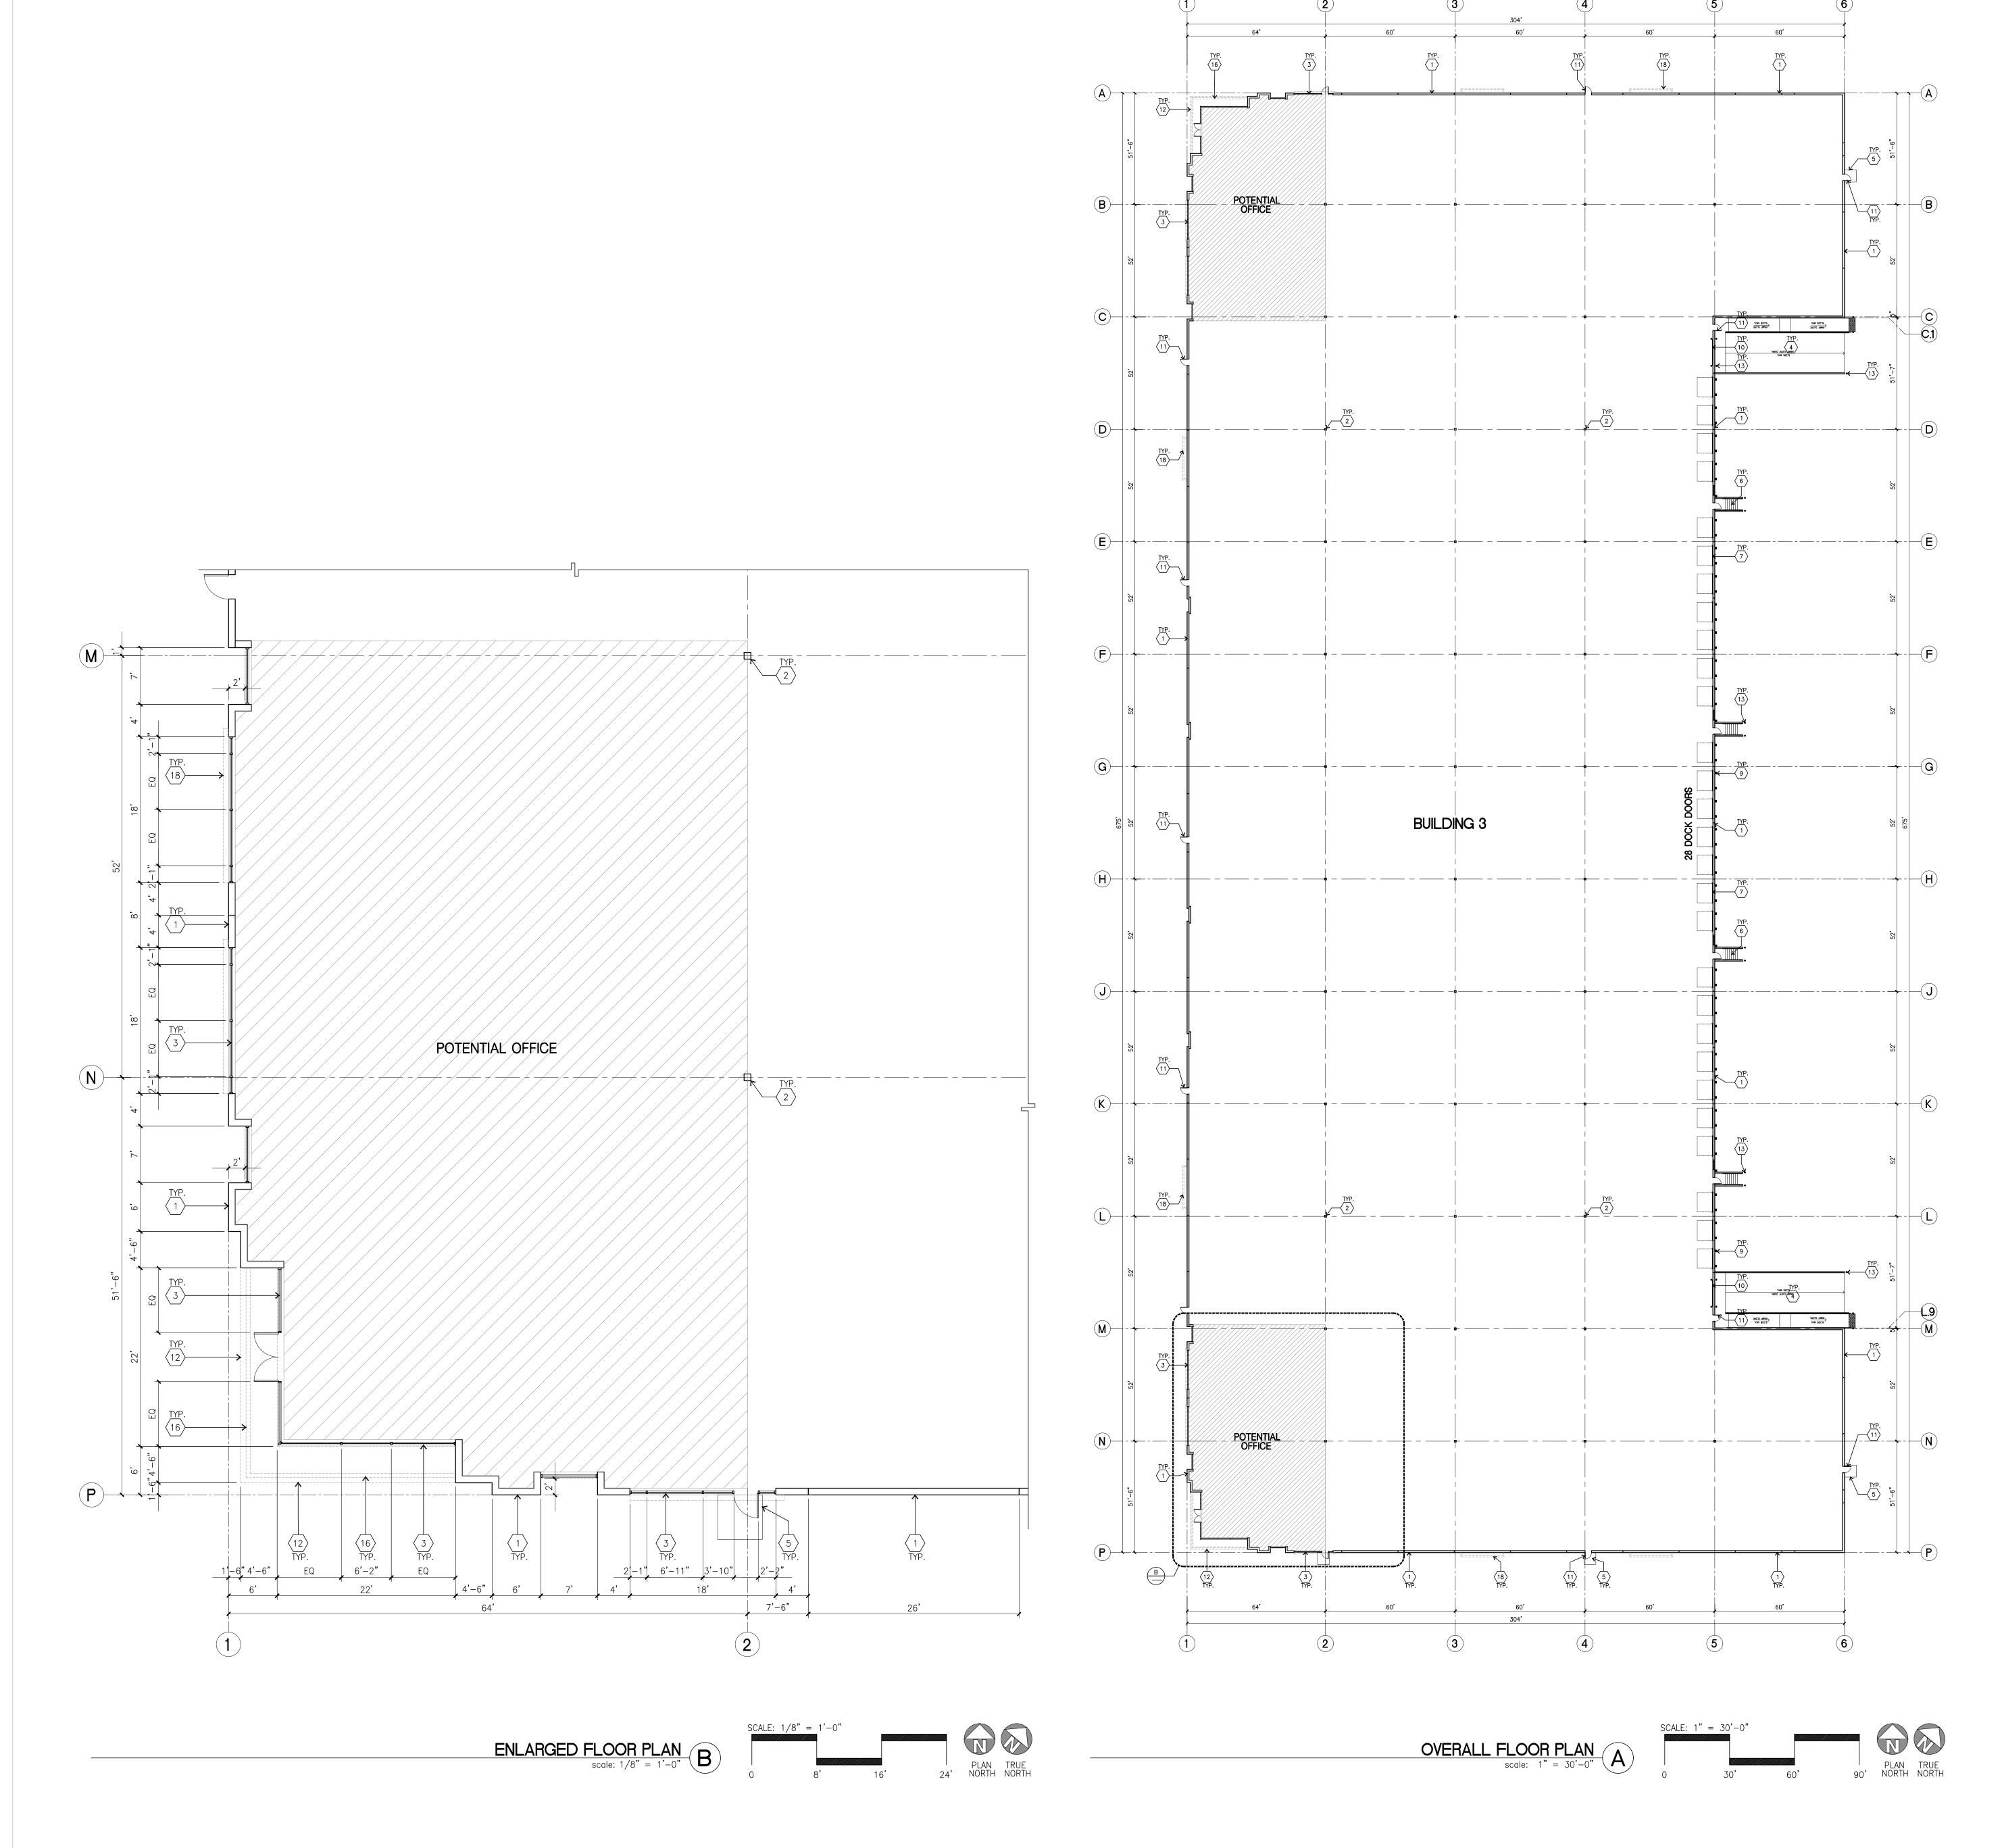

1 CONCRETE TILT-UP PANEL.

2 STRUCTURAL STEEL COLUMN.

TYPICAL STOREFRONT SYSTEM WITH GLAZING. SEE OFFICE BLOW-UP AND ELEVATIONS FOR SIZE, COLOR AND LOCATIONS.

CONCRETE RAMP W/ 42"HIGH CONC TILT-UP GUARD WALL OR BUILDING WALL ON BOTH SIDE OF RAMP.

5 5'-6" x 5'-6" x 4" THICK CONCRETE EXTERIOR LANDING PAD TYP. AT ALL EXTERIOR MAN DOORS TO LANDSCAPED AREAS. FINISH TO BE MEDIUM

BROOM FINISH.

6 EXTERIOR CONCRETE STAIR.

 $\sqrt{7}$ 9' x 10' TRUCK DOOR, SECTIONAL O.H., STANDARD GRADE.

 $\left\langle \begin{array}{c} 7 \\ 8 \end{array} \right
angle$ 9' x 10' TRUCK DOOR, SECTIONAL 0.1

9 DOCK DOOR BUMPER TYPICAL.

10 12' X 14' DRIVE THRU. SECTIONAL O.H., STANDARD GRADE.

11 3' X 7' HOLLOW METAL EXTERIOR MAN DOOR.

12 SOFFIT LINE ABOVE

 $\langle 13 \rangle$ CONC. FILLED GUARD POST. 6" DIA. U.N.O. AT 42"H. $\langle 14 \rangle$ EXTERIOR DOWNSPOUT WITH 2 OVERFLOW SCUPPER.

 $\langle 15 \rangle$ Z GUARD.

16 METAL CANOPY ABOVE.

 $\langle 17 \rangle$ NOT USED.

INTERIOR ROOF DRAIN.

(18) METAL POP OUT HORIZONTAL FACADE ABOVE
(19) 42" CONCRETE GUARDWALL

FLOOR PLAN GENERAL NOTES

1. THIS BUILDING IS DESIGNED FOR HIGH PILE STORAGE WITH FIRE ACCESS MAN DOORS AT APPROXIMATELY 100' +/-. A SEPARATE PERMIT WILL BE REQUIRED FOR ANY RACKING/CONVEYER SYSTEMS. INSURE HEAT AND SMOKE VENTS AS REQ'D COMPLY WITH TABLE 910.3 CBC.

2. FIRE HOSE LOCATIONS SHALL BE APPROVED PER FIRE DEPARTMENT.

3. SEE "C" DRAWINGS FOR FINISH SURFACE ELEVATIONS.

4. WAREHOUSE INTERIOR CONCRETE WALLS ARE PAINTED WHITE. COLUMNS ARE TO RECEIVE PRIMER ONLY. ALL GYP. BD. WALLS IN WAREHOUSE TO RECEIVE 1 COAT OF WHITE TO COVER.

5. SLOPE POUR STRIP 1/2" TO EXTERIOR AT ALL MANDOOR EXITS. SEE "S" DRAWINGS FOR POUR STRIP LOCATION.

6. ALL DIMENSIONS ARE TO THE FACE OF CONCRETE PANEL WALL, GRID LINE, OR FACE OF STUD U.N.O.

OR FACE OF STUD U.N.O.

7. PROVIDE 6" DIA. CONCRETE BOLLARD AT ALL FIRE RISER AND UNPROTECTED

8. SEE CIVIL DRAWINGS FOR POINT OF CONNECTIONS TO OFF-SITE UTILITIES. CONTRACTOR TO VERIFY ACTUAL UTILITY LOCATIONS. PLUMBING/ELECTRICAL COORDINATION.

9. FOR DOOR TYPES AND SIZES, SEE DETAIL SHEET A5.1. NOTE: ALL DOORS PER DOOR SCHEDULE ARE FINISH OPENINGS.

10. CONTRACTOR TO PROTECT AND KEEP THE FLOOR SLAB CLEAN. ALL EQUIPMENT TO BE DIAPERED INCLUDING CARS AND TRUCKS.

11. ALL EXIT MAN DOORS IN WAREHOUSE TO HAVE ILLUMINATED EXIT SIGN W/PANIC HARDWARE.

12. HIGHLY FLAMMABLE AND COMBUSTIBLE MATERIAL SHALL NOT BE USED OR STORED IN THIS BUILDING.13. EACH EXTERIOR EXIT DOOR SHALL BE IDENTIFIED BY A TACTILE EXIT SIGN

WITH THE WORDS "EXIT". THE MOUNTING HEIGHT FOR SUCH SIGNAGE SHALL BE 60" FROM FINISH FLOOR LEVEL TO THE CENTER OF THE SIGN.

14. FFIX AN INTERNATIONAL ACCESSIBILITY SYMBOL ON ALL ACCESSIBLE ENTRANCES AND ALL INTERIOR AND EXTERIOR WALKING SURFACES TO BE NON-SLIP TYP.

15. NON-ACCESSIBLE DOOR. PROVIDE WARNING SIGN LOCATED IN THE INTERIOR SIDE PER CBC 11B-703.5

16. ALL ROOF MOUNTED MATERIALS SHALL BE FULLY SCREENED FROM PUBLIC VIEW, SEE A/A4.1 OFFICE SECTION.

FLOOR SLAB & POUR STRIPS REQ.

THESE NOTES ARE VERY MIN. REQUIREMENT. SEE "S" DWGS FOR ADDITIONAL REQUIREMENTS

1. FLOOR COMPACTION - 95%

2. TRENCH COMPACTION — 90%
3. BUILDING FLOOR SLAB: SEE STRUCTURAL DRAWINGS.

4. CONTRACTOR TO BUILD FOR CLASS V FLOOR PER A.C.I. 302-IR-96 5. CONCRETE SLAB TO HAVE STEEL FLOAT HARD TROWEL BURNISHED FINISH.

6. CONTRACTOR TO CURE SLAB TO BE WET CURING USING BURLINE FOR 7 DAYS MIN.

7. ALL EQUIPMENT & MOVING VEHICLES SHALL BE DIAPERED.

8. NO CRANES, CONCRETE TRUCKS, OR ANYTHING HEAVIER WILL BE PLACED ON

9. SLAB TO BE FF50 FL35 MEASURED WITHIN 24 HOURS. 10. NO FLY ASH IN THE CONCRETE

12. SEAL CONCRETE SLAB W/ "LIPIDOLITH" SEALER

11. WHERE INDICATED, PROVIDE VAPOR BARRIER (15MIL STEGO
OR EQUAL) UNDER THE CONCRETE SLAB. PROVIDE SAND
PER SOILS ENGINEER OR MANUFACTURER'S RECOMMENDATION.
CONCRETE SLAB IN FUTURE OFFICE AREAS, WHERE SAND OVER VIQUEEN ARE
REQUIRED, SHALL BE NATURALLY HYDRATED WITHOUT USE OF BURLENE, CURING
COMPOUND, OR RELEASE AGENTS. CONTROL/CONSTRUCTION JOINTS SHALL NOT
BE FILLED WITH MM—80 JOINT FILLER IN FUTURE OFFICE AREAS.

13. 10' POUR STRIP AT TRUCK DOOR. 4FT. MAX. ELSEWHERE.
 14. ALL FLOOR SLAB NAIL OR BRACE FRAME HOLES FILLED WITH APPROVED 2 PART EPOXY COMPOUND TO MATCH CONCRETE COLOR. PEGA BOND LV 2000, BURKE EPOXY INJECTION RESIN OR EQUAL.

15. PROVIDE FIRE EXTINGUISHERS PER FIRE DEPARTMENT REQUIREMENT.

16. MM-80 AT SPEED BAY ONLY



hpa, inc.

18831 bardeen avenue - ste.

#100 irvine, ca

92612

tel: 949 •863 •1770

fax: 949 • 863 • 0851

email: hpa@hparchs.com

Owner:

DAWSON

CANYON LLC.

11777 San Vicente Blvd, Ste. 780 Los Angeles, CA 90049 tel: (949) 296-7006 fax: (949) 842-3074

TEMESCAL VALLEY
COMMERCE CENTER

DAWSON CANYON RD. CORONA, CA 92883

THIENES

Mechanical: TBD

Plumbing: TBD

Electrical: TBD

Landscape: HUNTER LANDSCAPE

Structural:

Fire Protection:
Soils Engineer: DCW


Title: Overall Floor Plan


Project Number: 192


Drawn by: 11/10


Date:
Revision:

3-DAB-A2

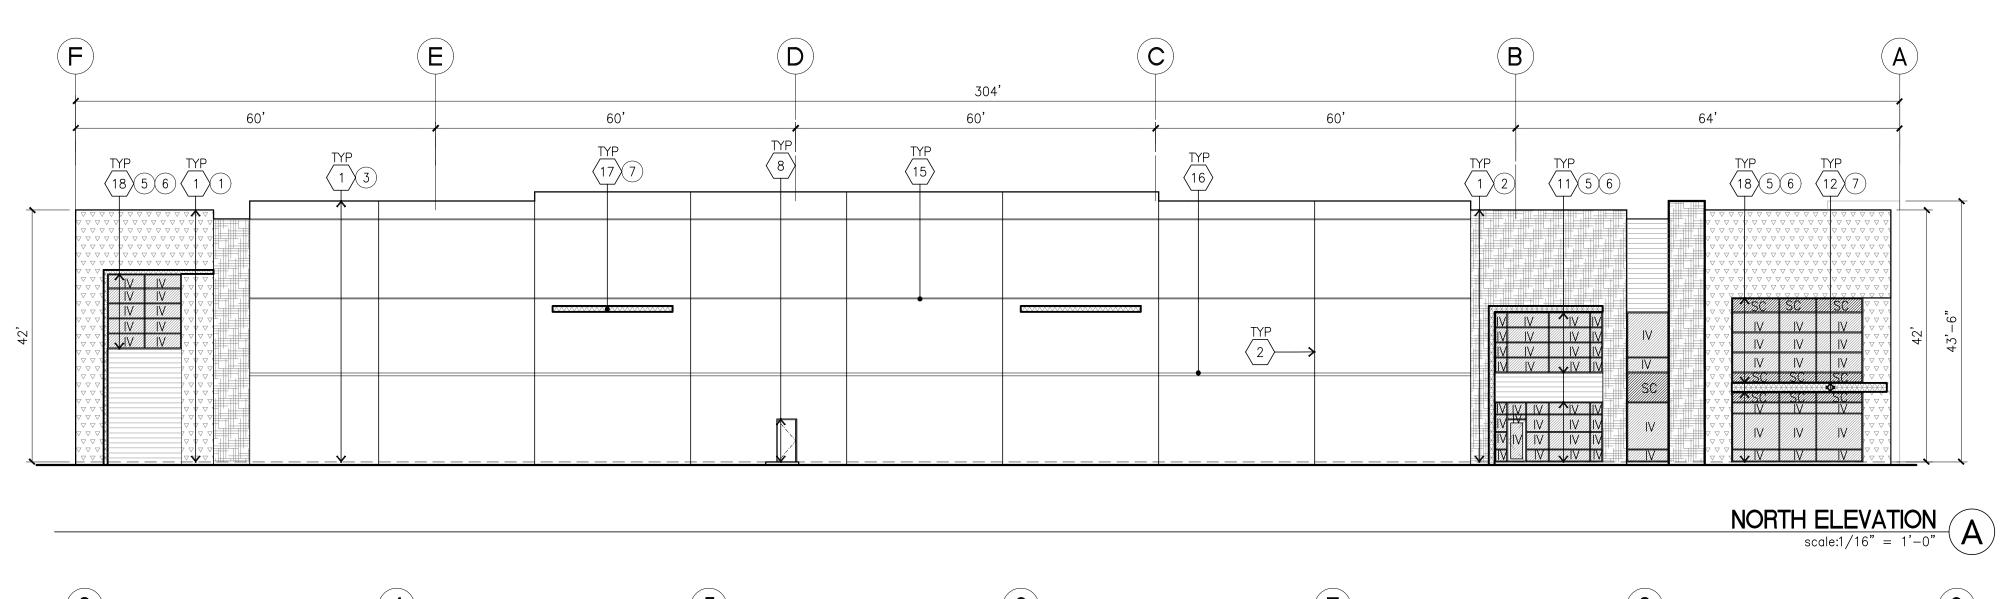

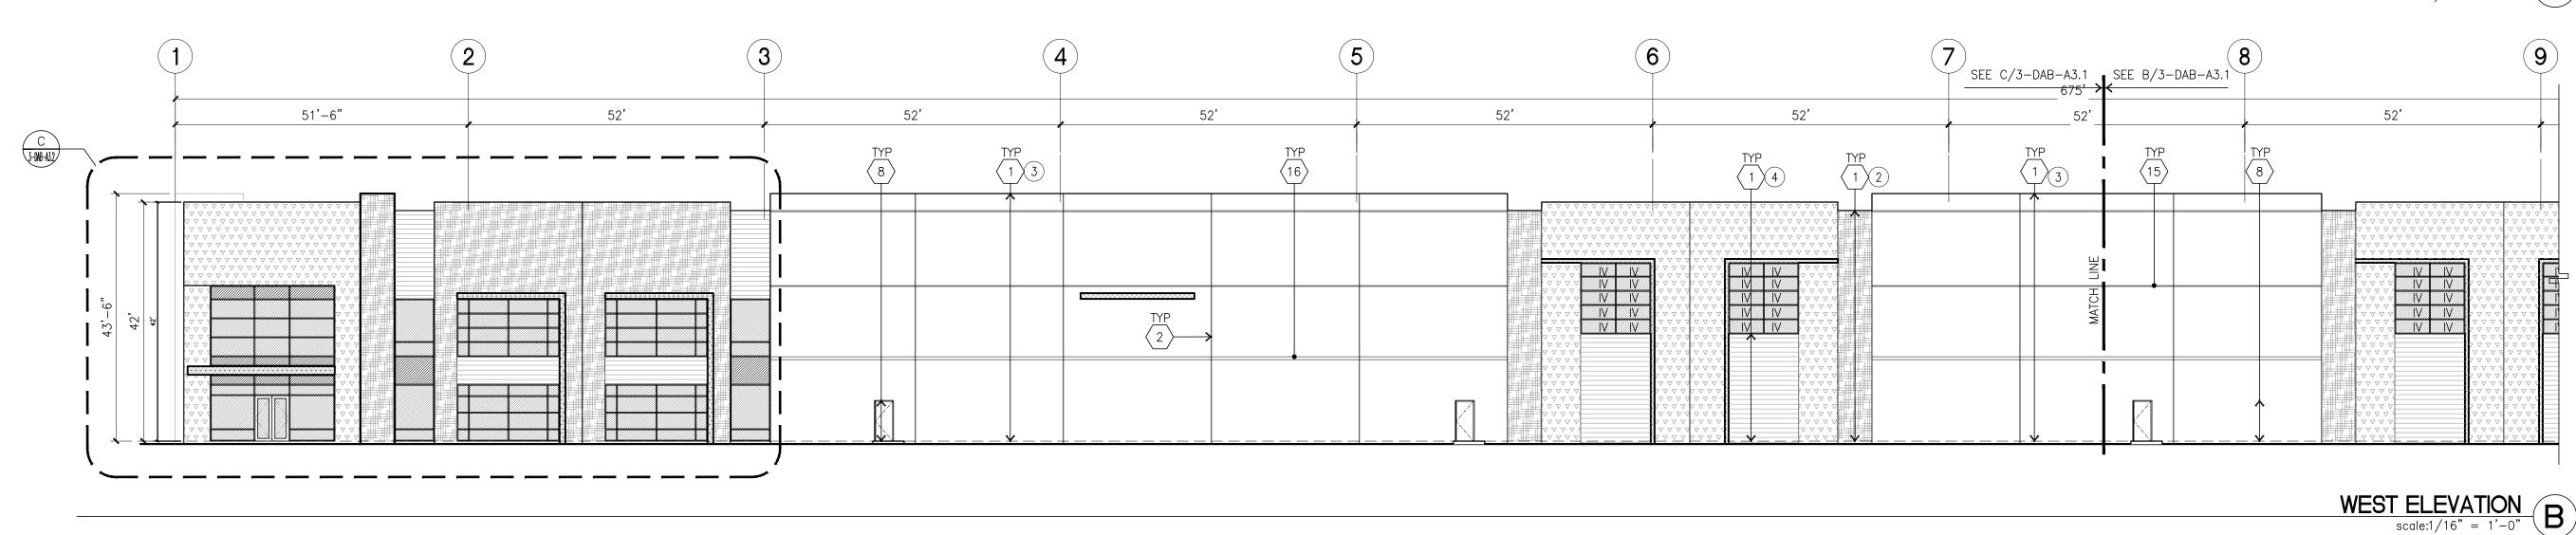

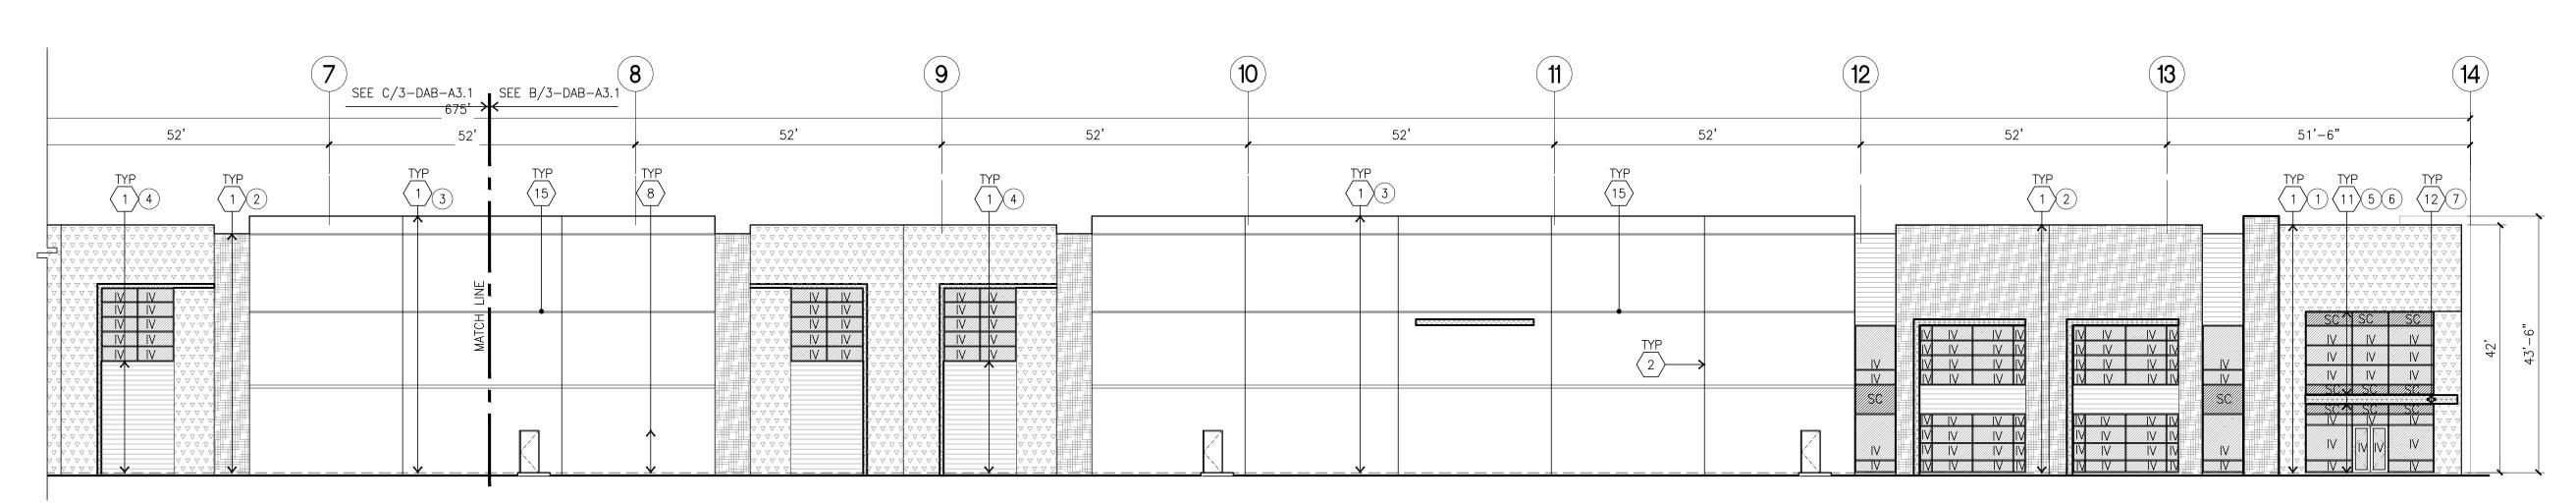

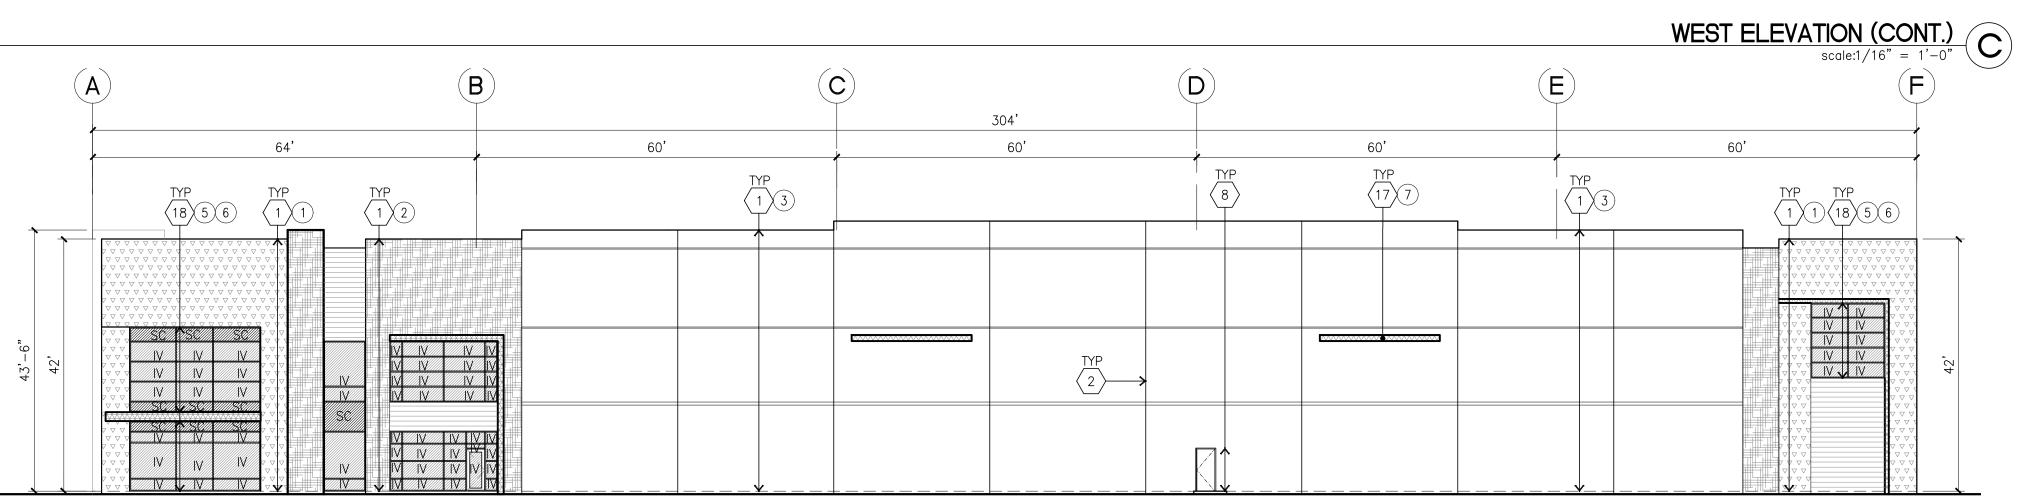

SOUTH ELEVATION D

ELEVATION KEYNOTES

 \langle 1 \rangle CONCRETE TILT-UP PANEL.

 $\langle 2 \rangle$ PANEL JOINT.

 \langle 3 \rangle NOT USED.

4 12' X 14' OVERHEAD DOOR @ DRIVE THRU. PROVIDE COMPLETE $\stackrel{+}{\searrow}$ WEATHER-STRIPPING PROTECTION ALL AROUND.

9' X 10' OVERHEAD DOOR @ DRIVE THRU. PROVIDE COMPLETE WEATHER-STRIPPING PROTECTION ALL AROUND.

6 CONCRETE STAIR, LANDING AND GUARDRAIL W/ METAL PIPE HANDRAIL. PROVIDE NON SKID NOSING TO MEET ADA REQUIREMENTS. PROVIDE CONTRASTING COLORED 3" WIDE WARNING STRIPE INTEGRAL TO CONCRETE AT TOP LANDING AND BOTTOM TREAD PER ADA REQUIREMENTS. 7 4' X 8' METAL LOUVER OPENING FOR VENTILATION. PAINT TO MATCH

 \angle BUILDING COLOR. 8 HOLLOW METAL DOORS. PROVIDE COMPLETE WEATHER STRIPING ALL AROUND DOOR.

 \langle 9 \rangle EXTERIOR DOWN SPOUTS W/ 2 OVERFLOW SCUPPERS.

0 DOCK DOOR BUMPER TYPICAL. ALUMINUM STOREFRONT FRAMING WITH TEMPERED GLAZING AT ALL DOORS, SIDELITES ADJACENT TO DOORS AND GLAZING WITH BOTTOMS LESS THAN 18" ABOVE FINISH FLOOR ELEVATION. $\langle 12 \rangle$ METAL CANOPY.

 $\langle 13 \rangle$ INTERIOR ROOF DRAIN W/ 2 OVERFLOW SCUPPERS.

(14) CONC. FILLED GUARD POST. 6" DIA. U.N.O. AT 42"H.

2" HORIZONTAL REVEAL WITH 3/8" CHAMFER. REVEAL COLOR TO MATCH ADJACENT BUILDING FIELD COLOR. U.N.O.

6" HORIZONTAL REVEAL WITH 3/8" CHAMFER. REVEAL COLOR TO MATCH ADJACENT BUILDING FIELD COLOR. U.N.O. $\langle 17 \rangle$ METAL POP OUT HORIZONTAL FACADE ABOVE

(18) ALUMINUM STOREFRONT FRAMING WITH GLAZING

ELEVATION GENERAL NOTES

1. ALL PAINT COLOR CHANGES TO OCCUR AT INSIDE CORNERS UNLESS NOTED OTHERWISE.

2. ALL PAINT FINISHES ARE TO BE FLAT UNLESS NOTED OTHERWISE.

3. T.O.P. EL.= TOP OF PARAPET ELEVATION.

4. F.F. = FINISH FLOOR ELEVATION.

5. STOREFRONT CONSTRUCTION: GLASS, METAL ATTACHMENTS AND LINTELS SHALL BE DESIGNED TO RESIST - MPH. EXPOSURE "C" WINDS. CONTRACTOR SHALL SUBMIT SHOP DRAWINGS PRIOR TO INSTALLATION.

6. CONTRACTOR SHALL FULLY PAINT ONE CONCRETE PANEL W/ SELECTED COLORS. ARCHITECT AND OWNER SHALL APPROVE PRIOR TO PAINTING REMAINDER OF BUILDING.

7. BACK SIDE OF PARAPETS TO HAVE SMOOTH FINISH AND BE PAINTED WITH

8. FOR SPANDREL GLAZING, ALLOW SPACE BEHIND SPANDREL TO BREATH.

PROVIDE 1" DIAMETER HOLES AT CONCRETE WALL. 9. USE ADHESIVE BACK WOOD STRIPS FOR ALL REVEAL FORMS.

10. THE FIRST COAT OF PAINT TO BE ROLLED—ON AND THE SECOND COAT TO BE SPRAYED—ON 11. ALL ROLL-UP DOORS AND SERVICE DOORS TO BE PAINTED TO MATCH BUILDING COLOR.

ELEVATION COLOR LEGEND/SCHED.

PAINT. COLOR: SW 7525 TREE BRANCH (288C7)

PAINT. COLOR: SW 7638 JOGGING PATH (247-C2)

PAINT. COLOR: SW 9166 DRIFT OF MIST (238-C2) PAINT. COLOR: SW METAL PANEL - LONGBOARD LIGHT BAMBOO

MULLIONS COLOR : CLEAR ANODIZED

GLAZING COLOR : BLUE REFLECTIVE

METAL CANOPY WITH DUNN EDWARDS DEA 160 HOPE CHEST

GLAZING LEGEND

NOTE: ALL EXTERIOR AND INTERIOR GLAZING SHALL BE TEMPERED.

SPANDREL GLASS
WITH CONCRETE BEHIND INSULATED VISION GLASS

SINGLE LITE VISION GLASS

IV: INSULATED VISION GLASS

1/4" VISTACOOL PACIFICA + 1/4" SOLARBAN 60 CLEAR

1" INSULATED GLASS UNIT WITH 1/2" AIRSPACE AND 1/4" LITES

U: 0.27 SHGC: 0.21 VLT: 26%

MINIMUM VT TO BE 0.42 PER 2016 CEC TABLE 140.3—B

SC: SPANDREL WITH CONCRETE BEHIND 1/4" VISTACOOL PACIFICA WITH WARM GRAY OPACICOAT PAINTED ON REFLECTIVE. INSTALLED ON CONCRETE.

V : VISION GLASS 1/4" VISTACOOL PACIFICA

MULLIONS : ANODIZED CLEAR.



hpa, inc. 18831 bardeen avenue - ste. #100 irvine, ca tel: 949 •863 •1770 fax: 949 • 863 • 0851 email: hpa@hparchs.com



11777 San Vicente Blvd, Ste. 780 Los Angeles, CA 90049 tel: (949) 296-7006 fax: (949) 842-3074

TEMESCAL VALLEY COMMERCE CENTER

> DAWSON CANYON RD. CORONA, CA 92883



DCW3

TBD Mechanical: TBD Plumbing: TBD Electrical: Landscape: HUNTER LANDSCAPE Fire Protection:


Structural:


Soils Engineer:


Title: Elevations

Project Number: Drawn by: 11/10/22 Date:

Revision:

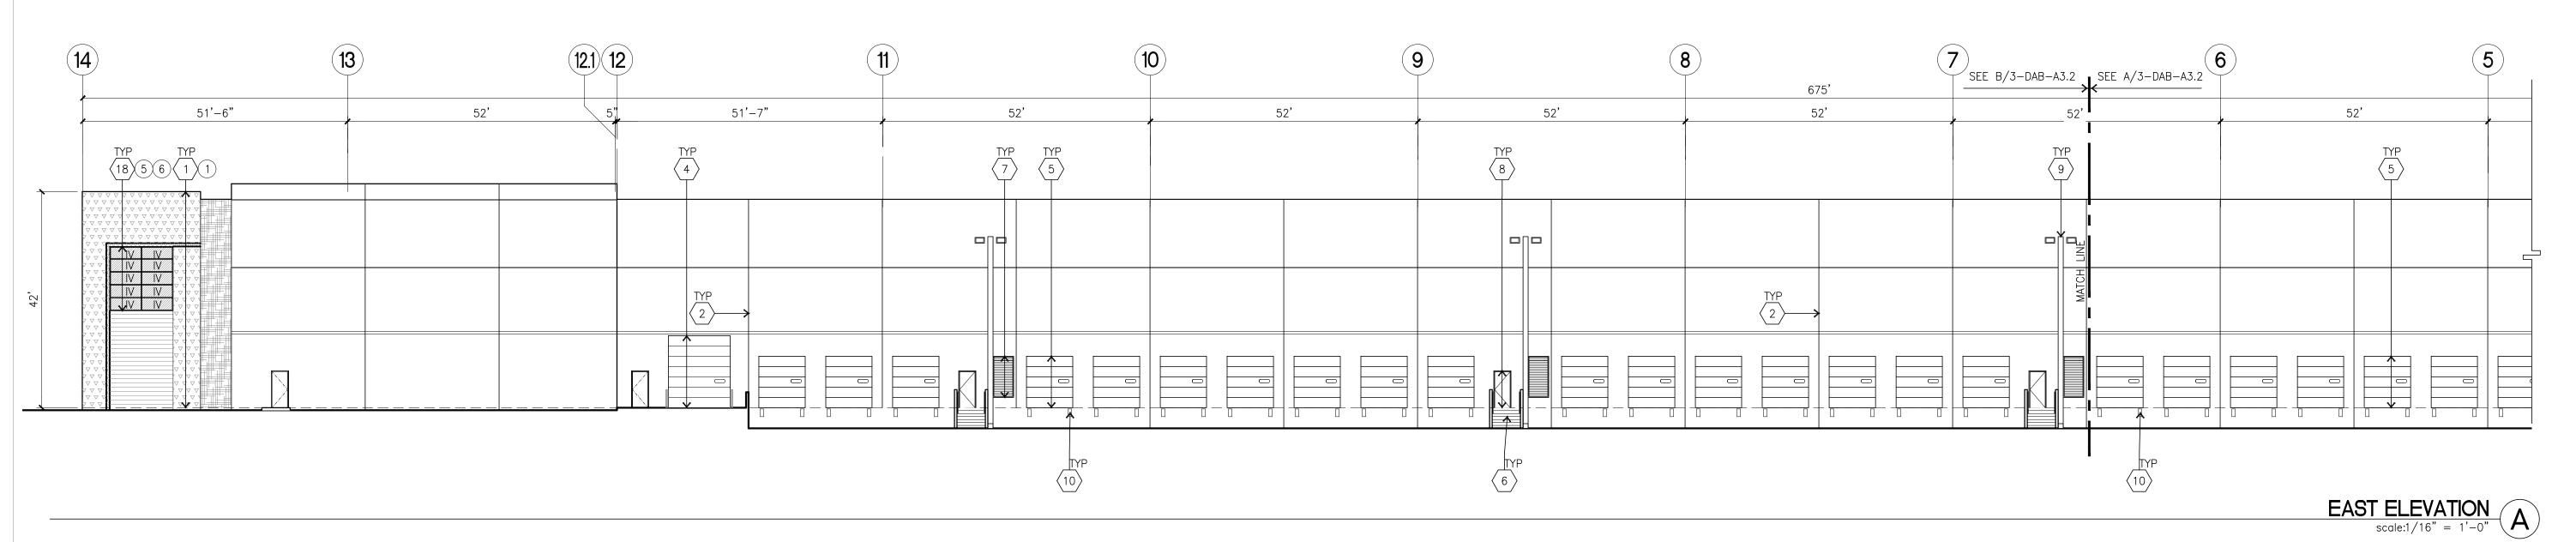

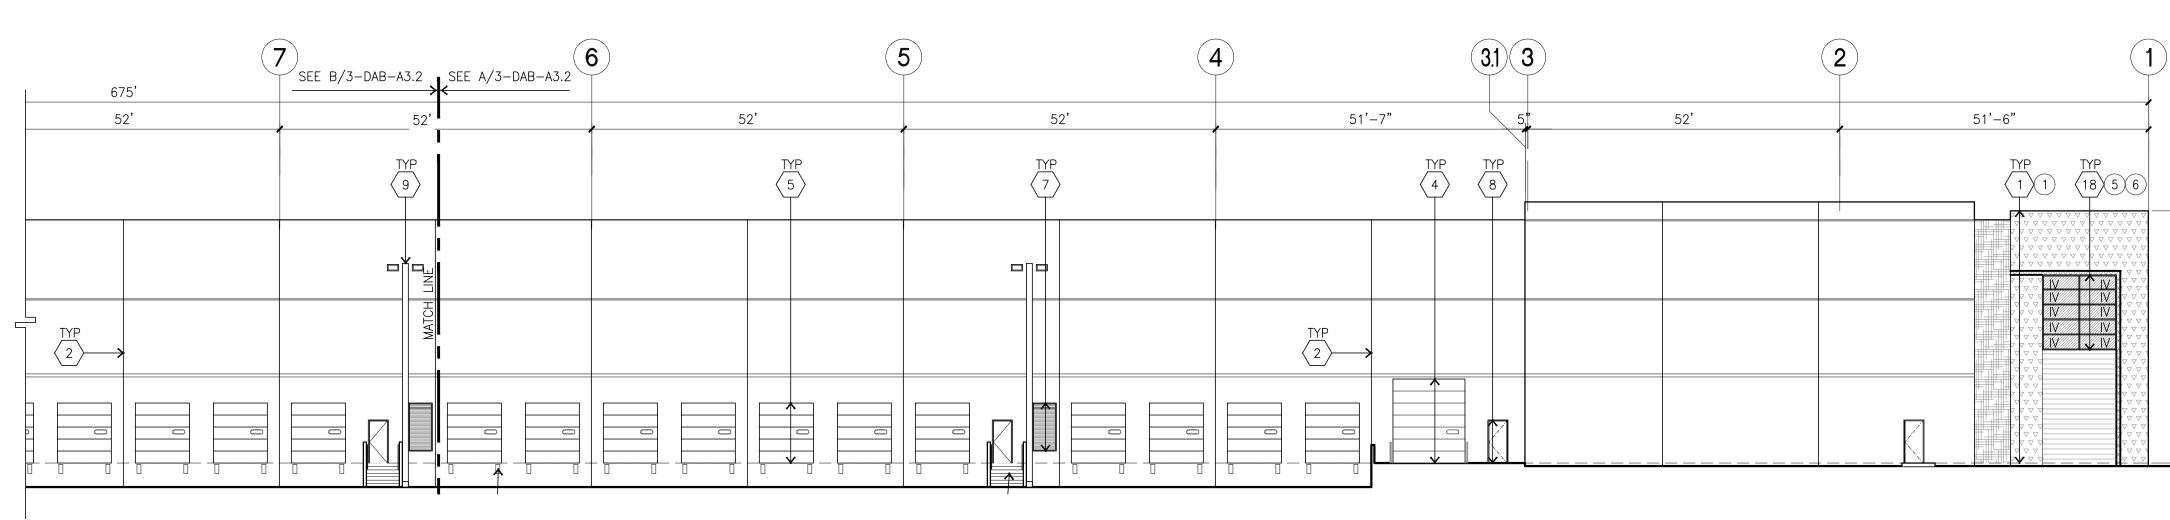

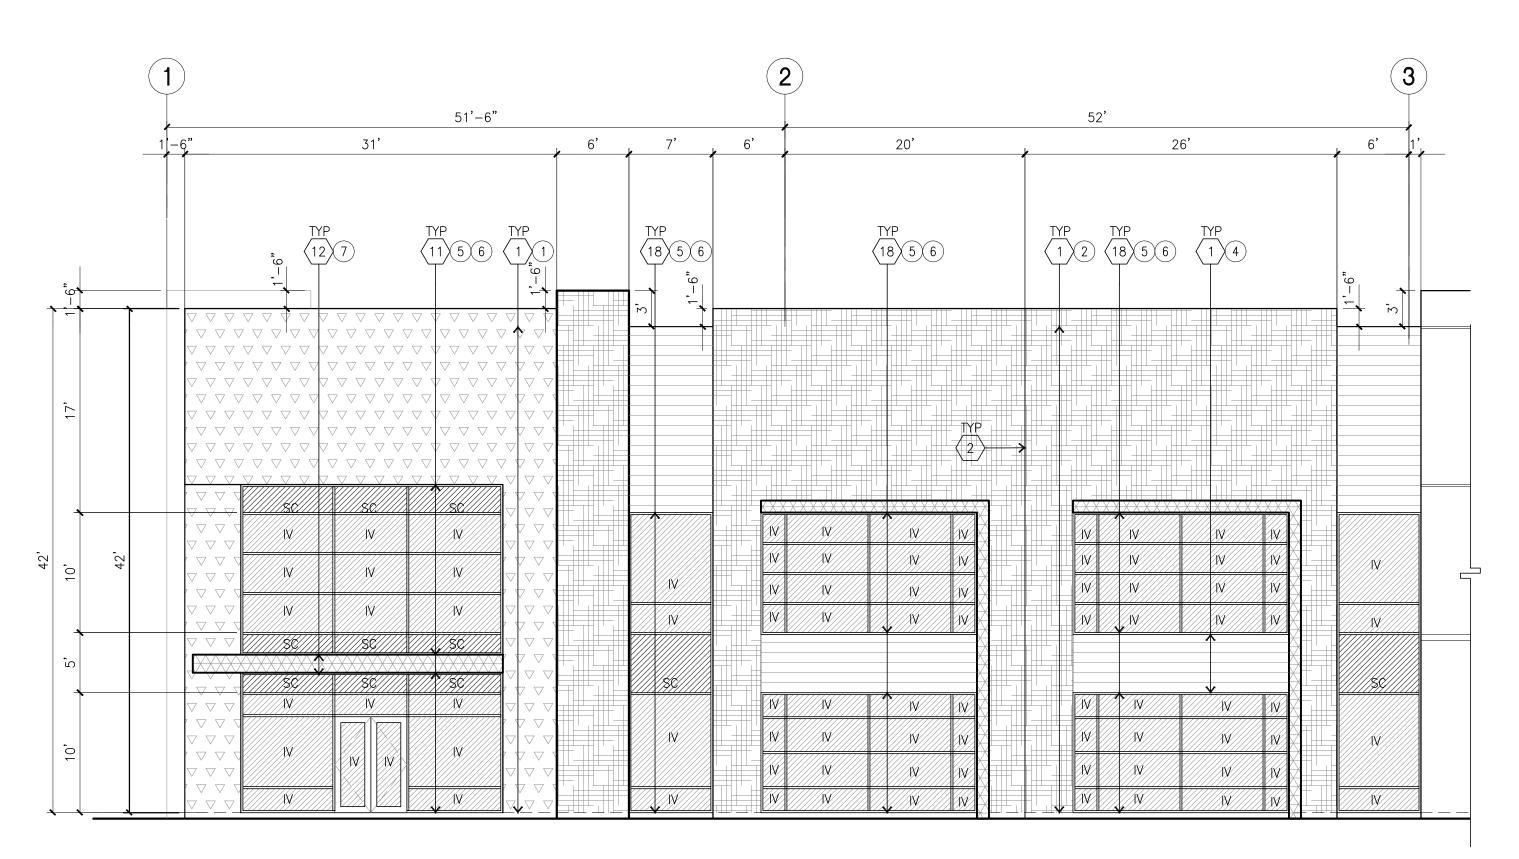

ENLARGED WEST ELEVATION

scale: 1/8" = 1'-0"

EAST ELEVATION (CONT.)

scale:1/16" = 1'-0"

ELEVATION KEYNOTES

 \langle 1 \rangle CONCRETE TILT-UP PANEL.

 $\langle 2 \rangle$ PANEL JOINT.

 $\langle 3 \rangle$ NOT USED.

12' X 14' OVERHEAD DOOR @ DRIVE THRU. PROVIDE COMPLETE ✓ WEATHER—STRIPPING PROTECTION ALL AROUND.

9' X 10' OVERHEAD DOOR @ DRIVE THRU. PROVIDE COMPLETE WEATHER-STRIPPING PROTECTION ALL AROUND.

6 CONCRETE STAIR, LANDING AND GUARDRAIL W/ METAL PIPE HANDRAIL. PROVIDE NON SKID NOSING TO MEET ADA REQUIREMENTS. PROVIDE CONTRASTING COLORED 3" WIDE WARNING STRIPE INTEGRAL TO CONCRETE AT TOP LANDING AND BOTTOM TREAD PER ADA REQUIREMENTS. 7 4' X 8' METAL LOUVER OPENING FOR VENTILATION. PAINT TO MATCH

BUILDING COLOR. 8 HOLLOW METAL DOORS. PROVIDE COMPLETE WEATHER STRIPING ALL AROUND DOOR.

 \langle 9 \rangle EXTERIOR DOWN SPOUTS W/ 2 OVERFLOW SCUPPERS.

10 DOCK DOOR BUMPER TYPICAL. ALUMINUM STOREFRONT FRAMING WITH TEMPERED GLAZING AT ALL DOORS, 18" ABOVE FINISH FLOOR ELEVATION.

 $\langle 12 \rangle$ METAL CANOPY.

 $\langle 13 \rangle$ INTERIOR ROOF DRAIN W/ 2 OVERFLOW SCUPPERS.

(14) CONC. FILLED GUARD POST. 6" DIA. U.N.O. AT 42"H. 2" HORIZONTAL REVEAL WITH 3/8" CHAMFER. REVEAL COLOR TO MATCH ADJACENT BUILDING FIELD COLOR. U.N.O.

6" HORIZONTAL REVEAL WITH 3/8" CHAMFER. REVEAL COLOR TO MATCH ADJACENT BUILDING FIELD COLOR. U.N.O.

17 METAL POP OUT HORIZONTAL FACADE ABOVE $\langle 18 \rangle$ ALUMINUM STOREFRONT FRAMING WITH GLAZING

ELEVATION GENERAL NOTES

1. ALL PAINT COLOR CHANGES TO OCCUR AT INSIDE CORNERS UNLESS NOTED

2. ALL PAINT FINISHES ARE TO BE FLAT UNLESS NOTED OTHERWISE.

3. T.O.P. EL.= TOP OF PARAPET ELEVATION.

4. F.F. = FINISH FLOOR ELEVATION.

5. STOREFRONT CONSTRUCTION: GLASS, METAL ATTACHMENTS AND LINTELS SHALL BE DESIGNED TO RESIST - MPH. EXPOSURE "C" WINDS. CONTRACTOR SHALL SUBMIT SHOP DRAWINGS PRIOR TO INSTALLATION.

6. CONTRACTOR SHALL FULLY PAINT ONE CONCRETE PANEL W/ SELECTED COLORS. ARCHITECT AND OWNER SHALL APPROVE PRIOR TO PAINTING REMAINDER OF BUILDING.

7. BACK SIDE OF PARAPETS TO HAVE SMOOTH FINISH AND BE PAINTED WITH

8. FOR SPANDREL GLAZING, ALLOW SPACE BEHIND SPANDREL TO BREATH. PROVIDE 1" DIAMETER HOLES AT CONCRETE WALL.

9. USE ADHESIVE BACK WOOD STRIPS FOR ALL REVEAL FORMS.

10. THE FIRST COAT OF PAINT TO BE ROLLED-ON AND THE SECOND COAT TO BE SPRAYED-ON

11. ALL ROLL-UP DOORS AND SERVICE DOORS TO BE PAINTED TO MATCH BUILDING COLOR.

ELEVATION COLOR LEGEND/SCHED.

PAINT. COLOR: SW 7525 TREE BRANCH (288C7)

PAINT. COLOR: SW 7638 JOGGING PATH (247-C2)

PAINT. COLOR: SW 9166 DRIFT OF MIST (238-C2) PAINT. COLOR: SW METAL PANEL - LONGBOARD LIGHT BAMBOO

MULLIONS COLOR : CLEAR ANODIZED

GLAZING COLOR : BLUE REFLECTIVE

METAL CANOPY WITH DUNN EDWARDS DEA 160 HOPE CHEST

GLAZING LEGEND

NOTE: ALL EXTERIOR AND INTERIOR GLAZING SHALL BE TEMPERED.

SPANDREL GLASS WITH CONCRETE BEHIND INSULATED VISION GLASS

SINGLE LITE
VISION GLASS

IV: INSULATED VISION GLASS

1/4" VISTACOOL PACIFICA + 1/4" SOLARBAN 60 CLEAR

1" INSULATED GLASS UNIT WITH 1/2" AIRSPACE AND 1/4" LITES

U: 0.27 SHGC: 0.21 VLT: 26%

MINIMUM VT TO BE 0.42 PER 2016 CEC TABLE 140.3-B

SC : SPANDREL WITH CONCRETE BEHIND 1/4" VISTACOOL PACIFICA WITH WARM GRAY OPACICOAT PAINTED ON REFLECTIVE. INSTALLED ON CONCRETE.

V : VISION GLASS 1/4" VISTACOOL PACIFICA

MULLIONS : ANODIZED CLEAR.



hpa, inc. 18831 bardeen avenue - ste. #100 irvine, ca tel: 949 •863 •1770 fax: 949 • 863 • 0851 email: hpa@hparchs.com



11777 San Vicente Blvd, Ste. 780 Los Angeles, CA 90049 tel: (949) 296-7006 fax: (949) 842-3074

TEMESCAL VALLEY COMMERCE CENTER

> DAWSON CANYON RD. CORONA, CA 92883

THIENES

DCW3


Structural: TBD Mechanical: TBD Plumbing: TBD Electrical: Landscape: HUNTER LANDSCAPE Fire Protection:

Title: Elevations


Project Number: Drawn by: 11/10/22

Date: Revision:

Soils Engineer:

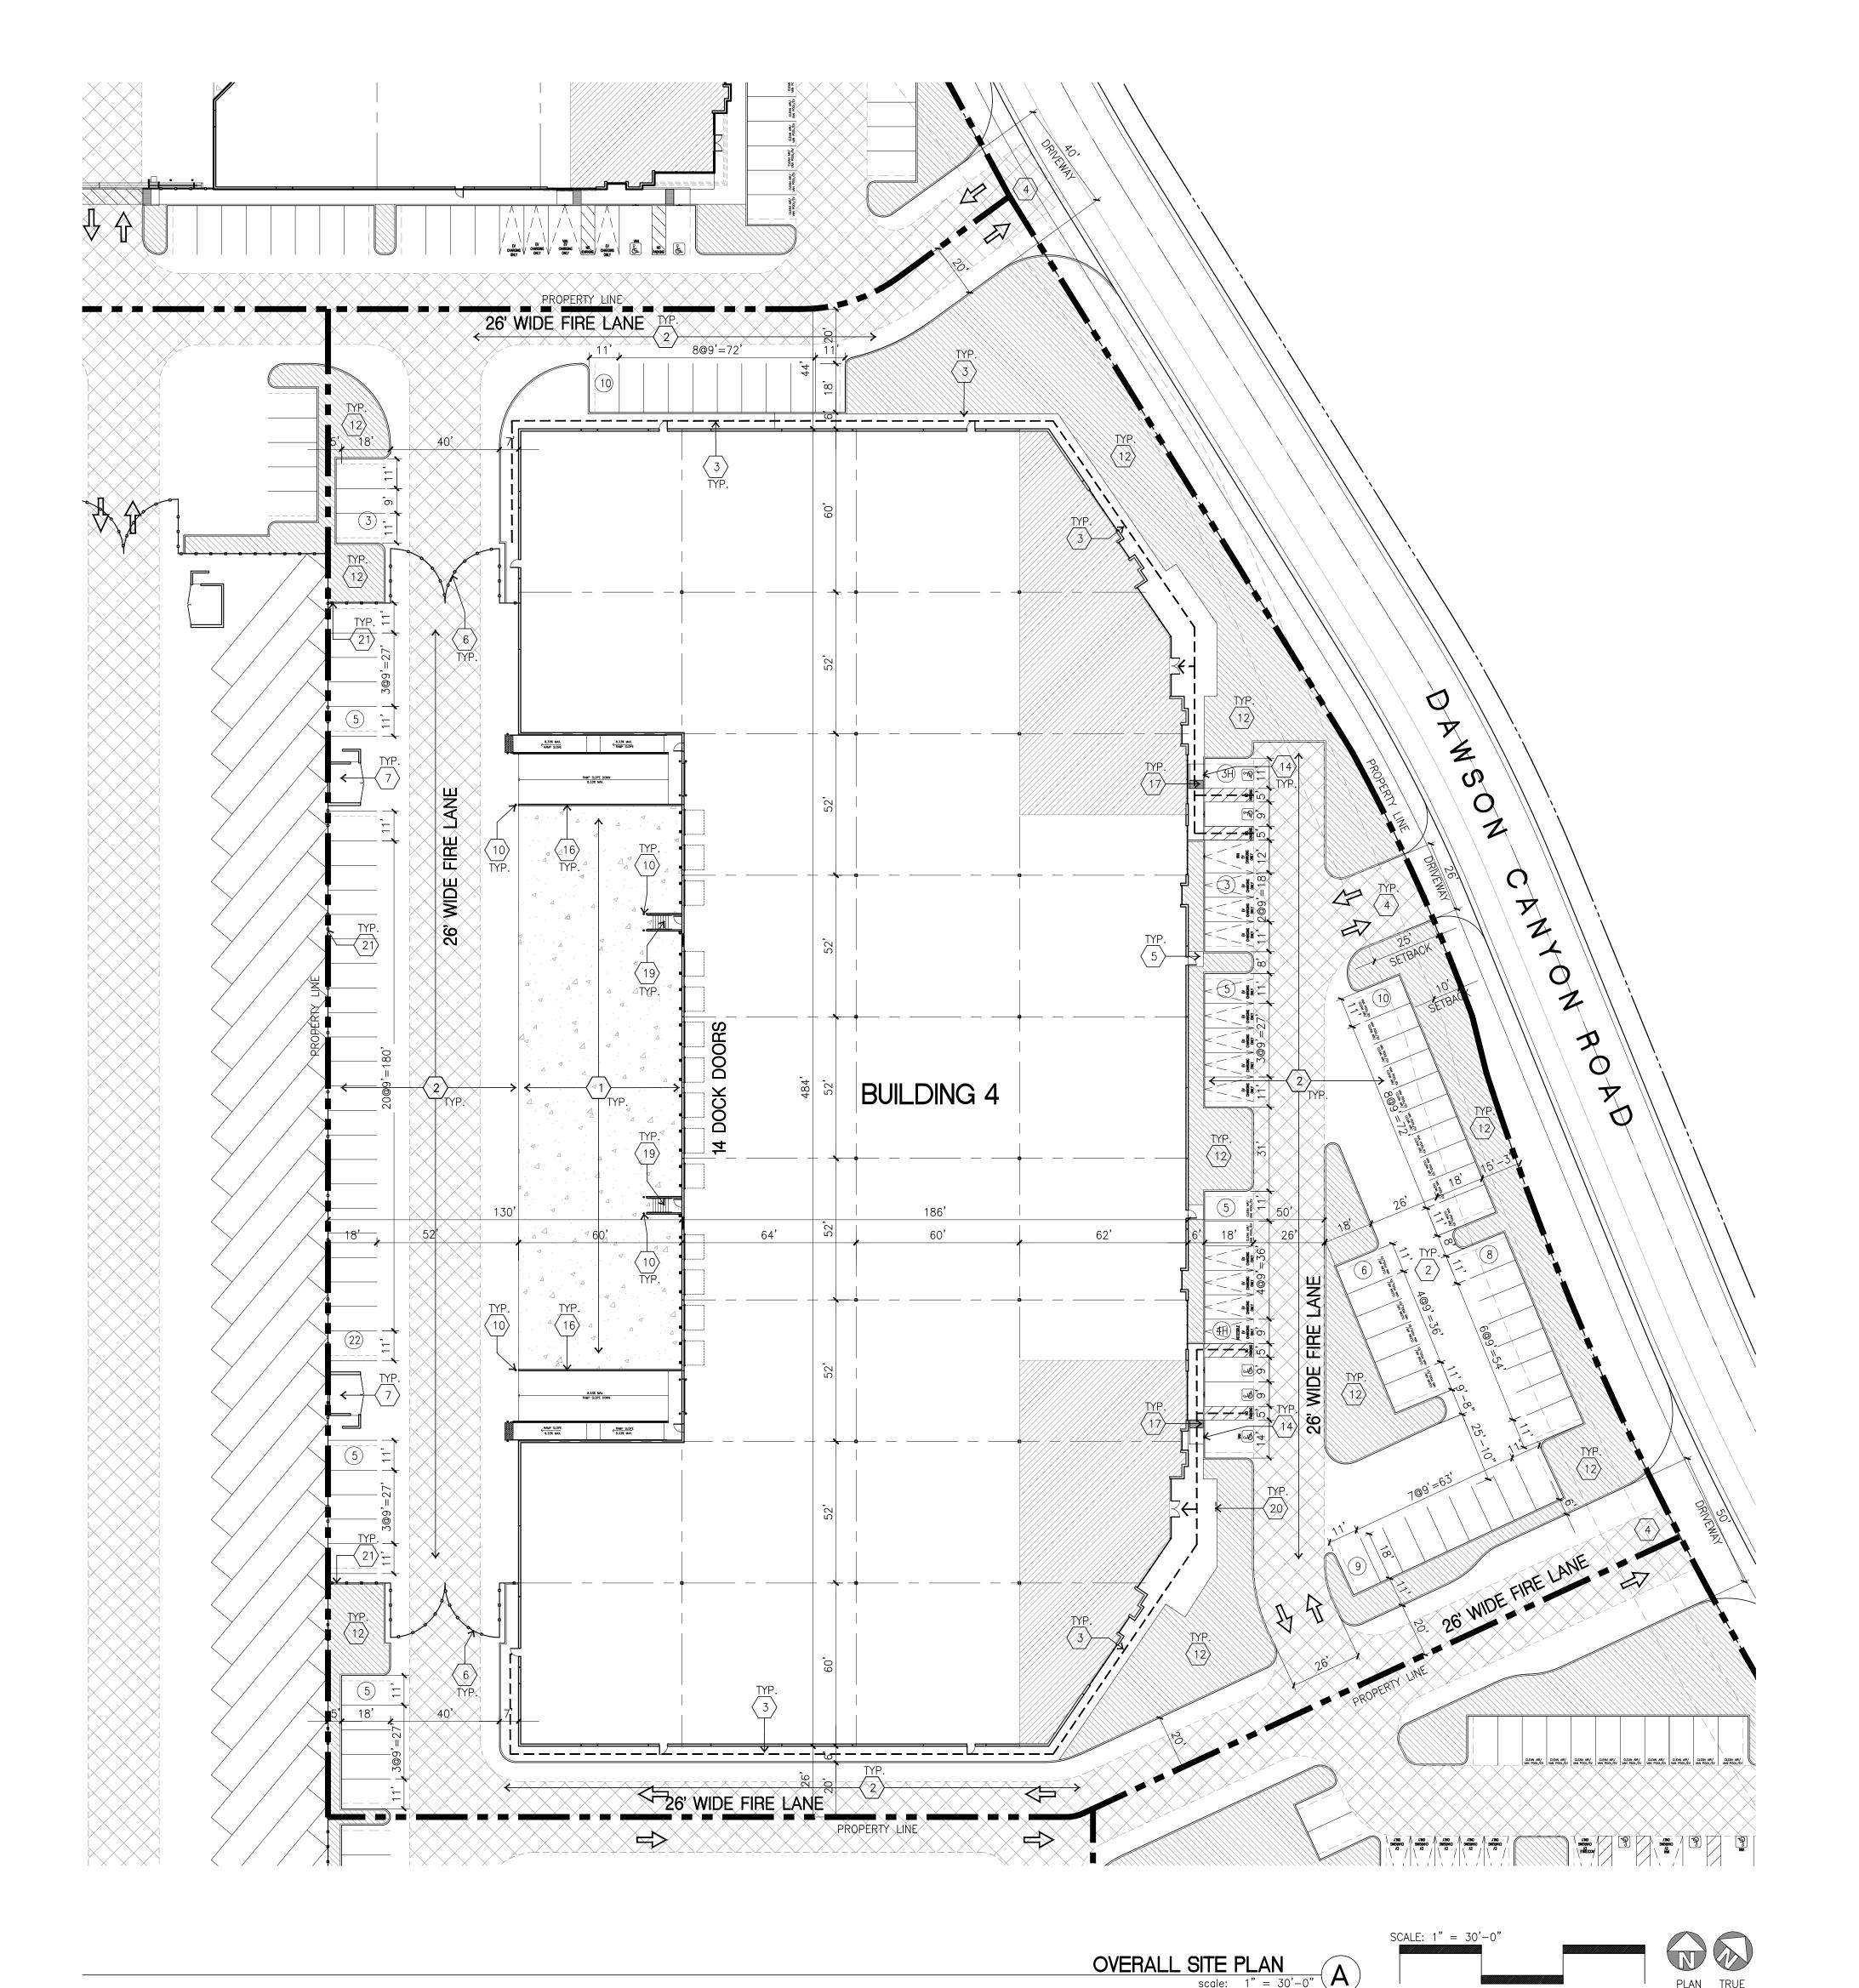

AERIAL MAP

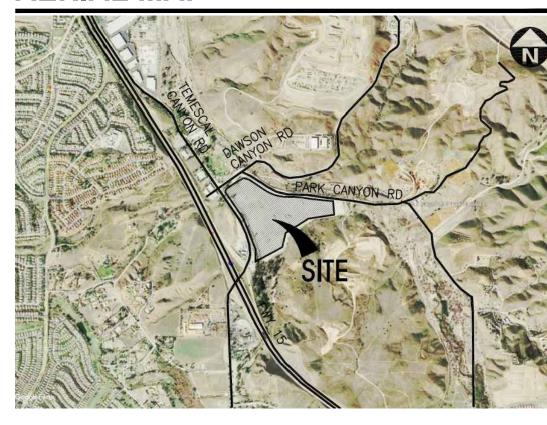

PROJECT INFORMATION

Code Analysis 2019 CALIFORNIA BUILDING CODE 2019 CALIFORNIA PLUMBING CODE 2019 CALIFORNIA MECHANICAL CODE 2019 CALIFORNIA ELECTRICAL CODE 2019 CALIFORNIA FIRE CODE 2019 CALIFORNIA GREEN BUILDING STANDARDS CODE 2019 CALIFORNIA ENERGY CODE

FIRE SPRINKLER BUILDING **Applicant's Representatives** 283-160-046 283-190-044 HPA, INC. 18831 BARDEEN AVE., SUITE 100

BUILDING OCCUPANCY : S-1 / B CONSTRUCTION TYPE : III-B

IRVINE, CA 92612 (949) 862-2161 (949) 863-0851 CONTACT: ANDY WIYANTO

THIS IS A CONCEPTUAL PLAN. IT IS BASED ON PRELIMINARY INFORMATION WHICH IS NOT FULLY VERIFIED AND MAY BE INCOMPLETE. IT IS MEANT AS A COMPARATIVE AID IN EXAMINING ALTERNATE DEVELOPMENT STRATEGIES AND ANY QUANTITIES INDICATED ARE SUBJECT TO REVISION AS MORE RELIABLE

INFORMATION BECOMES AVAILABLE.

LEGAL DESCRIPTION

THE LAND REFERRED TO IN THIS COMMITMENT IS SITUATED IN THE UNINCORPORATED AREA OF THE COUNTY OF RIVERSIDE, STATE OF CALIFORNIA, AND IS DESCRIBED AS FOLLOWS:

PARCEL 2 OF NOTICE OF LOT LINE ADJUSTMENT NO. LLA200028, RECORDED JUNE 21, 2021 AS INSTRUMENT NO. 2021—0373323 OF OFFICIAL RECORDS OF RIVERSIDE COUNTY, CALIFORNIA, BEING THOSE PORTIONS OF THE LAND DESCRIBED IN PARCELS 6, 7 AND 8 OF "CORPORATION GRANT DEED", IN THE EAST HALF OF THE NORTHEAST QUARTER OF SECTION 34, TOWNSHIP 4 SOUTH, RANGE 6 WEST AND THE NORTHWEST QUARTER OF SECTION 35, TOWNSHIP 4 SOUTH, RANGE 6 WEST, SAN BERNARDINO MERIDIAN, IN THE UNINCORPORATED TERRITORY OF THE COUNTY OF RIVERSIDE, STATE OF CALIFORNIA, RECORDED JUNE 30, 1987 AS INSTRUMENT NO. 186951, OF OFFICIAL RECORDS OF SAID COUNTY, BOUNDED AS FOLLOWS:

ON THE NORTHWEST BY THE SOUTHEASTERLY LINE OF DAWSON CANYON ROAD AS DESCRIBED IN PARCEL 1 OF "CORPORATION QUITCLAIM DEED", RECORDED MAY 03. 2002 AS DOCUMENT NO. 2002-236679, OF OFFICIAL RECORDS OF SAID COUNTY;

AND BOUNDED EASTERLY BY THE FOLLOWING DESCRIBED LINE: COMMENCING AT THE WESTERLY TERMINUS OF THAT CERTAIN MOST SOUTHERLY LINE OF SAID PARCEL 6, DESCRIBED AS HAVING A BEARING AND DISTANCE OF "NORTH 89" 51' 27" EAST, 840.06 FEET", SAID WESTERLY TERMINUS ALSO BEING ON THE EASTERLY LINE OF TEMESCAL CANYON ROAD (40.00 FEET HALF-WIDE) AS SHOWN ON PARCEL MAP NO. 31196, AS PER MAP FILED IN BOOK 208, PAGES 50 THROUGH 53, INCLUSIVE OF PARCEL MAPS, IN THE OFFICE OF THE COUNTY RECORDER OF SAID COUNTY; THENCE ALONG SAID MOST SOUTHERLY LINE OF PARCEL 6, NORTH 89' 51' 27" EAST, 586.31 FEET TO A POINT ON THE MOST SOUTHERLY LINE OF SAID PARCEL 8, SAID POINT BEING THE TRUE POINT OF BEGINNING; THENCE NORTH 27" 54' 55" EAST 499.99 FEET TO THE BEGINNING OF A TANGENT CURVE, CONCAVE WESTERLY AND HAVING A RADIUS OF 1080.00 FEET; THENCE NORTHERLY ALONG SAID CURVE, THROUGH A CENTRAL ANGLE OF 31° 44' 51", AN ARC LENGTH OF 598.43 FEET; THENCE TANGENT TO SAID CURVE, NORTH 03' 46' 59" WEST 269.31 FEET TO A POINT ON THAT CERTAIN NORTHERLY CURVED LINE OF SAID PARCEL 8 DESCRIBED AS HAVING A RADIUS OF 700.00 FEET AND A LENGTH OF 143.85 FEET, SAID POINT BEING THE END POINT OF THIS DESCRIPTION.

APN: PORTIONS OF APNS 283-160-046 AND 283-190-044

TABULATION

	BLD
SITE AREA	
In s.f.	220,
In acres	5.0
BUILDING AREA	
Office	6,
Mezzanine	6,
Warehouse	92,
TOTAL	105,
COVERAGE	45.
CLEARANCE	
AUTO PARKING REQUIRED	
Office: 1/250 s.f.	
Warehouse: 1/2,000 s.f.	
TOTAL	
AUTO PARKING STALLS PROVIDED	
Standard (9' x 18')	
Accessible Parking (9' x 18')	
Accessible Van Parking (12' x 18')	
EV Standard (9' x 18')	
EV Accessible (9'x 18')	
EV Van Accessible (12' x 18')	
EV Ambulatory	
Clean Air Vehicle (9' x 18')	
TOTAL	
TRAILER PARKING PROVIDED	
Trailer (10' x 55')	
ZONING ORDINANCE FOR COUNTY	
M-M Manufacturing Medium	
M-R-A Mineral Resources and Related Manufacturing	
MAXIMUM BUILDING HEIGHT ALLOWED	
Height - 50'	
MAXIMUM FLOOR AREA RATIO	
FAR (Total gross area/site):	48.
LANDSCAPE REQUIREMENT	
Required landscape area (10%):	22,
Provided area:	21,
<u>SETBACKS</u>	
Building	
Street Front - 25'	
	i

Side/Rear - None

SITE PLAN KEYNOTES

- \langle 1 \rangle HEAVY BROOM FINISH CONCRETE PAVEMENT.
- \langle 2 \rangle ASPHALT CONCRETE (AC) PAVING.
- (3) CONCRETE WALKWAY, MEDIUM BROOM FINISH.
- \langle 4 angle driveway aprons to be constructed per civil drawings.
- 5 5'-6" x 5'-6" x 4" THICK CONCRETE EXTERIOR LANDING PAD TYP. AT ALL EXTERIOR MAN DOORS TO LANDSCAPED AREAS. FINISH TO BE MEDIUM BROOM
- PROVIDE 8' HIGH METAL GATES W/ KNOX-BOX PER FIRE DEPARTMENT STANDARDS PER DRIVEWAY.
- \langle 7 \rangle TRASH ENCLOSURE PER CITY STANDARD.
- \langle 8 angle APPROXIMATE LOCATION OF TRANSFORMER.
- \langle 9 \rangle PRE-CAST CONCRETE WHEEL STOP.
- $\langle 10
 angle$ concrete filled guard post "6 dia. u.n.o. at 42" h.
- $\langle 11 \rangle$ DESIGNATED SMOKING AREA.
- $\langle 12
 angle$ LANDSCAPE. ALL LANDSCAPE AREAS INDICATED BY SHADING.
- (14) ACCESSIBLE PARKING STALL SIGN.
- $\langle 15 \rangle 14'-0"$ SCREEN WALL

13 MONUMENT SIGN.

- (16) 42" HIGH CONCRETE GUARDWALL.
- $\langle 17 \rangle$ TRUNCATED DOME.
- $\langle 18 \rangle$ NOT USED.
- **Construction Type** (19) EXTERIOR CONCRETE STAIR WITH GUARDWALL AND HANDRAIL CONCRETE TILT-UP BUILDING
 - $\langle 20 \rangle$ EXTERIOR BIKE RACK.
 - $\langle 21 \rangle$ 8' HIGH METAL FENCE

SITE PLAN GENERAL NOTES

- 1. THE SITE PLAN BASED ON THE SOILS REPORT PREPARED BY:
- 2. IF SOILS ARE EXPANSIVE IN NATURE, USE STEEL REINFORCING FOR ALL SITE
- 3. ALL DIMENSIONS ARE TO THE FACE OF CONCRETE WALL, FACE OF CONCRETE CURB OR GRID LINE U.N.O.
- 4. SEE "C" PLANS FOR ALL CONCRETE CURBS, GUTTERS AND SWALES.
- 5. THE ENTIRE PROJECT SHALL BE PERMANENTLY MAINTAINED WITH AN AUTOMATIC IRRIGATION SYSTEM.
- 6. SEE "C" DRAWINGS FOR POINT OF CONNECTIONS TO OFF-SITE UTILITIES. CONTRACTOR SHALL VERIFY ACTUAL UTILITY LOCATIONS.
- 7. PROVIDE POSITIVE DRAINAGE AWAY FROM BLDG. SEE "C" DRAWINGS.
- 8. CONTRACTOR TO REFER TO "C" DRAWINGS FOR ALL HORIZONTAL CONTROL DIMENSIONS. SITE PLANS ARE FOR GUIDANCE AND STARTING LAYOUT POINTS.
- 9. SEE "C"DRAWINGS FOR FINISH GRADE ELEVATIONS.
- 10. CONCRETE SIDEWALKS TO BE A MINIMUM OF 4" THICK W/ TOOLED JOINTS AT 6' O.C. EXPANSION/CONSTRUCTION JOINTS SHALL BE A MAXIMUM 12' EA. WAY. EXPANSION JOINTS TO HAVE COMPRESSIVE EXPANSION FILLER MATERIAL OF 1/4". FINISH TO BE A MEDIUM BROOM FINISH U.N.O.
- 11. PAINT CURBS AND PROVIDE SIGNS TO INFORM OF FIRE LANES AS REQUIRED BY FIRE DEPARTMENT.
- 12. CONSTRUCTION DOCUMENTS PERTAINING TO THE LANDSCAPE AND IRRIGATION OF THE ENTIRE PROJECT SITE SHALL BE SUBMITTED TO THE BUILDING DEPARTMENT AND APPROVED BY PUBLIC FACILITIES DEVELOPMENT PRIOR TO ISSUANCE OF
- 13. PRIOR TO FINAL CITY INSPECTION, THE LANDSCAPE ARCHITECT SHALL SUBMIT A CERTIFICATE OF COMPLETION TO PUBLIC FACILITIES DEVELOPMENT.
- 14. ALL LANDSCAPE AND IRRIGATION DESIGNS SHALL MEET CURRENT CITY STANDARDS AS LISTED IN GUIDELINES OR AS OBTAINED FROM PUBLIC FACILITIES
- 15. LANDSCAPED AREAS SHALL BE DELINEATED WITH A MINIMUM SIX INCHES (6")

SITE LEGEND


	CONCRETE PAVING SEE "C" DRWGS. FOR THICKNESS		LANDSCAPED AREA
	ASPHALT CONCRETE PAVING	>	PATH OF TRAVEL
	SEE "C" DRWGS. FOR THICKNESS		26' WIDE FIRELANE
	STANDARD PARKING STALL (9' X 18')	l ⊗ i	EXISTING PUBLIC FIRE HYDRANT
	STANDARD PARKING STALL W/ 2' OVERHANG	₽ F.H.	PRIVATE FIRE HYDRAI APPROXIMATE LOCATION
	COMPACT PARKING STALL (8.5' X 16') MAX. 40% OF REQUIRED		
	ACCESSIBLE PARKING STALL (9' X 18') + 5' W/ ACCESSIBLE AISLE		ACCESSIBLE PARKING STALL (12' X 18') ACCESSIBLE AISLE
ONEST /	EV PARKING		
5	CLEAN AIR/VANPOOL/EV		

(PROVIDE CONDUIT FOR **FUTURE EV CHARGING)**

EV AMBULATORY PARKING

_____ STALL (10' X 18')

KEY MAP

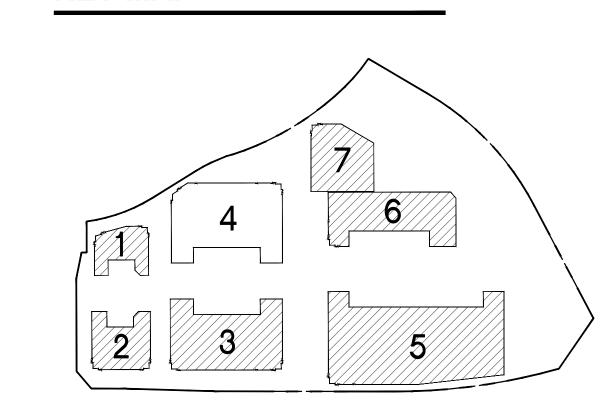



hpa, inc. 18831 bardeen avenue - ste. #100 irvine, ca tel: 949 •863 •1770 fax: 949 • 863 • 0851 email: hpa@hparchs.com



Owner: DAWSON CANYON LLC.

11777 San Vicente Blvd, Ste. 780 Los Angeles, CA 90049 tel: (949) 296-7006 fax: (949) 842-3074



Project:

TEMESCAL VALLEY COMMERCE CENTER

> DAWSON CANYON RD. CORONA, CA 92883

Consultants:

THIENES Structural: Mechanical Plumbing:


Landscape: HUNTER LANDSCAPE Fire Protection: Soils Engineer:

Electrical:

- 5'W/

Overall Site Plan

Project Number: Drawn by: 11/10/22 Date: Revision:

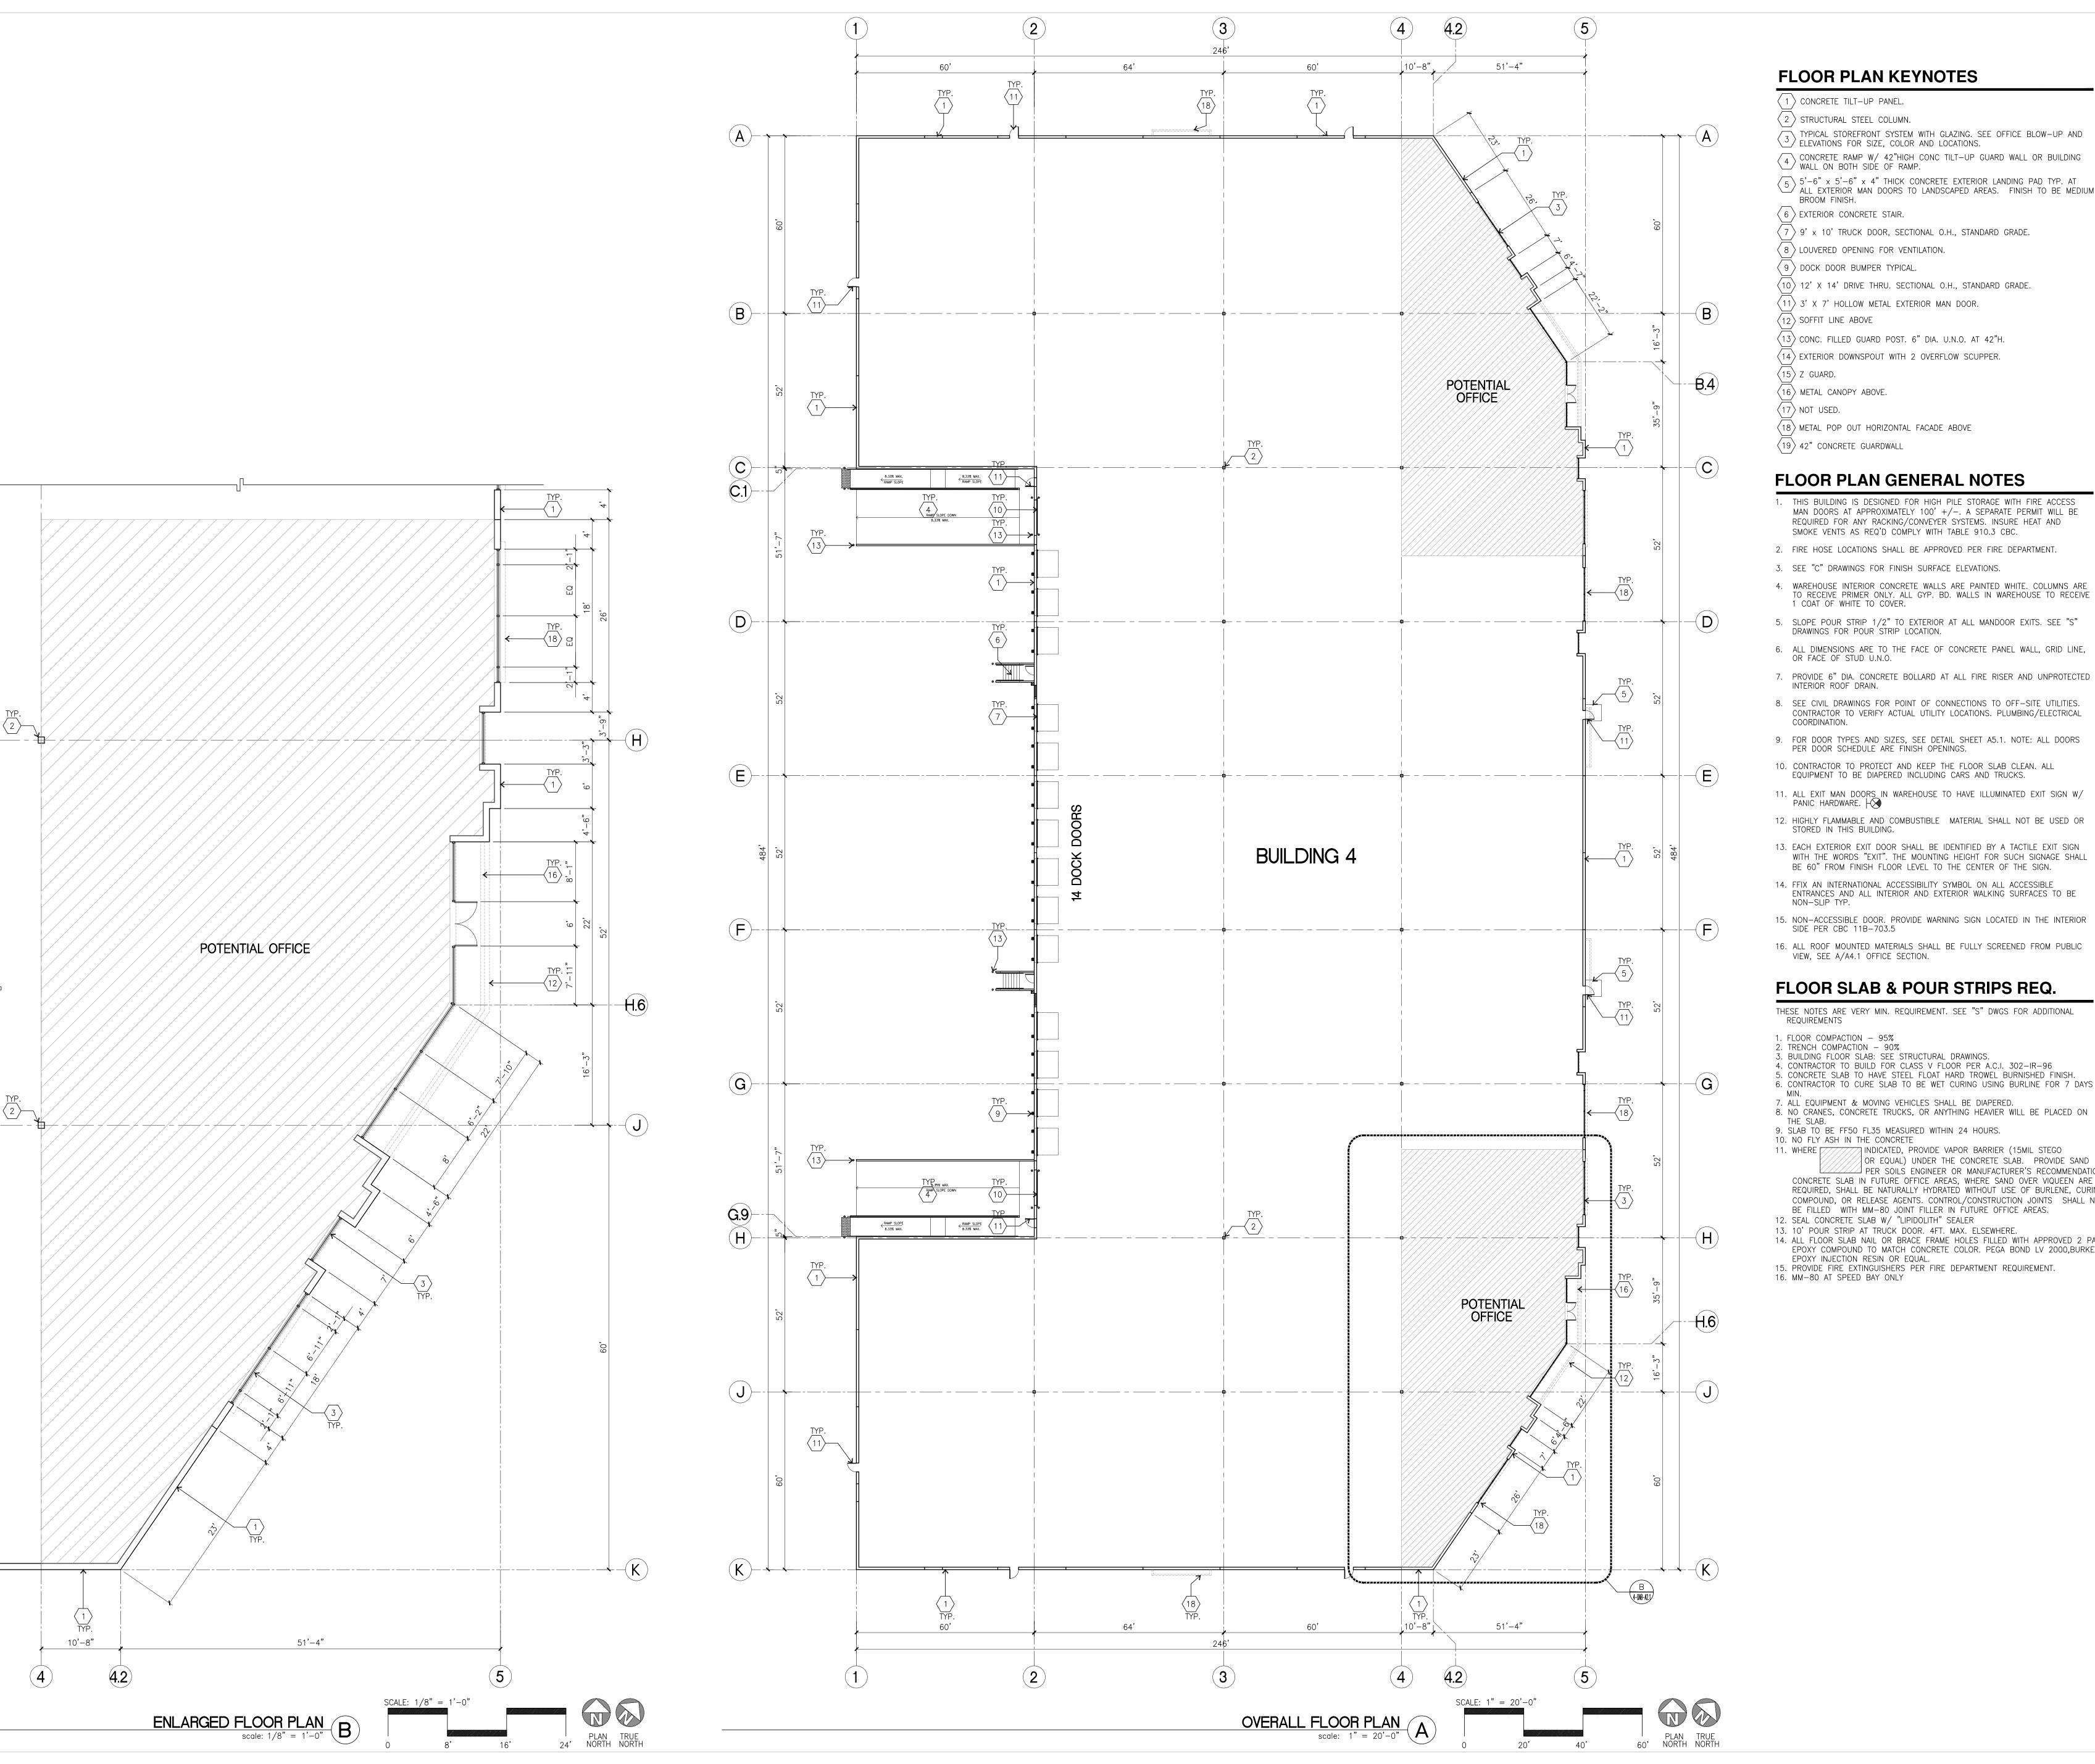

1 CONCRETE TILT-UP PANEL.

(2) STRUCTURAL STEEL COLUMN. TYPICAL STOREFRONT SYSTEM WITH GLAZING. SEE OFFICE BLOW-UP AND $\stackrel{3}{>}$ ELEVATIONS FOR SIZE, COLOR AND LOCATIONS.

CONCRETE RAMP W/ 42"HIGH CONC TILT-UP GUARD WALL OR BUILDING WALL ON BOTH SIDE OF RAMP. 5 5'-6" x 5'-6" x 4" THICK CONCRETE EXTERIOR LANDING PAD TYP. AT ALL EXTERIOR MAN DOORS TO LANDSCAPED AREAS. FINISH TO BE MEDIUM

6 EXTERIOR CONCRETE STAIR.

 $\langle 7 \rangle$ 9' x 10' TRUCK DOOR, SECTIONAL O.H., STANDARD GRADE.

 $\langle 8 \rangle$ LOUVERED OPENING FOR VENTILATION.

(9) DOCK DOOR BUMPER TYPICAL.

(10) 12' X 14' DRIVE THRU. SECTIONAL O.H., STANDARD GRADE. $\langle 11 \rangle$ 3' X 7' HOLLOW METAL EXTERIOR MAN DOOR.

12 SOFFIT LINE ABOVE

 $\langle 13 \rangle$ CONC. FILLED GUARD POST. 6" DIA. U.N.O. AT 42"H. $\langle 14 \rangle$ EXTERIOR DOWNSPOUT WITH 2 OVERFLOW SCUPPER.

 $\langle 15 \rangle$ Z GUARD.

 $\langle 16 \rangle$ METAL CANOPY ABOVE.

(18) METAL POP OUT HORIZONTAL FACADE ABOVE $\langle 19 \rangle$ 42" CONCRETE GUARDWALL

FLOOR PLAN GENERAL NOTES

1. THIS BUILDING IS DESIGNED FOR HIGH PILE STORAGE WITH FIRE ACCESS MAN DOORS AT APPROXIMATELY 100' +/-. A SEPARATE PERMIT WILL BE REQUIRED FOR ANY RACKING/CONVEYER SYSTEMS. INSURE HEAT AND SMOKE VENTS AS REQ'D COMPLY WITH TABLE 910.3 CBC.

2. FIRE HOSE LOCATIONS SHALL BE APPROVED PER FIRE DEPARTMENT.

3. SEE "C" DRAWINGS FOR FINISH SURFACE ELEVATIONS.

4. WAREHOUSE INTERIOR CONCRETE WALLS ARE PAINTED WHITE. COLUMNS ARE TO RECEIVE PRIMER ONLY. ALL GYP. BD. WALLS IN WAREHOUSE TO RECEIVE 1 COAT OF WHITE TO COVER.

5. SLOPE POUR STRIP 1/2" TO EXTERIOR AT ALL MANDOOR EXITS. SEE "S" DRAWINGS FOR POUR STRIP LOCATION.

6. ALL DIMENSIONS ARE TO THE FACE OF CONCRETE PANEL WALL, GRID LINE, OR FACE OF STUD U.N.O.

INTERIOR ROOF DRAIN. 8. SEE CIVIL DRAWINGS FOR POINT OF CONNECTIONS TO OFF-SITE UTILITIES.

9. FOR DOOR TYPES AND SIZES, SEE DETAIL SHEET A5.1. NOTE: ALL DOORS

10. CONTRACTOR TO PROTECT AND KEEP THE FLOOR SLAB CLEAN. ALL EQUIPMENT TO BE DIAPERED INCLUDING CARS AND TRUCKS.

11. ALL EXIT MAN DOORS IN WAREHOUSE TO HAVE ILLUMINATED EXIT SIGN W/PANIC HARDWARE.

12. HIGHLY FLAMMABLE AND COMBUSTIBLE MATERIAL SHALL NOT BE USED OR STORED IN THIS BUILDING. 13. EACH EXTERIOR EXIT DOOR SHALL BE IDENTIFIED BY A TACTILE EXIT SIGN

WITH THE WORDS "EXIT". THE MOUNTING HEIGHT FOR SUCH SIGNAGE SHALL BE 60" FROM FINISH FLOOR LEVEL TO THE CENTER OF THE SIGN.

14. FFIX AN INTERNATIONAL ACCESSIBILITY SYMBOL ON ALL ACCESSIBLE ENTRANCES AND ALL INTERIOR AND EXTERIOR WALKING SURFACES TO BE

15. NON-ACCESSIBLE DOOR. PROVIDE WARNING SIGN LOCATED IN THE INTERIOR SIDE PER CBC 11B-703.5

16. ALL ROOF MOUNTED MATERIALS SHALL BE FULLY SCREENED FROM PUBLIC VIEW, SEE A/A4.1 OFFICE SECTION.

FLOOR SLAB & POUR STRIPS REQ.

THESE NOTES ARE VERY MIN. REQUIREMENT. SEE "S" DWGS FOR ADDITIONAL REQUIREMENTS

1. FLOOR COMPACTION - 95%

3. BUILDING FLOOR SLAB: SEE STRUCTURAL DRAWINGS. 4. CONTRACTOR TO BUILD FOR CLASS V FLOOR PER A.C.I. 302-IR-96

5. CONCRETE SLAB TO HAVE STEEL FLOAT HARD TROWEL BURNISHED FINISH. 6. CONTRACTOR TO CURE SLAB TO BE WET CURING USING BURLINE FOR 7 DAYS

7. ALL EQUIPMENT & MOVING VEHICLES SHALL BE DIAPERED. 8. NO CRANES, CONCRETE TRUCKS, OR ANYTHING HEAVIER WILL BE PLACED ON

9. SLAB TO BE FF50 FL35 MEASURED WITHIN 24 HOURS.

10. NO FLY ASH IN THE CONCRETE 11. WHERE ///// INDICATED, PROVIDE VAPOR BARRIER (15MIL STEGO OR EQUAL) UNDER THE CONCRETE SLAB. PROVIDE SAND PER SOILS ENGINEER OR MANUFACTURER'S RECOMMENDATION.

CONCRETE SLAB IN FUTURE OFFICE AREAS, WHERE SAND OVER VIQUEEN ARE REQUIRED, SHALL BE NATURALLY HYDRATED WITHOUT USE OF BURLENE, CURING COMPOUND, OR RELEASE AGENTS. CONTROL/CONSTRUCTION JOINTS SHALL NOT BE FILLED WITH MM-80 JOINT FILLER IN FUTURE OFFICE AREAS. 12. SEAL CONCRETE SLAB W/ "LIPIDOLITH" SEALER

13. 10' POUR STRIP AT TRUCK DOOR. 4FT. MAX. ELSEWHERE. 14. ALL FLOOR SLAB NAIL OR BRACE FRAME HOLES FILLED WITH APPROVED 2 PART EPOXY COMPOUND TO MATCH CONCRETE COLOR. PEGA BOND LV 2000, BURKE

15. PROVIDE FIRE EXTINGUISHERS PER FIRE DEPARTMENT REQUIREMENT. 16. MM-80 AT SPEED BAY ONLY



hpa, inc. 18831 bardeen avenue - ste. #100 irvine, ca tel: 949 •863 •1770 fax: 949 • 863 • 0851 email: hpa@hparchs.com

Owner: DAWSON CANYON LLC.

11777 San Vicente Blvd, Ste. 780 Los Angeles, CA 90049 tel: (949) 296-7006 fax: (949) 842-3074

TEMESCAL VALLEY COMMERCE CENTER

> DAWSON CANYON RD. CORONA, CA 92883

THIENES Structural: Mechanical: Plumbing: Electrical: Landscape: HUNTER LANDSCAPE


Overall Floor Plan

Project Number: Drawn by: Date:


Revision:

Fire Protection:


Soils Engineer:

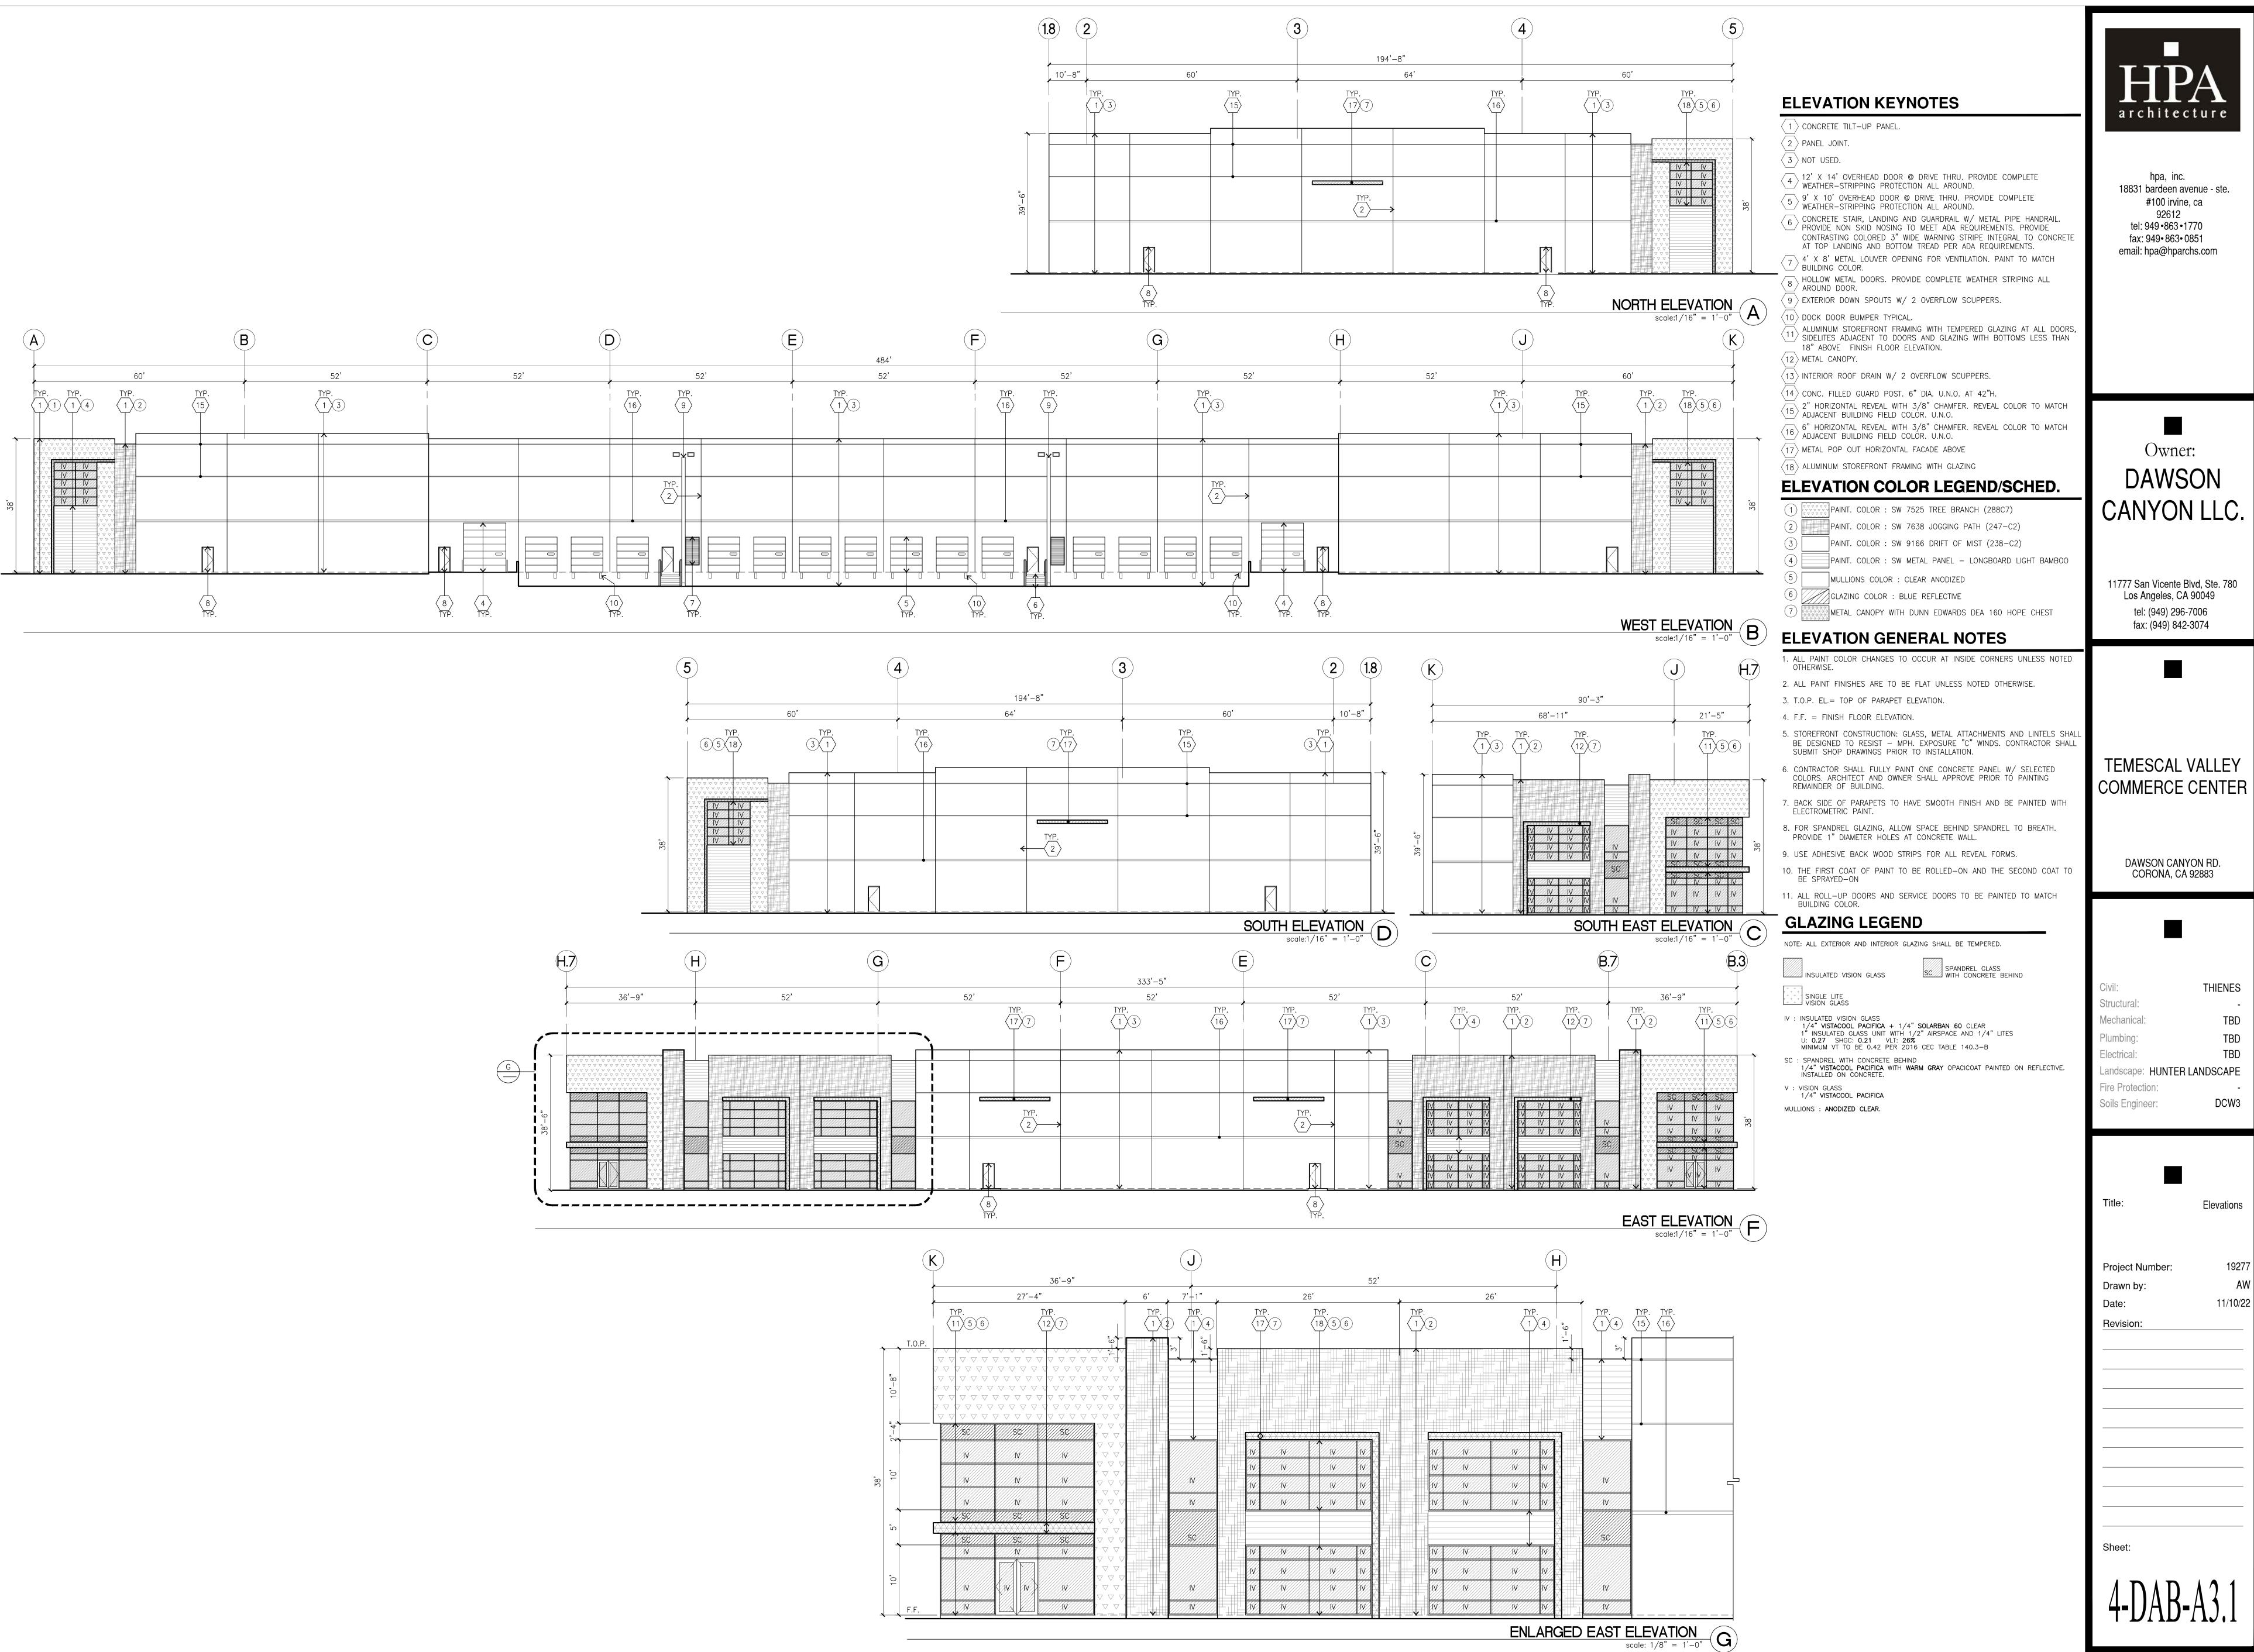

TBD Landscape: HUNTER LANDSCAPE

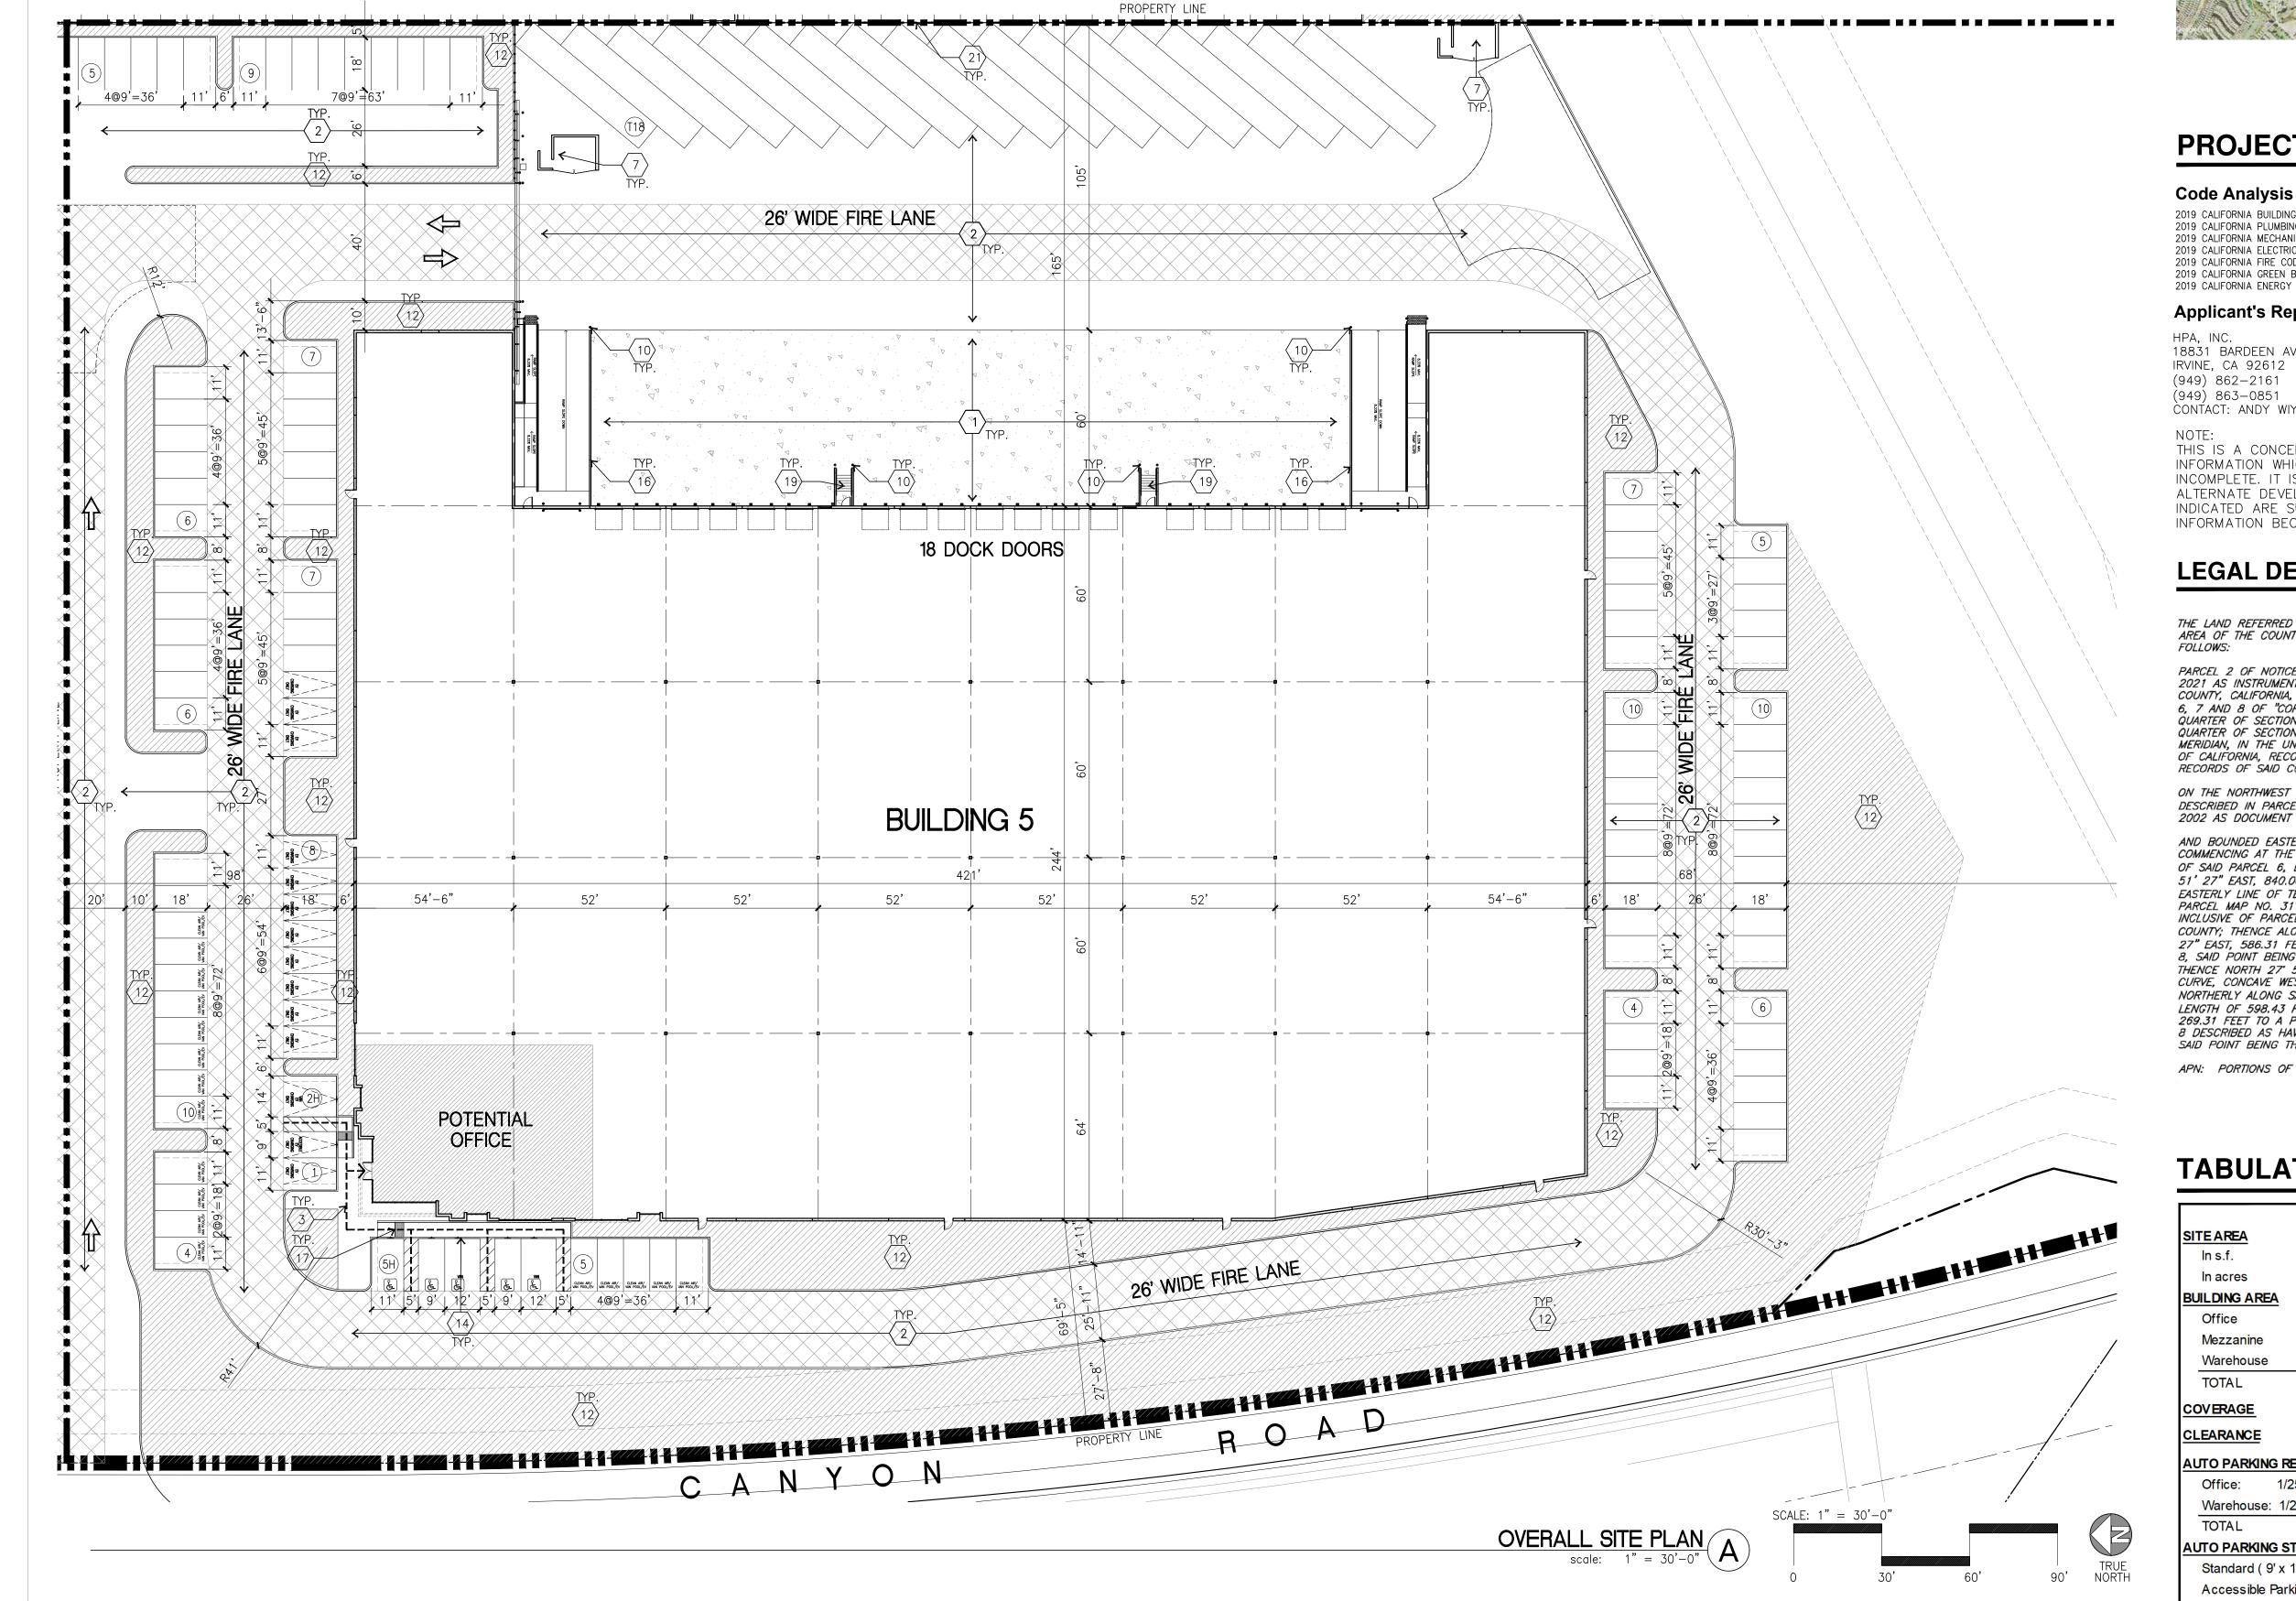

AERIAL MAP

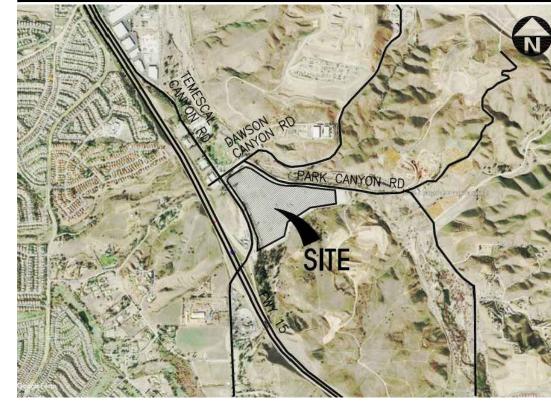

BUILDING OCCUPANCY : S-1 / B

CONSTRUCTION TYPE : III-B

FIRE SPRINKLER BUILDING

283-160-046

283-190-044

PROJECT INFORMATION

Code Analysis 2019 CALIFORNIA BUILDING CODE 2019 CALIFORNIA PLUMBING CODE

2019 CALIFORNIA MECHANICAL CODE 2019 CALIFORNIA ELECTRICAL CODE 2019 CALIFORNIA FIRE CODE 2019 CALIFORNIA GREEN BUILDING STANDARDS CODE 2019 CALIFORNIA ENERGY CODE

Applicant's Representatives

18831 BARDEEN AVE., SUITE 100 IRVINE, CA 92612 (949) 862-2161(949) 863-0851

CONTACT: ANDY WIYANTO

THIS IS A CONCEPTUAL PLAN. IT IS BASED ON PRELIMINARY INFORMATION WHICH IS NOT FULLY VERIFIED AND MAY BE INCOMPLETE. IT IS MEANT AS A COMPARATIVE AID IN EXAMINING ALTERNATE DEVELOPMENT STRATEGIES AND ANY QUANTITIES INDICATED ARE SUBJECT TO REVISION AS MORE RELIABLE

INFORMATION BECOMES AVAILABLE.

LEGAL DESCRIPTION

THE LAND REFERRED TO IN THIS COMMITMENT IS SITUATED IN THE UNINCORPORATED AREA OF THE COUNTY OF RIVERSIDE, STATE OF CALIFORNIA, AND IS DESCRIBED AS FOLLOWS:

PARCEL 2 OF NOTICE OF LOT LINE ADJUSTMENT NO. LLA200028, RECORDED JUNE 21, 2021 AS INSTRUMENT NO. 2021—0373323 OF OFFICIAL RECORDS OF RIVERSIDE COUNTY, CALIFORNIA, BEING THOSE PORTIONS OF THE LAND DESCRIBED IN PARCELS 6, 7 AND 8 OF "CORPORATION GRANT DEED", IN THE EAST HALF OF THE NORTHEAST QUARTER OF SECTION 34, TOWNSHIP 4 SOUTH, RANGE 6 WEST AND THE NORTHWEST QUARTER OF SECTION 35, TOWNSHIP 4 SOUTH, RANGE 6 WEST, SAN BERNARDINO MERIDIAN, IN THE UNINCORPORATED TERRITORY OF THE COUNTY OF RIVERSIDE, STATE OF CALIFORNIA, RECORDED JUNE 30, 1987 AS INSTRUMENT NO. 186951, OF OFFICIAL RECORDS OF SAID COUNTY, BOUNDED AS FOLLOWS:

ON THE NORTHWEST BY THE SOUTHEASTERLY LINE OF DAWSON CANYON ROAD AS DESCRIBED IN PARCEL 1 OF "CORPORATION QUITCLAIM DEED", RECORDED MAY 03. 2002 AS DOCUMENT NO. 2002-236679, OF OFFICIAL RECORDS OF SAID COUNTY;

AND BOUNDED EASTERLY BY THE FOLLOWING DESCRIBED LINE: COMMENCING AT THE WESTERLY TERMINUS OF THAT CERTAIN MOST SOUTHERLY LINE OF SAID PARCEL 6, DESCRIBED AS HAVING A BEARING AND DISTANCE OF "NORTH 89" 51' 27" EAST, 840.06 FEET", SAID WESTERLY TERMINUS ALSO BEING ON THE EASTERLY LINE OF TEMESCAL CANYON ROAD (40.00 FEET HALF-WIDE) AS SHOWN ON PARCEL MAP NO. 31196, AS PER MAP FILED IN BOOK 208, PAGES 50 THROUGH 53, INCLUSIVE OF PARCEL MAPS, IN THE OFFICE OF THE COUNTY RECORDER OF SAID COUNTY; THENCE ALONG SAID MOST SOUTHERLY LINE OF PARCEL 6, NORTH 89' 51' 27" EAST, 586.31 FEET TO A POINT ON THE MOST SOUTHERLY LINE OF SAID PARCEL 8, SAID POINT BEING THE TRUE POINT OF BEGINNING; THENCE NORTH 27" 54' 55" EAST 499.99 FEET TO THE BEGINNING OF A TANGENT CURVE, CONCAVE WESTERLY AND HAVING A RADIUS OF 1080.00 FEET; THENCE NORTHERLY ALONG SAID CURVE, THROUGH A CENTRAL ANGLE OF 31° 44' 51", AN ARC LENGTH OF 598.43 FEET; THENCE TANGENT TO SAID CURVE, NORTH 03' 46' 59" WEST 269.31 FEET TO A POINT ON THAT CERTAIN NORTHERLY CURVED LINE OF SAID PARCEL 8 DESCRIBED AS HAVING A RADIUS OF 700.00 FEET AND A LENGTH OF 143.85 FEET, SAID POINT BEING THE END POINT OF THIS DESCRIPTION.

APN: PORTIONS OF APNS 283-160-046 AND 283-190-044

TABULATION

	BLDG.
SITE AREA	
In s.f.	289,45
In acres	6.64
BUILDING AREA	
Office	6,50
Mezzanine	6,50
Warehouse	101,70
TOTAL	114,70
COVERAGE	37.4%
CLEARANCE	32
AUTO PARKING REQUIRED	
Office: 1/250 s.f.	5
Warehouse: 1/2,000 s.f.	5
TOTAL	10
AUTO PARKING STALLS PROVIDED	
Standard (9' x 18')	8
Accessible Parking (9' x 18')	
Accessible Van Parking (12' x 18')	
EV Standard (9' x 18')	1
EV Accessible (9' x 18')	1
EV Van Accessible (12' x 18')	1
EV Ambulatory	
Clean Air Vehicle (9' x 18')	1
TOTAL	11
TRAILER PARKING PROVIDED	
Trailer (10' x 55')	1
ZONING ORDINANCE FOR COUNTY	
M-M Manufacturing Medium	
M-R-A Mineral Resources and Related Manufacturing	,
MAXIMUM BUILDING HEIGHT ALLOWED	
Height - 50'	
MAXIMUM FLOOR AREA RATIO	
FAR (Total gross area/site):	39.6%
LANDSCAPE REQUIREMENT	
Required landscape area (10%):	28,94
Provided area:	42,68
<u>SETBACKS</u>	
Building	
Street Front - 25'	
6: L /D N	

Side/Rear - None

SITE PLAN KEYNOTES

- \langle 1 angle HEAVY BROOM FINISH CONCRETE PAVEMENT.
- \langle 2 \rangle ASPHALT CONCRETE (AC) PAVING.
- (3) CONCRETE WALKWAY, MEDIUM BROOM FINISH.
- \langle 4 angle driveway aprons to be constructed per civil drawings.
- \langle 5 \rangle 5'-6" x 5'-6" x 4" THICK CONCRETE EXTERIOR LANDING PAD TYP. AT ALL $^{\prime}$ EXTERIOR MAN DOORS TO LANDSCAPED AREAS. FINISH TO BE MEDIUM BROOM
- PROVIDE 8' HIGH METAL GATES W/ KNOX-BOX PER FIRE DEPARTMENT / STANDARDS PER DRIVEWAY.
- ig(7 ig) TRASH ENCLOSURE PER CITY STANDARD.
- \langle 8 angle APPROXIMATE LOCATION OF TRANSFORMER.
- \langle 9 \rangle PRE-CAST CONCRETE WHEEL STOP.
- $\langle 10
 angle$ concrete filled guard post "6 dia. u.n.o. at 42" h. (11) DESIGNATED SMOKING AREA.
- $\langle 12 \rangle$ LANDSCAPE. ALL LANDSCAPE AREAS INDICATED BY SHADING.
- 13 MONUMENT SIGN.
- (14) ACCESSIBLE PARKING STALL SIGN.
- $\langle 15 \rangle$ 14'-0" SCREEN WALL
- \langle 16angle42" HIGH CONCRETE GUARDWALL.
- $\langle 17 \rangle$ TRUNCATED DOME.
- $\langle 18 \rangle$ NOT USED.
- (19) EXTERIOR CONCRETE STAIR WITH GUARDWALL AND HANDRAIL Construction Type CONCRETE TILT-UP BUILDING
 - $\langle 20 \rangle$ EXTERIOR BIKE RACK.
 - $\langle 21 \rangle$ 8' HIGH METAL FENCE

SITE PLAN GENERAL NOTES

- 1. THE SITE PLAN BASED ON THE SOILS REPORT PREPARED BY:
- 2. IF SOILS ARE EXPANSIVE IN NATURE, USE STEEL REINFORCING FOR ALL SITE
- 3. ALL DIMENSIONS ARE TO THE FACE OF CONCRETE WALL, FACE OF CONCRETE CURB OR GRID LINE U.N.O.
- 4. SEE "C" PLANS FOR ALL CONCRETE CURBS, GUTTERS AND SWALES.
- 5. THE ENTIRE PROJECT SHALL BE PERMANENTLY MAINTAINED WITH AN AUTOMATIC IRRIGATION SYSTEM.
- 6. SEE "C" DRAWINGS FOR POINT OF CONNECTIONS TO OFF-SITE UTILITIES. CONTRACTOR SHALL VERIFY ACTUAL UTILITY LOCATIONS.
- 7. PROVIDE POSITIVE DRAINAGE AWAY FROM BLDG. SEE "C" DRAWINGS.
- 8. CONTRACTOR TO REFER TO "C" DRAWINGS FOR ALL HORIZONTAL CONTROL DIMENSIONS. SITE PLANS ARE FOR GUIDANCE AND STARTING LAYOUT POINTS.
- 9. SEE "C"DRAWINGS FOR FINISH GRADE ELEVATIONS.
- 10. CONCRETE SIDEWALKS TO BE A MINIMUM OF 4" THICK W/ TOOLED JOINTS AT 6' O.C. EXPANSION/CONSTRUCTION JOINTS SHALL BE A MAXIMUM 12' EA. WAY. EXPANSION JOINTS TO HAVE COMPRESSIVE EXPANSION FILLER MATERIAL OF 1/4". FINISH TO BE A MEDIUM BROOM FINISH U.N.O.
- 11. PAINT CURBS AND PROVIDE SIGNS TO INFORM OF FIRE LANES AS REQUIRED BY FIRE DEPARTMENT.
- 12. CONSTRUCTION DOCUMENTS PERTAINING TO THE LANDSCAPE AND IRRIGATION OF THE ENTIRE PROJECT SITE SHALL BE SUBMITTED TO THE BUILDING DEPARTMENT AND APPROVED BY PUBLIC FACILITIES DEVELOPMENT PRIOR TO ISSUANCE OF
- 13. PRIOR TO FINAL CITY INSPECTION, THE LANDSCAPE ARCHITECT SHALL SUBMIT A CERTIFICATE OF COMPLETION TO PUBLIC FACILITIES DEVELOPMENT.
- 14. ALL LANDSCAPE AND IRRIGATION DESIGNS SHALL MEET CURRENT CITY STANDARDS AS LISTED IN GUIDELINES OR AS OBTAINED FROM PUBLIC FACILITIES

EXISTING PUBLIC

FIRE HYDRANT

APPROXIMATE LOCATION

ACCESSIBLE PARKING (VAN) STALL (12' X 18') + 5' W/
ACCESSIBLE AISLE

15. LANDSCAPED AREAS SHALL BE DELINEATED WITH A MINIMUM SIX INCHES (6") HIGH CURB.

SITE LEGEND

CONCRETE PAVING
SEE "C" DRWGS. FOR THICKNESS LANDSCAPED AREA PATH OF TRAVEL ASPHALT CONCRETE PAVING SEE "C" DRWGS. FOR THICKNESS 26' WIDE FIRELANE STANDARD PARKING
STALL W/ 2' OVERHANG PRIVATE FIRE HYDRANT-


ACCESSIBLE PARKING STALL (9' X 18') + 5' W/ ACCESSIBLE AISLE

EV PARKING CLEAN AIR/VANPOOL/EV (PROVIDE CONDUIT FOR FUTURE EV CHARGING)

_____ STALL (10' X 18')

EV AMBULATORY PARKING

KEY MAP

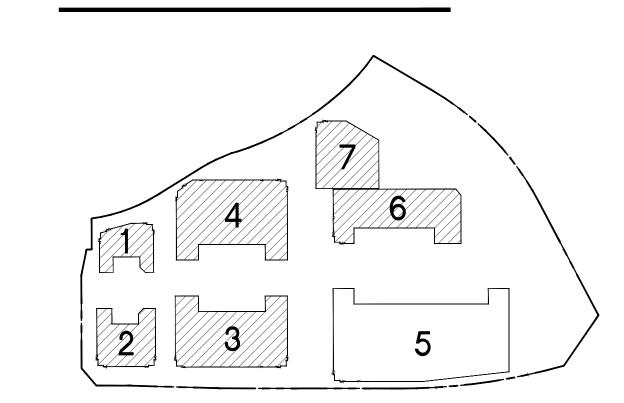



hpa, inc. 18831 bardeen avenue - ste. #100 irvine, ca tel: 949 •863 •1770 fax: 949 • 863 • 0851 email: hpa@hparchs.com



Owner: DAWSON CANYON LLC.

11777 San Vicente Blvd, Ste. 780 Los Angeles, CA 90049 tel: (949) 296-7006 fax: (949) 842-3074

TEMESCAL VALLEY COMMERCE CENTER

> DAWSON CANYON RD. CORONA, CA 92883

THIENES

DCW3


TBD Mechanical: TBD Plumbing: TBD Electrical: Landscape: HUNTER LANDSCAPE Fire Protection:


Structural:

Soils Engineer:

Title: OVERALL SITE PLAN

Project Number: Drawn by: 11/10/22 Date: Revision:

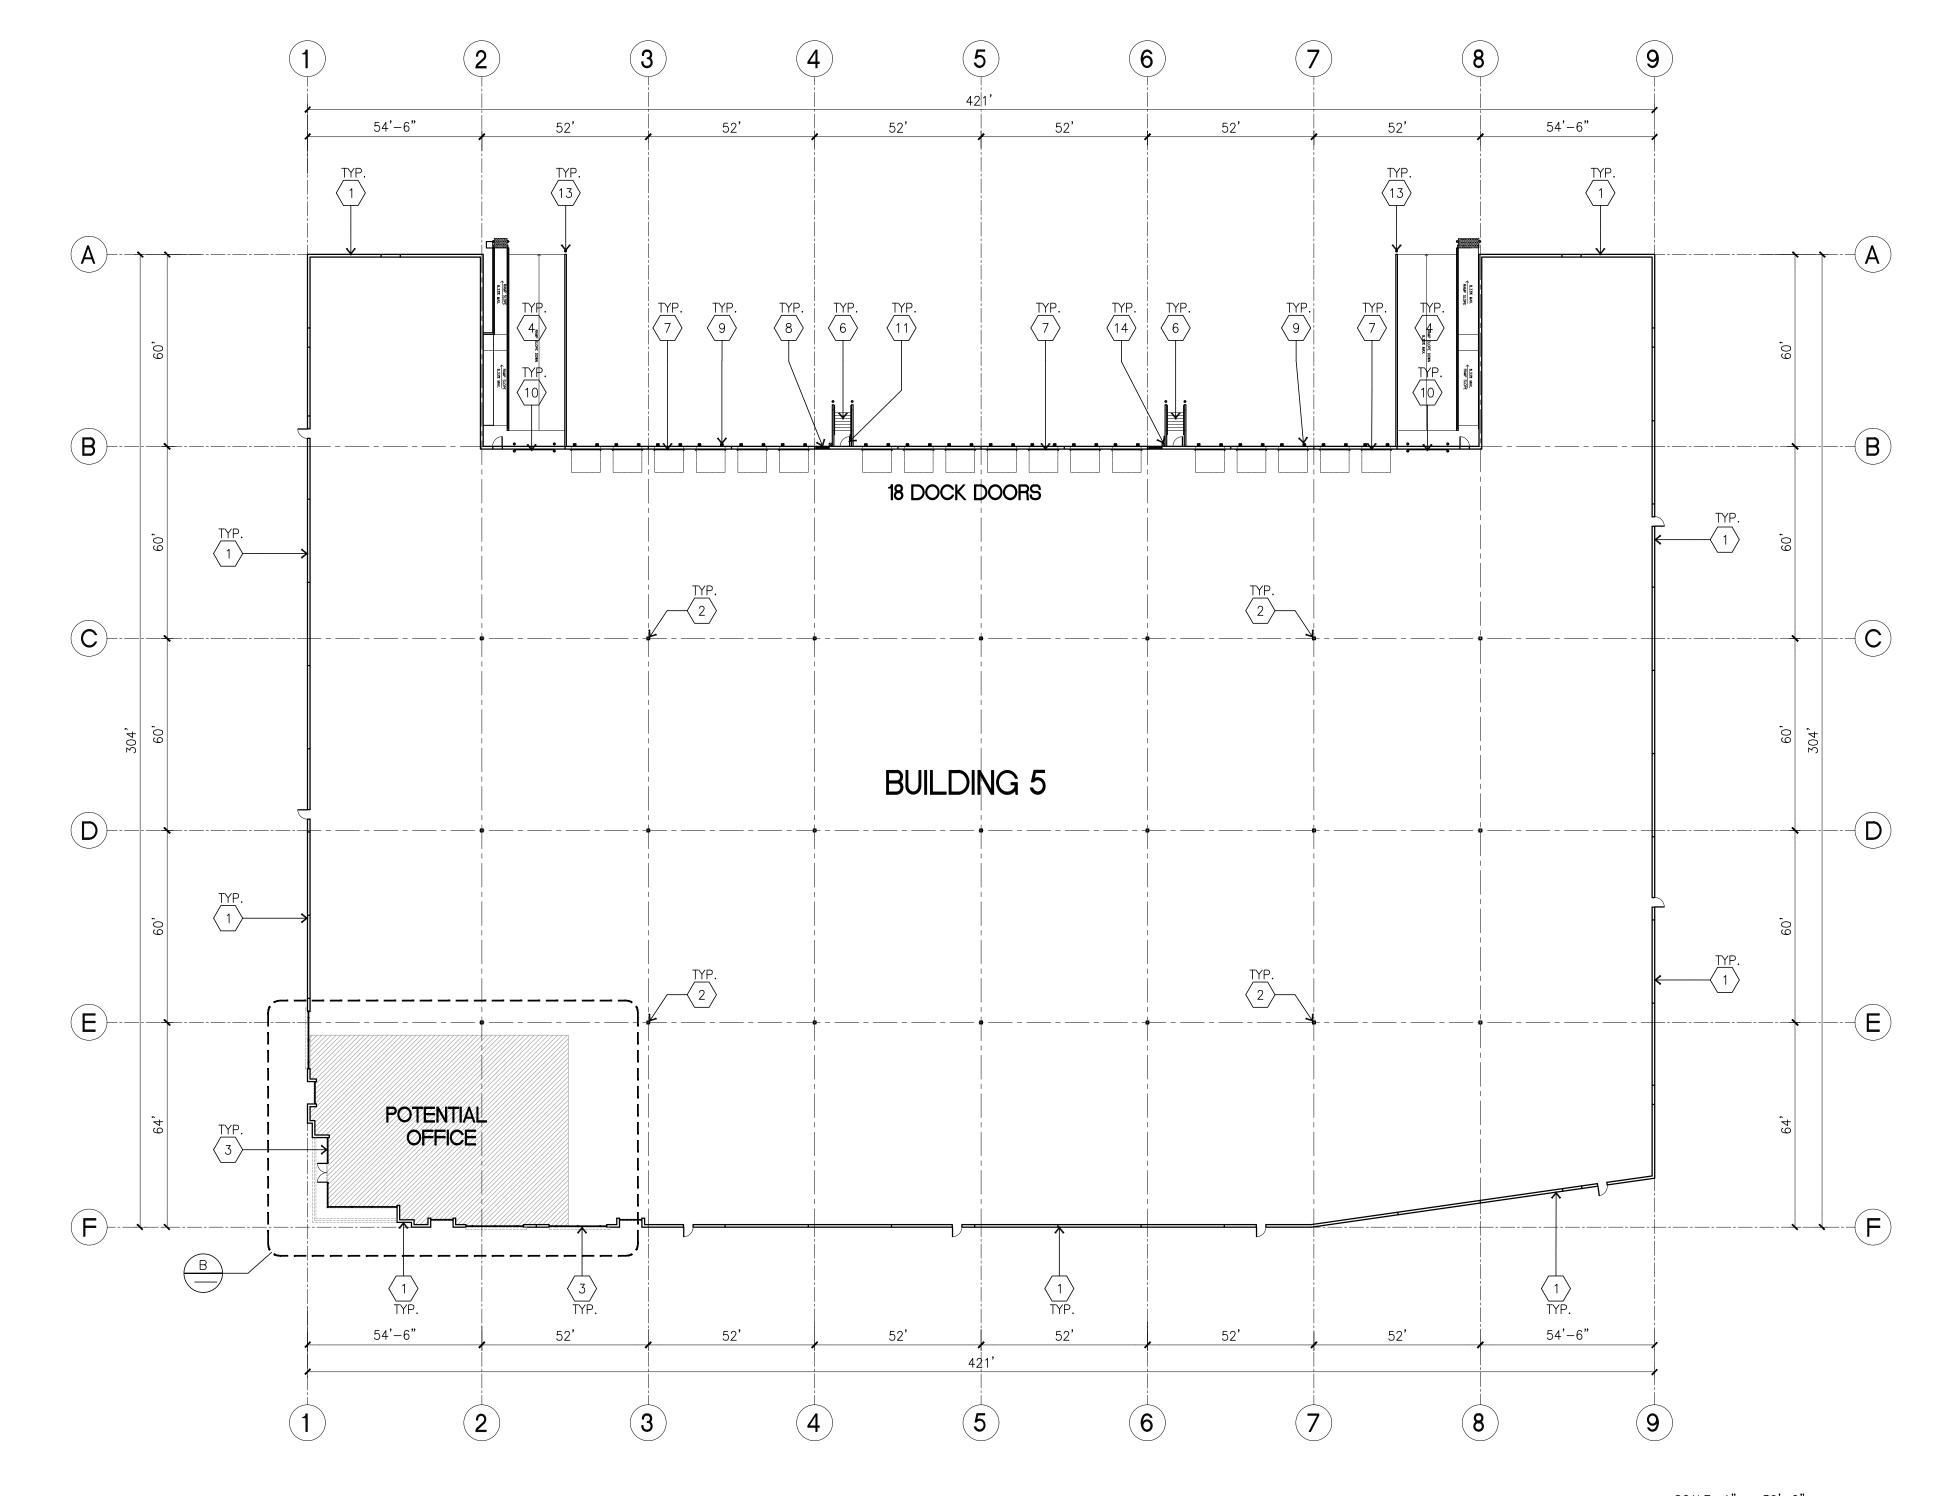

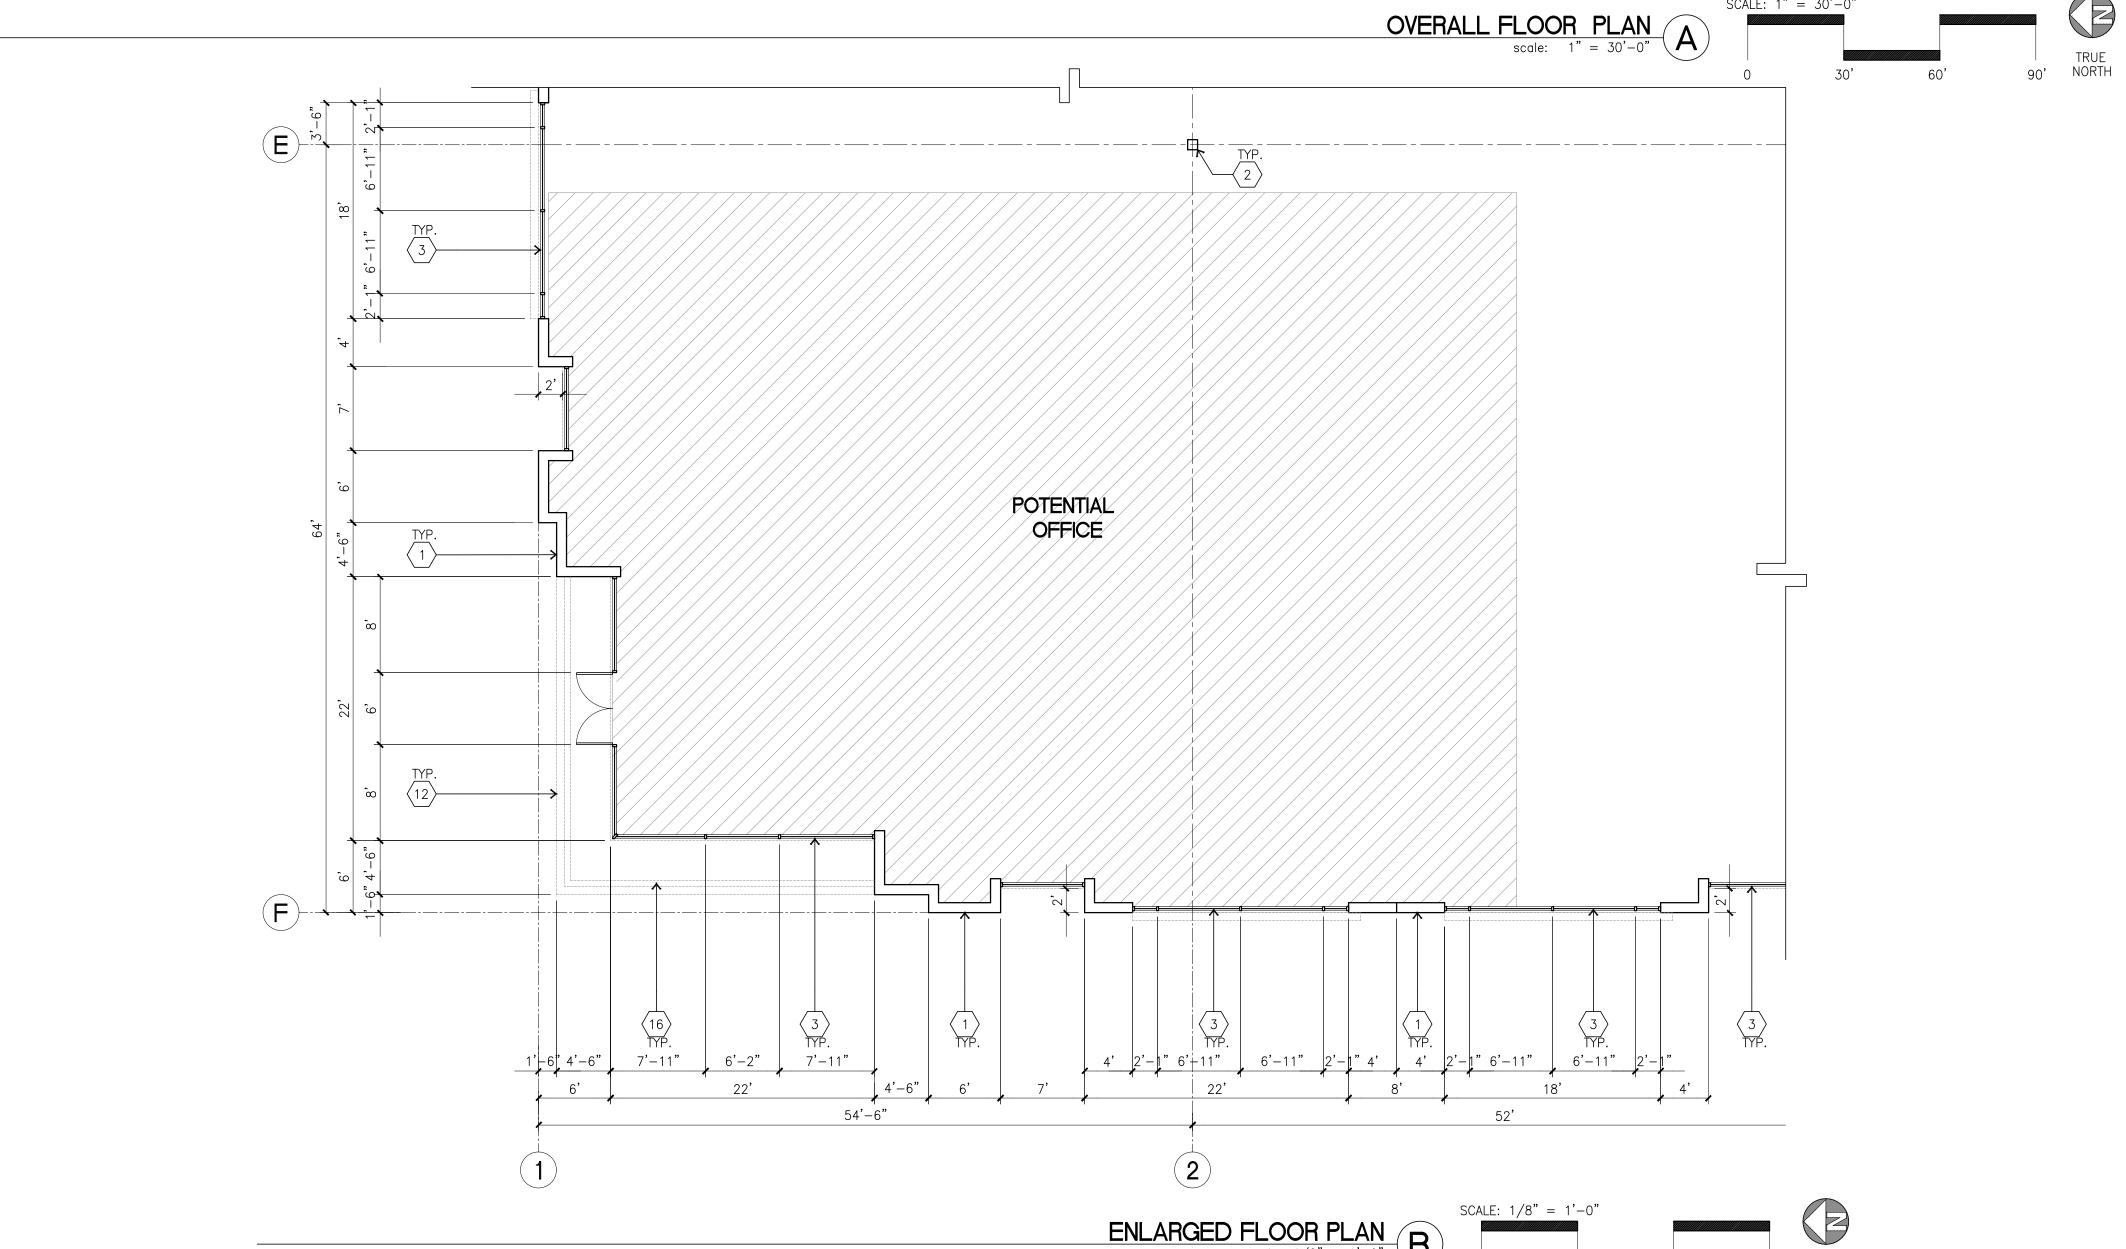

1 CONCRETE TILT-UP PANEL.

 $\langle 2 \rangle$ STRUCTURAL STEEL COLUMN.

TYPICAL STOREFRONT SYSTEM WITH GLAZING. SEE OFFICE BLOW-UP AND $\stackrel{3}{\longrightarrow}$ ELEVATIONS FOR SIZE, COLOR AND LOCATIONS.

CONCRETE RAMP W/ 42"HIGH CONC TILT-UP GUARD WALL OR BUILDING WALL ON BOTH SIDE OF RAMP. 5 5'-6" x 5'-6" x 4" THICK CONCRETE EXTERIOR LANDING PAD TYP. AT ALL EXTERIOR MAN DOORS TO LANDSCAPED AREAS. FINISH TO BE MEDIUM

BROOM FINISH. $\langle 6 \rangle$ EXTERIOR CONCRETE STAIR.

 $\langle 7 \rangle$ 9' x 10' TRUCK DOOR, SECTIONAL O.H., STANDARD GRADE.

(8) LOUVERED OPENING FOR VENTILATION.

(9) DOCK DOOR BUMPER TYPICAL.

(10) 12' X 14' DRIVE THRU. SECTIONAL O.H., STANDARD GRADE.

 $\langle 11 \rangle$ 3' X 7' HOLLOW METAL EXTERIOR MAN DOOR.

12 SOFFIT LINE ABOVE

 $\langle 13 \rangle$ CONC. FILLED GUARD POST. 6" DIA. U.N.O. AT 42"H. $\langle 14 \rangle$ EXTERIOR DOWNSPOUT WITH 2 OVERFLOW SCUPPER.

 $\langle 15 \rangle$ Z GUARD.

 $\langle 16
angle$ METAL CANOPY ABOVE.

 $\langle 17 \rangle$ NOT USED.

(18) METAL POP OUT HORIZONTAL FACADE ABOVE

 $\langle 19 \rangle$ 42" CONCRETE GUARDWALL

FLOOR PLAN GENERAL NOTES

1. THIS BUILDING IS DESIGNED FOR HIGH PILE STORAGE WITH FIRE ACCESS MAN DOORS AT APPROXIMATELY 100' +/-. A SEPARATE PERMIT WILL BE REQUIRED FOR ANY RACKING/CONVEYER SYSTEMS. INSURE HEAT AND SMOKE VENTS AS REQ'D COMPLY WITH TABLE 910.3 CBC.

2. FIRE HOSE LOCATIONS SHALL BE APPROVED PER FIRE DEPARTMENT.

3. SEE "C" DRAWINGS FOR FINISH SURFACE ELEVATIONS.

4. WAREHOUSE INTERIOR CONCRETE WALLS ARE PAINTED WHITE. COLUMNS ARE TO RECEIVE PRIMER ONLY. ALL GYP. BD. WALLS IN WAREHOUSE TO RECEIVE 1 COAT OF WHITE TO COVER.

5. SLOPE POUR STRIP 1/2" TO EXTERIOR AT ALL MANDOOR EXITS. SEE "S" DRAWINGS FOR POUR STRIP LOCATION.

6. ALL DIMENSIONS ARE TO THE FACE OF CONCRETE PANEL WALL, GRID LINE, OR FACE OF STUD U.N.O.

7. PROVIDE 6" DIA. CONCRETE BOLLARD AT ALL FIRE RISER AND UNPROTECTED INTERIOR ROOF DRAIN.

8. SEE CIVIL DRAWINGS FOR POINT OF CONNECTIONS TO OFF-SITE UTILITIES. CONTRACTOR TO VERIFY ACTUAL UTILITY LOCATIONS. PLUMBING/ELECTRICAL COORDINATION.

9. FOR DOOR TYPES AND SIZES, SEE DETAIL SHEET A5.1. NOTE: ALL DOORS PER DOOR SCHEDULE ARE FINISH OPENINGS.

10. CONTRACTOR TO PROTECT AND KEEP THE FLOOR SLAB CLEAN. ALL EQUIPMENT TO BE DIAPERED INCLUDING CARS AND TRUCKS.

11. ALL EXIT MAN DOORS IN WAREHOUSE TO HAVE ILLUMINATED EXIT SIGN W/ PANIC HARDWARE. 🖂

12. HIGHLY FLAMMABLE AND COMBUSTIBLE MATERIAL SHALL NOT BE USED OR STORED IN THIS BUILDING. 13. EACH EXTERIOR EXIT DOOR SHALL BE IDENTIFIED BY A TACTILE EXIT SIGN

BE 60" FROM FINISH FLOOR LEVEL TO THE CENTER OF THE SIGN. 14. FFIX AN INTERNATIONAL ACCESSIBILITY SYMBOL ON ALL ACCESSIBLE ENTRANCES AND ALL INTERIOR AND EXTERIOR WALKING SURFACES TO BE

WITH THE WORDS "EXIT". THE MOUNTING HEIGHT FOR SUCH SIGNAGE SHALL

15. NON-ACCESSIBLE DOOR. PROVIDE WARNING SIGN LOCATED IN THE INTERIOR

SIDE PER CBC 11B-703.5 16. ALL ROOF MOUNTED MATERIALS SHALL BE FULLY SCREENED FROM PUBLIC

FLOOR SLAB & POUR STRIPS REQ.

THESE NOTES ARE VERY MIN. REQUIREMENT. SEE "S" DWGS FOR ADDITIONAL REQUIREMENTS

1. FLOOR COMPACTION - 95%

2. TRENCH COMPACTION - 90%

VIEW, SEE A/A4.1 OFFICE SECTION.

3. BUILDING FLOOR SLAB: SEE STRUCTURAL DRAWINGS. 4. CONTRACTOR TO BUILD FOR CLASS V FLOOR PER A.C.I. 302-IR-96 5. CONCRETE SLAB TO HAVE STEEL FLOAT HARD TROWEL BURNISHED FINISH.

6. CONTRACTOR TO CURE SLAB TO BE WET CURING USING BURLINE FOR 7 DAYS

7. ALL EQUIPMENT & MOVING VEHICLES SHALL BE DIAPERED. 8. NO CRANES, CONCRETE TRUCKS, OR ANYTHING HEAVIER WILL BE PLACED ON

9. SLAB TO BE FF50 FL35 MEASURED WITHIN 24 HOURS. 10. NO FLY ASH IN THE CONCRETE

11. WHERE ///// INDICATED, PROVIDE VAPOR BARRIER (15MIL STEGO OR EQUAL) UNDER THE CONCRETE SLAB. PROVIDE SAND PER SOILS ENGINEER OR MANUFACTURER'S RECOMMENDATION. CONCRETE SLAB IN FUTURE OFFICE AREAS, WHERE SAND OVER VIQUEEN ARE REQUIRED, SHALL BE NATURALLY HYDRATED WITHOUT USE OF BURLENE, CURING COMPOUND, OR RELEASE AGENTS. CONTROL/CONSTRUCTION JOINTS SHALL NOT

12. SEAL CONCRETE SLAB W/ "LIPIDOLITH" SEALER 13. 10' POUR STRIP AT TRUCK DOOR. 4FT. MAX. ELSEWHERE. 14. ALL FLOOR SLAB NAIL OR BRACE FRAME HOLES FILLED WITH APPROVED 2 PART EPOXY COMPOUND TO MATCH CONCRETE COLOR. PEGA BOND LV 2000, BURKE

BE FILLED WITH MM-80 JOINT FILLER IN FUTURE OFFICE AREAS.

EPOXY INJECTION RESIN OR EQUAL. 15. PROVIDE FIRE EXTINGUISHERS PER FIRE DEPARTMENT REQUIREMENT. 16. MM-80 AT SPEED BAY ONLY



hpa, inc. 18831 bardeen avenue - ste. #100 irvine, ca tel: 949 •863 •1770 fax: 949 • 863 • 0851 email: hpa@hparchs.com

Owner: DAWSON CANYON LLC.

11777 San Vicente Blvd, Ste. 780 Los Angeles, CA 90049 tel: (949) 296-7006 fax: (949) 842-3074

TEMESCAL VALLEY COMMERCE CENTER

> DAWSON CANYON RD. CORONA, CA 92883



DCW3


THIENES Structural: Mechanical: TBD Plumbing: Electrical: Landscape: HUNTER LANDSCAPE

Fire Protection:

Soils Engineer:

Title: OVERALL FLOOR PLAN

Project Number:	1927
Drawn by:	ΑV
Date:	11/10/2
Revision:	

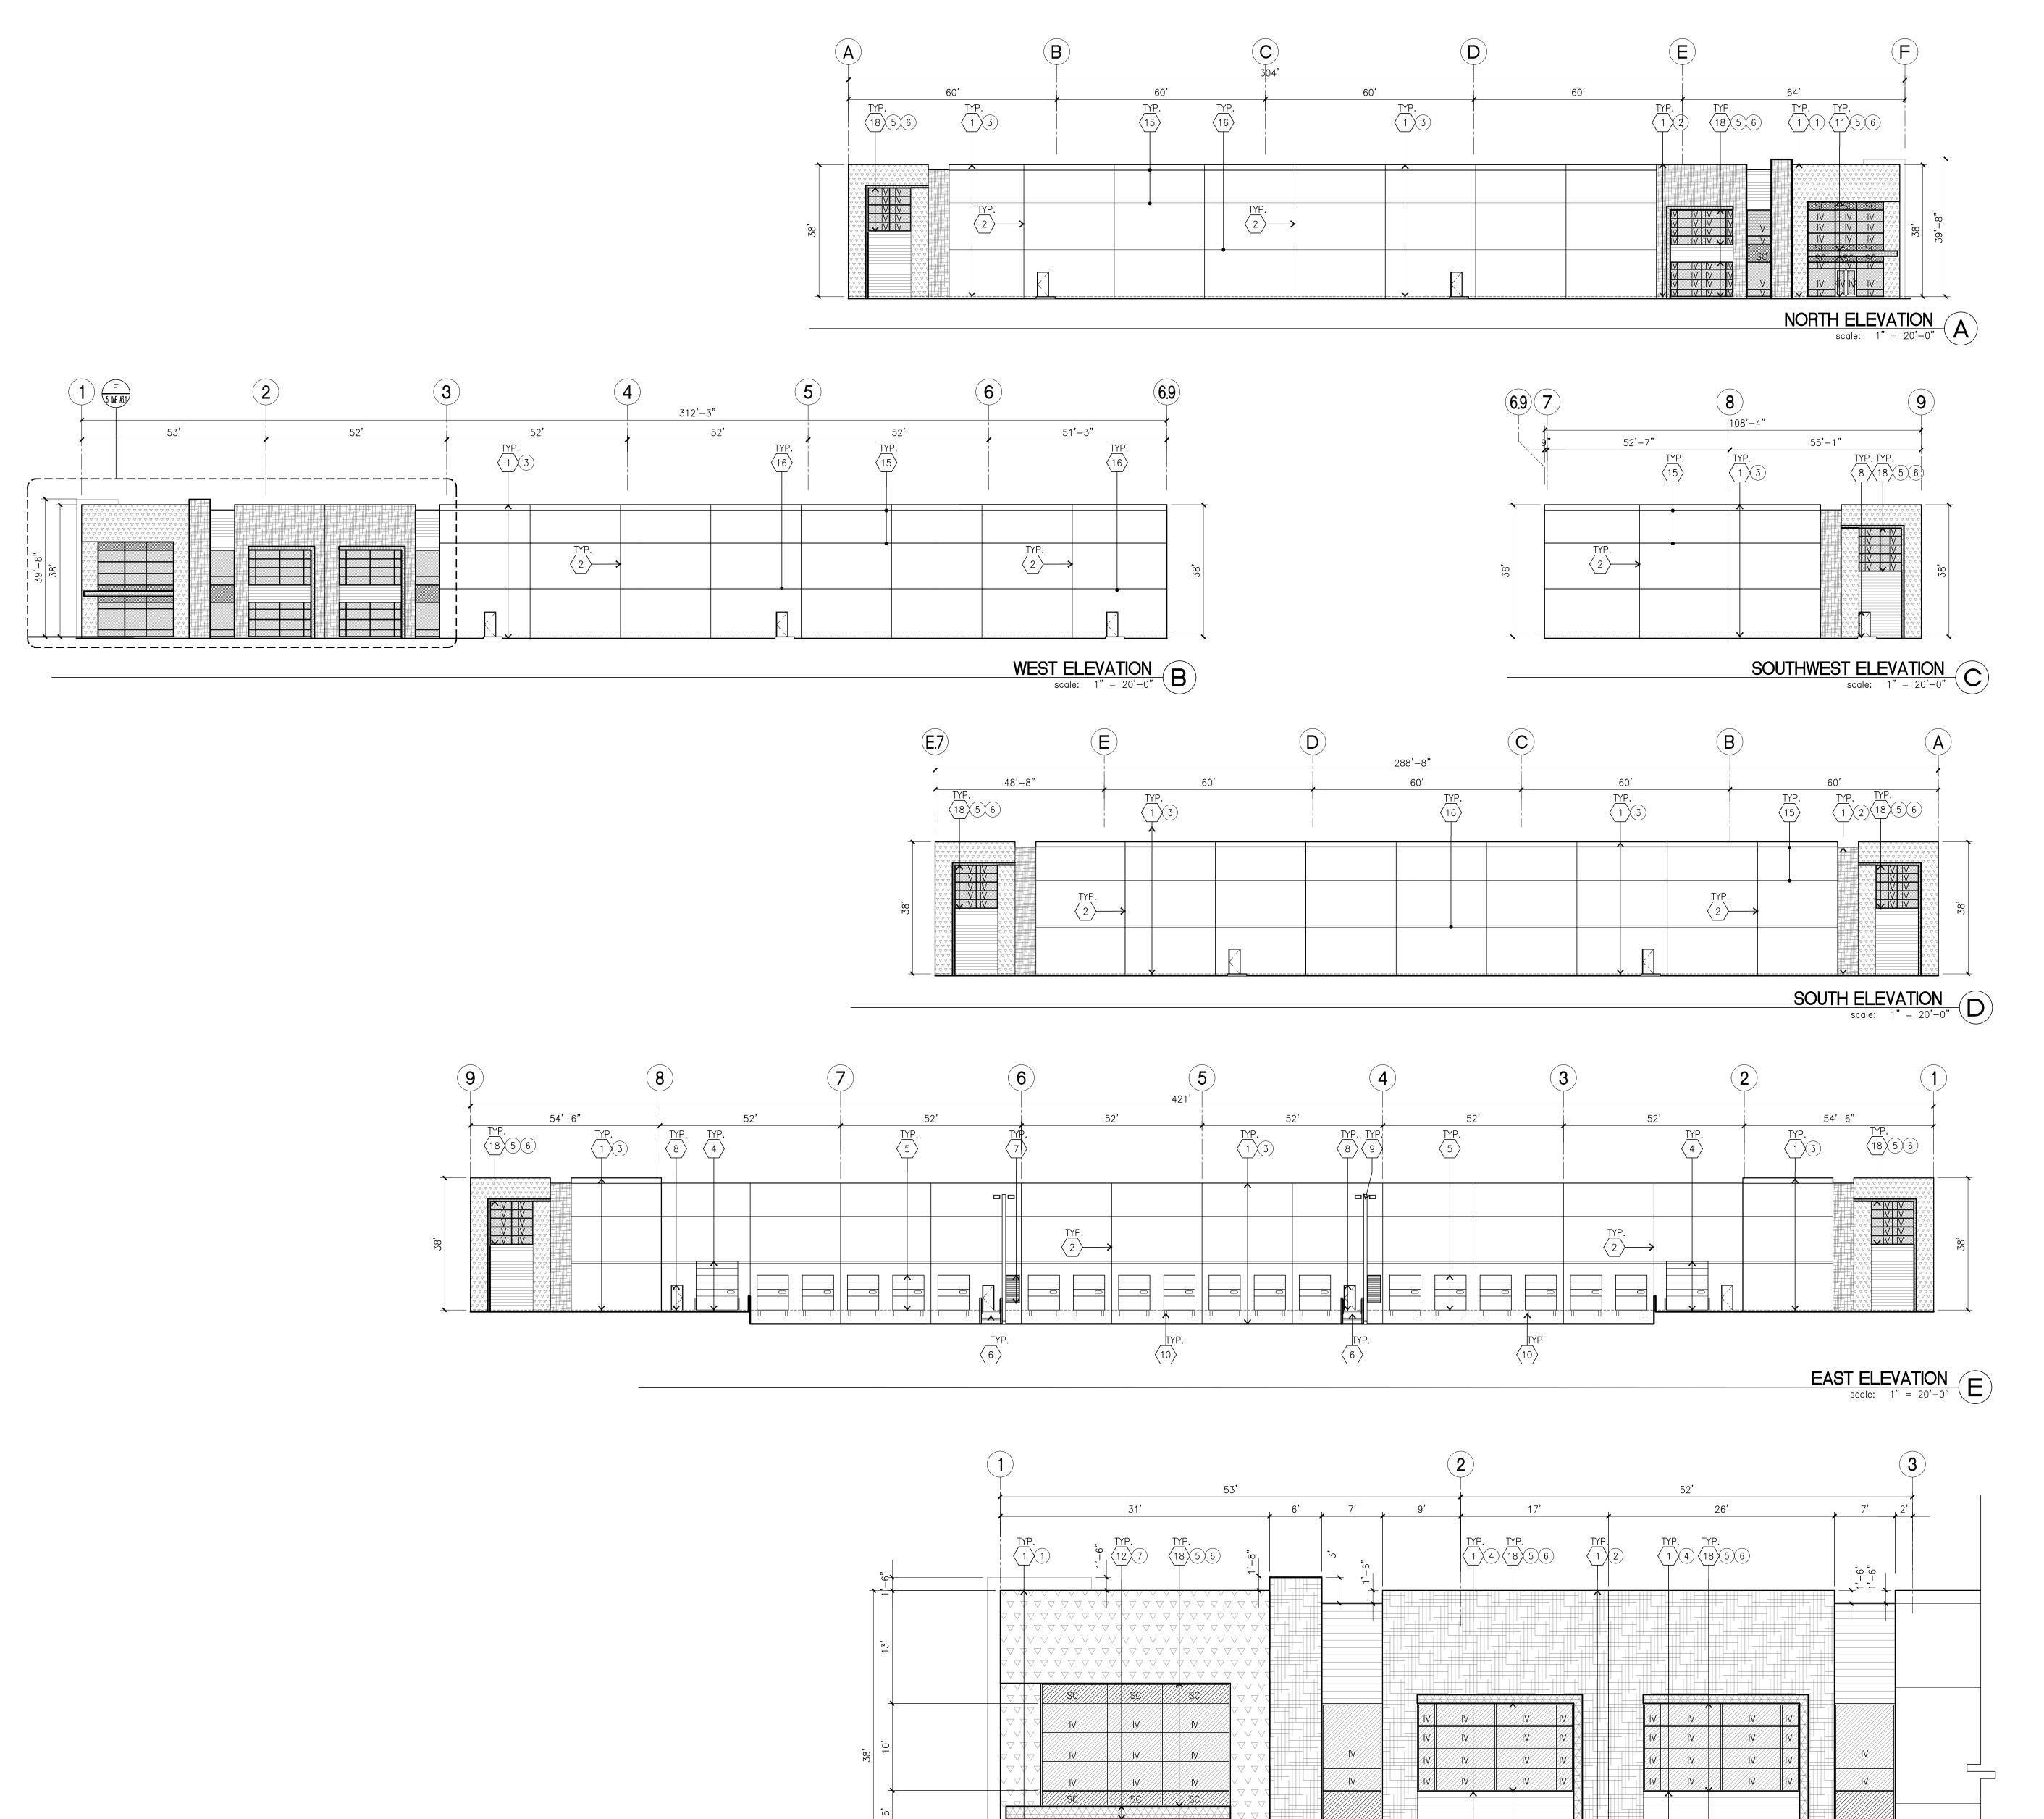

N N

ELEVATION KEYNOTES

- \langle 1 \rangle CONCRETE TILT-UP PANEL.
- $\langle 2 \rangle$ PANEL JOINT.
- $\langle 3 \rangle$ NOT USED.
- 4 12' X 14' OVERHEAD DOOR @ DRIVE THRU. PROVIDE COMPLETE $\stackrel{ au}{}$ WEATHER-STRIPPING PROTECTION ALL AROUND.
- 9' X 10' OVERHEAD DOOR @ DRIVE THRU. PROVIDE COMPLETE / WEATHER-STRIPPING PROTECTION ALL AROUND. 6 CONCRETE STAIR, LANDING AND GUARDRAIL W/ METAL PIPE HANDRAIL.
- √ PROVIDE NON SKID NOSING TO MEET ADA REQUIREMENTS. PROVIDE CONTRASTING COLORED 3" WIDE WARNING STRIPE INTEGRAL TO CONCRETE AT TOP LANDING AND BOTTOM TREAD PER ADA REQUIREMENTS. 7 4' X 8' METAL LOUVER OPENING FOR VENTILATION. PAINT TO MATCH
- 8 HOLLOW METAL DOORS. PROVIDE COMPLETE WEATHER STRIPING ALL
- AROUND DOOR.
- \langle 9 \rangle EXTERIOR DOWN SPOUTS W/ 2 OVERFLOW SCUPPERS. 10 DOCK DOOR BUMPER TYPICAL.
- ALUMINUM STOREFRONT FRAMING WITH TEMPERED GLAZING AT ALL DOORS, SIDELITES ADJACENT TO DOORS AND GLAZING WITH BOTTOMS LESS THAN
- 18" ABOVE FINISH FLOOR ELEVATION. (12) METAL CANOPY.
- $\langle 13 \rangle$ INTERIOR ROOF DRAIN W/ 2 OVERFLOW SCUPPERS.
- $\langle 14 \rangle$ CONC. FILLED GUARD POST. 6" DIA. U.N.O. AT 42"H. 2" HORIZONTAL REVEAL WITH 3/8" CHAMFER. REVEAL COLOR TO MATCH
- ADJACENT BUILDING FIELD COLÓR. U.N.O. 6" HORIZONTAL REVEAL WITH 3/8" CHAMFER. REVEAL COLOR TO MATCH ADJACENT BUILDING FIELD COLOR. U.N.O.
- $\langle 17 \rangle$ METAL POP OUT HORIZONTAL FACADE ABOVE (18) ALUMINUM STOREFRONT FRAMING WITH GLAZING

ELEVATION GENERAL NOTES

- 1. ALL PAINT COLOR CHANGES TO OCCUR AT INSIDE CORNERS UNLESS NOTED OTHERWISE.
- 2. ALL PAINT FINISHES ARE TO BE FLAT UNLESS NOTED OTHERWISE.
- 3. T.O.P. EL.= TOP OF PARAPET ELEVATION.
- 4. F.F. = FINISH FLOOR ELEVATION.

BE SPRAYED-ON

- 5. STOREFRONT CONSTRUCTION: GLASS, METAL ATTACHMENTS AND LINTELS SHALL BE DESIGNED TO RESIST - MPH. EXPOSURE "C" WINDS. CONTRACTOR SHALL SUBMIT SHOP DRAWINGS PRIOR TO INSTALLATION.
- 6. CONTRACTOR SHALL FULLY PAINT ONE CONCRETE PANEL W/ SELECTED COLORS. ARCHITECT AND OWNER SHALL APPROVE PRIOR TO PAINTING REMAINDER OF BUILDING.
- 7. BACK SIDE OF PARAPETS TO HAVE SMOOTH FINISH AND BE PAINTED WITH
- 8. FOR SPANDREL GLAZING, ALLOW SPACE BEHIND SPANDREL TO BREATH. PROVIDE 1" DIAMETER HOLES AT CONCRETE WALL.
- 9. USE ADHESIVE BACK WOOD STRIPS FOR ALL REVEAL FORMS. 10. THE FIRST COAT OF PAINT TO BE ROLLED-ON AND THE SECOND COAT TO
- 11. ALL ROLL-UP DOORS AND SERVICE DOORS TO BE PAINTED TO MATCH BUILDING COLOR.

ELEVATION COLOR LEGEND/SCHED.

- PAINT. COLOR: SW 7525 TREE BRANCH (288C7)
- PAINT. COLOR: SW 9166 DRIFT OF MIST (238-C2)

PAINT. COLOR: SW 7638 JOGGING PATH (247-C2)

- PAINT. COLOR: SW METAL PANEL LONGBOARD LIGHT BAMBOO
- MULLIONS COLOR : CLEAR ANODIZED
- GLAZING COLOR : BLUE REFLECTIVE
- METAL CANOPY WITH DUNN EDWARDS DEA 160 HOPE CHEST

GLAZING LEGEND

NOTE: ALL EXTERIOR AND INTERIOR GLAZING SHALL BE TEMPERED.

SPANDREL GLASS WITH CONCRETE BEHIND INSULATED VISION GLASS

SINGLE LITE VISION GLASS

- IV: INSULATED VISION GLASS

 1/4" VISTACOOL PACIFICA + 1/4" SOLARBAN 60 CLEAR

 1" INSULATED GLASS UNIT WITH 1/2" AIRSPACE AND 1/4" LITES

 U: 0.27 SHGC: 0.21 VLT: 26%

 MINIMUM VT TO BE 0.42 PER 2016 CEC TABLE 140.3-B
- SC : SPANDREL WITH CONCRETE BEHIND 1/4" VISTACOOL PACIFICA WITH WARM GRAY OPACICOAT PAINTED ON REFLECTIVE. INSTALLED ON CONCRETE.
- V : VISION GLASS 1/4" VISTACOOL PACIFICA

ENLARGED WEST ELEVATION scale: 1/8" = 1'-0"

MULLIONS : ANODIZED CLEAR.



hpa, inc. 18831 bardeen avenue - ste. #100 irvine, ca tel: 949 •863 •1770 fax: 949 • 863 • 0851 email: hpa@hparchs.com

Owner: DAWSON CANYON LLC.

11777 San Vicente Blvd, Ste. 780 Los Angeles, CA 90049 tel: (949) 296-7006 fax: (949) 842-3074

TEMESCAL VALLEY COMMERCE CENTER

> DAWSON CANYON RD. CORONA, CA 92883



THIENES

Structural: Mechanical: TBD Plumbing: TBD Electrical: Landscape: HUNTER LANDSCAPE

Fire Protection: DCW3 Soils Engineer:


ELEVATION Title:

Project Number: Drawn by: 11/10/22

Date: Revision:

Sheet:

5-DAB-A3

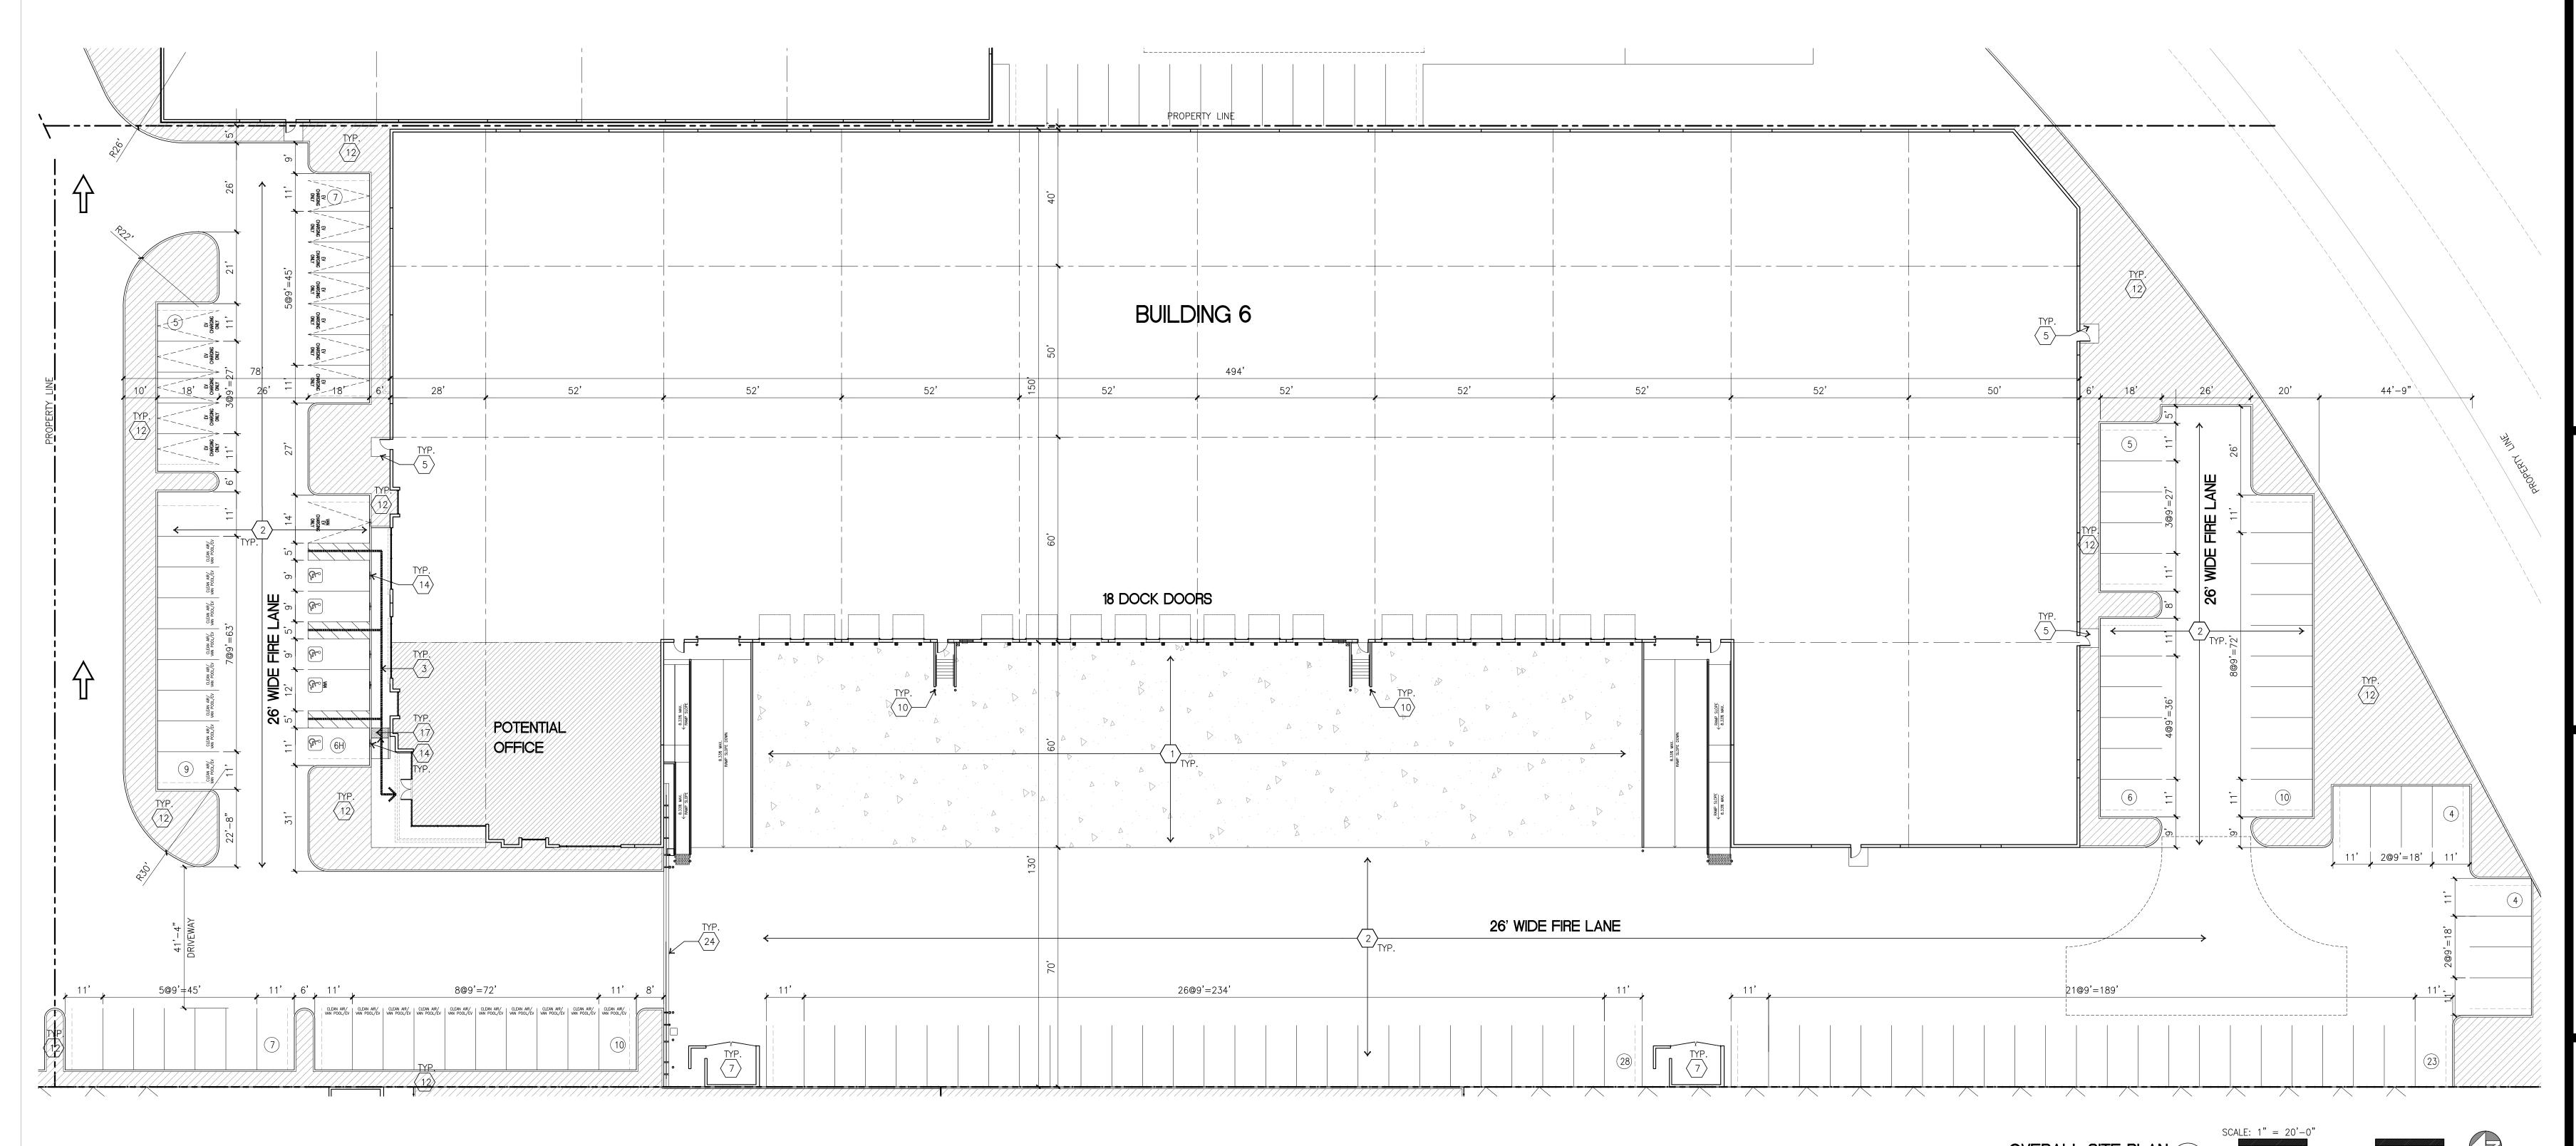

PROJECT INFORMATION

Construction Type

CONCRETE TILT-UP BUILDING

FIRE SPRINKLER BUILDING

APN

283-160-046

283-190-044

BUILDING OCCUPANCY : S-1 / B CONSTRUCTION TYPE : III-B

Code Analysis

2019 CALIFORNIA BUILDING CODE 2019 CALIFORNIA PLUMBING CODE 2019 CALIFORNIA MECHANICAL CODE 2019 CALIFORNIA ELECTRICAL CODE 2019 CALIFORNIA FIRE CODE

2019 CALIFORNIA ENERGY CODE **Applicant's Representatives**

2019 CALIFORNIA GREEN BUILDING STANDARDS CODE

18831 BARDEEN AVE., SUITE 100 IRVINE, CA 92612 (949) 862-2161

(949) 863-0851 CONTACT: ANDY WIYANTO

THIS IS A CONCEPTUAL PLAN. IT IS BASED ON PRELIMINARY INFORMATION WHICH IS NOT FULLY VERIFIED AND MAY BE INCOMPLETE. IT IS MEANT AS A COMPARATIVE AID IN EXAMINING ALTERNATE DEVELOPMENT STRATEGIES AND ANY QUANTITIES INDICATED ARE SUBJECT TO REVISION AS MORE RELIABLE INFORMATION BECOMES AVAILABLE.

LEGAL DESCRIPTION

THE LAND REFERRED TO IN THIS COMMITMENT IS SITUATED IN THE UNINCORPORATED AREA OF THE COUNTY OF RIVERSIDE, STATE OF CALIFORNIA, AND IS DESCRIBED AS

PARCEL 2 OF NOTICE OF LOT LINE ADJUSTMENT NO. LLA200028, RECORDED JUNE 21, 2021 AS INSTRUMENT NO. 2021-0373323 OF OFFICIAL RECORDS OF RIVERSIDE COUNTY, CALIFORNIA, BEING THOSE PORTIONS OF THE LAND DESCRIBED IN PARCELS 6, 7 AND 8 OF "CORPORATION GRANT DEED", IN THE EAST HALF OF THE NORTHEAST QUARTER OF SECTION 34, TOWNSHIP 4 SOUTH, RANGE 6 WEST AND THE NORTHWEST QUARTER OF SECTION 35, TOWNSHIP 4 SOUTH, RANGE 6 WEST, SAN BERNARDINO MERIDIAN, IN THE UNINCORPORATED TERRITORY OF THE COUNTY OF RIVERSIDE, STATE OF CALIFORNIA, RECORDED JUNE 30, 1987 AS INSTRUMENT NO. 186951, OF OFFICIAL RECORDS OF SAID COUNTY, BOUNDED AS FOLLOWS:

ON THE NORTHWEST BY THE SOUTHEASTERLY LINE OF DAWSON CANYON ROAD AS DESCRIBED IN PARCEL 1 OF "CORPORATION QUITCLAIM DEED", RECORDED MAY 03, 2002 AS DOCUMENT NO. 2002-236679, OF OFFICIAL RECORDS OF SAID COUNTY;

AND BOUNDED EASTERLY BY THE FOLLOWING DESCRIBED LINE: COMMENCING AT THE WESTERLY TERMINUS OF THAT CERTAIN MOST SOUTHERLY LINE OF SAID PARCEL 6, DESCRIBED AS HAVING A BEARING AND DISTANCE OF "NORTH 89" 51' 27" EAST, 840.06 FEET", SAID WESTERLY TERMINUS ALSO BEING ON THE EASTERLY LINE OF TEMESCAL CANYON ROAD (40.00 FEET HALF-WIDE) AS SHOWN ON PARCEL MAP NO. 31196, AS PER MAP FILED IN BOOK 208, PAGES 50 THROUGH 53, INCLUSIVE OF PARCEL MAPS, IN THE OFFICE OF THE COUNTY RECORDER OF SAID COUNTY; THENCE ALONG SAID MOST SOUTHERLY LINE OF PARCEL 6, NORTH 89° 51' 27" EAST, 586.31 FEET TO A POINT ON THE MOST SOUTHERLY LINE OF SAID PARCEL 8, SAID POINT BEING THE TRUE POINT OF BEGINNING; THENCE NORTH 27" 54' 55" EAST 499.99 FEET TO THE BEGINNING OF A TANGENT CURVE, CONCAVE WESTERLY AND HAVING A RADIUS OF 1080.00 FEET; THENCE NORTHERLY ALONG SAID CURVE, THROUGH A CENTRAL ANGLE OF 31° 44' 51", AN ARC LENGTH OF 598.43 FEET; THENCE TANGENT TO SAID CURVE, NORTH 03' 46' 59" WEST

269.31 FEET TO A POINT ON THAT CERTAIN NORTHERLY CURVED LINE OF SAID PARCEL 8 DESCRIBED AS HAVING A RADIUS OF 700.00 FEET AND A LENGTH OF 143.85 FEET,

APN: PORTIONS OF APNS 283-160-046 AND 283-190-044

SAID POINT BEING THE END POINT OF THIS DESCRIPTION.

SITE PLAN KEYNOTES

- 1 > HEAVY BROOM FINISH CONCRETE PAVEMENT.
- \langle 2 \rangle ASPHALT CONCRETE (AC) PAVING.
- (3) CONCRETE WALKWAY, MEDIUM BROOM FINISH.
- \langle 4 \rangle DRIVEWAY APRONS TO BE CONSTRUCTED PER CIVIL DRAWINGS. $\langle 5 \rangle$ 5'-6" x 5'-6" x 4" THICK CONCRETE EXTERIOR LANDING PAD TYP. AT ALL
- $^{-\!\!/}$ EXTERIOR MAN DOORS TO LANDSCAPED AREAS. FINISH TO BE MEDIUM BROOM
- PROVIDE 8' HIGH METAL GATES W/ KNOX-BOX PER FIRE DEPARTMENT STANDARDS PER DRIVEWAY. 7 > TRASH ENCLOSURE PER CITY STANDARD.
- 8 APPROXIMATE LOCATION OF TRANSFORMER. 9 > PRE-CAST CONCRETE WHEEL STOP.
- $\langle 10
 angle$ concrete filled guard post "6 dia. u.n.o. at 42" h.
- (11) DESIGNATED SMOKING AREA.
- (12) LANDSCAPE. ALL LANDSCAPE AREAS INDICATED BY SHADING.
- $13\rangle$ MONUMENT SIGN.
- 14 ACCESSIBLE PARKING STALL SIGN.
- 15 \) 14'-0" SCREEN WALL
- (16) 42" HIGH CONCRETE GUARDWALL.
- $\langle 17 \rangle$ TRUNCATED DOME. $\langle 18 \rangle$ NOT USED.
- (19) EXTERIOR CONCRETE STAIR WITH GUARDWALL AND HANDRAIL
- $\langle 20 \rangle$ EXTERIOR BIKE RACK. $\langle 21 \rangle$ 8' HIGH METAL FENCE

SITE PLAN GENERAL NOTES

- 1. THE SITE PLAN BASED ON THE SOILS REPORT PREPARED BY:
 - 2. IF SOILS ARE EXPANSIVE IN NATURE, USE STEEL REINFORCING FOR ALL SITE CONCRETE.
 - 3. ALL DIMENSIONS ARE TO THE FACE OF CONCRETE WALL, FACE OF CONCRETE CURB OR GRID LINE U.N.O.
 - 5. THE ENTIRE PROJECT SHALL BE PERMANENTLY MAINTAINED WITH AN AUTOMATIC IRRIGATION SYSTEM.

4. SEE "C" PLANS FOR ALL CONCRETE CURBS, GUTTERS AND SWALES.

- 6. SEE "C" DRAWINGS FOR POINT OF CONNECTIONS TO OFF-SITE UTILITIES. CONTRACTOR SHALL VERIFY ACTUAL UTILITY LOCATIONS.
- 7. PROVIDE POSITIVE DRAINAGE AWAY FROM BLDG. SEE "C" DRAWINGS.
- 8. CONTRACTOR TO REFER TO "C" DRAWINGS FOR ALL HORIZONTAL CONTROL DIMENSIONS. SITE PLANS ARE FOR GUIDANCE AND STARTING LAYOUT POINTS.
- 9. SEE "C"DRAWINGS FOR FINISH GRADE ELEVATIONS.
- 10. CONCRETE SIDEWALKS TO BE A MINIMUM OF 4" THICK W/ TOOLED JOINTS AT 6' O.C. EXPANSION/CONSTRUCTION JOINTS SHALL BE A MAXIMUM 12' EA. WAY. EXPANSION JOINTS TO HAVE COMPRESSIVE EXPANSION FILLER MATERIAL OF 1/4". FINISH TO BE A MEDIUM BROOM FINISH U.N.O.
- 11. PAINT CURBS AND PROVIDE SIGNS TO INFORM OF FIRE LANES AS REQUIRED BY FIRE DEPARTMENT.
- 12. CONSTRUCTION DOCUMENTS PERTAINING TO THE LANDSCAPE AND IRRIGATION OF THE ENTIRE PROJECT SITE SHALL BE SUBMITTED TO THE BUILDING DEPARTMENT AND APPROVED BY PUBLIC FACILITIES DEVELOPMENT PRIOR TO ISSUANCE OF BUILDING PERMITS.
- 13. PRIOR TO FINAL CITY INSPECTION, THE LANDSCAPE ARCHITECT SHALL SUBMIT A CERTIFICATE OF COMPLETION TO PUBLIC FACILITIES DEVELOPMENT.
- 14. ALL LANDSCAPE AND IRRIGATION DESIGNS SHALL MEET CURRENT CITY STANDARDS AS LISTED IN GUIDELINES OR AS OBTAINED FROM PUBLIC FACILITIES
- 15. LANDSCAPED AREAS SHALL BE DELINEATED WITH A MINIMUM SIX INCHES (6") HIGH CURB.

SITE LEGEND

CONCRETE PAVING
SEE "C" DRWGS. FOR THICKNESS LANDSCAPED AREA PATH OF TRAVEL

ASPHALT CONCRETE PAVING ____ SEE "C" DRWGS. FOR THICKNESS

____ STANDARD PARKING __ STALL W/ 2'OVERHANG COMPACT PARKING STALL (8.5' X 16') MAX. 40% OF REQUIRED

ACCESSIBLE PARKING

STALL (9' X 18') + 5'
W/ ACCESSIBLE AISLE EV PARKING

_____ STALL (10' X 18')

CLEAN AIR/VANPOOL/EV (PROVIDE CONDUIT FOR FUTURE EV CHARGING) EV AMBULATORY PARKING

AERIAL MAP

26' WIDE FIRELANE

EXISTING PUBLIC

FIRE HYDRANT

PRIVATE FIRE HYDRANT-


APPROXIMATE LOCATION

ACCESSIBLE PARKING (VAN)

STALL (12' X 18') + 5' W. ACCESSIBLE AISLE



KEY MAP

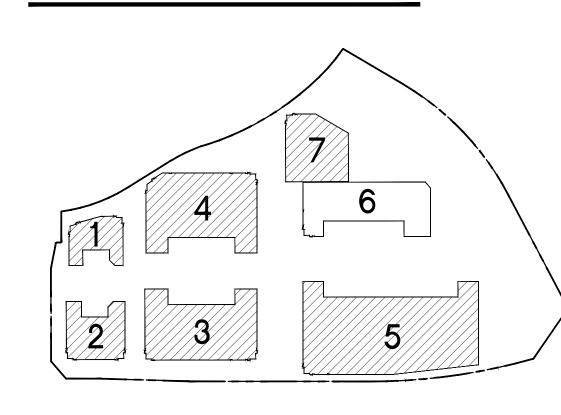

TABULATION

	DEDG. 0
SITE AREA	
In s.f.	196,804
In acres	4.518
BUILDING AREA	
Office	6,500
Mezzanine	6,500
Warehouse	78,025
TOTAL	91,025
COVERAGE	42.9%
CLEARANCE	32'
AUTO PARKING REQUIRED	
Office: 1/250 s.f.	52
Warehouse: 1/2,000 s.f.	39
TOTAL	91
AUTO PARKING STALLS PROVIDED	
Standard (9' x 18')	87
Accessible Parking (9' x 18')	4
Accessible Van Parking (12' x 18')	1
EV Standard (9' x 18')	11
EV Accessible (9' x 18')	1
EV Van Accessible (12' x 18')	1
EV Ambulatory	
Clean Air Vehicle (9' x 18')	18
TOTAL	123
TRAILER PARKING PROVIDED	
Trailer (10' x 55')	
ZONING ORDINANCE FOR COUNTY	
M-M Manufacturing Medium	
M-R-A Mineral Resources and Related Manufacturing	3
MAXIMUM BUILDING HEIGHT ALLOWED	
Height - 50'	
MAXIMUM FLOOR AREA RATIO	
FAR (Total gross area/site):	46.3%
LANDSCAPE REQUIREMENT	
Required landscape area (10%):	19,680
Provided area:	13,753
SETBACKS	-
Building	
Street Front - 25'	
Side/Rear - None	



18831 bardeen avenue - ste tel: 949 •863 •1770 fax: 949 • 863 • 0851



CANYON LLC.

11777 San Vicente Blvd, Ste. 780 Los Angeles, CA 90049 tel: (949) 296-7006 fax: (949) 842-3074

TEMESCAL VALLEY COMMERCE CENTER

> DAWSON CANYON RD. CORONA, CA 92883


THIENES Structural: Mechanical TBD Plumbing: TBD Electrical:


Landscape: HUNTER LANDSCAPE Fire Protection: DCW3

BLDG. 6

Title: OVERALL SITE PLAN

Project Number:	19
Drawn by:	
Date:	11/10
Revision:	
-	

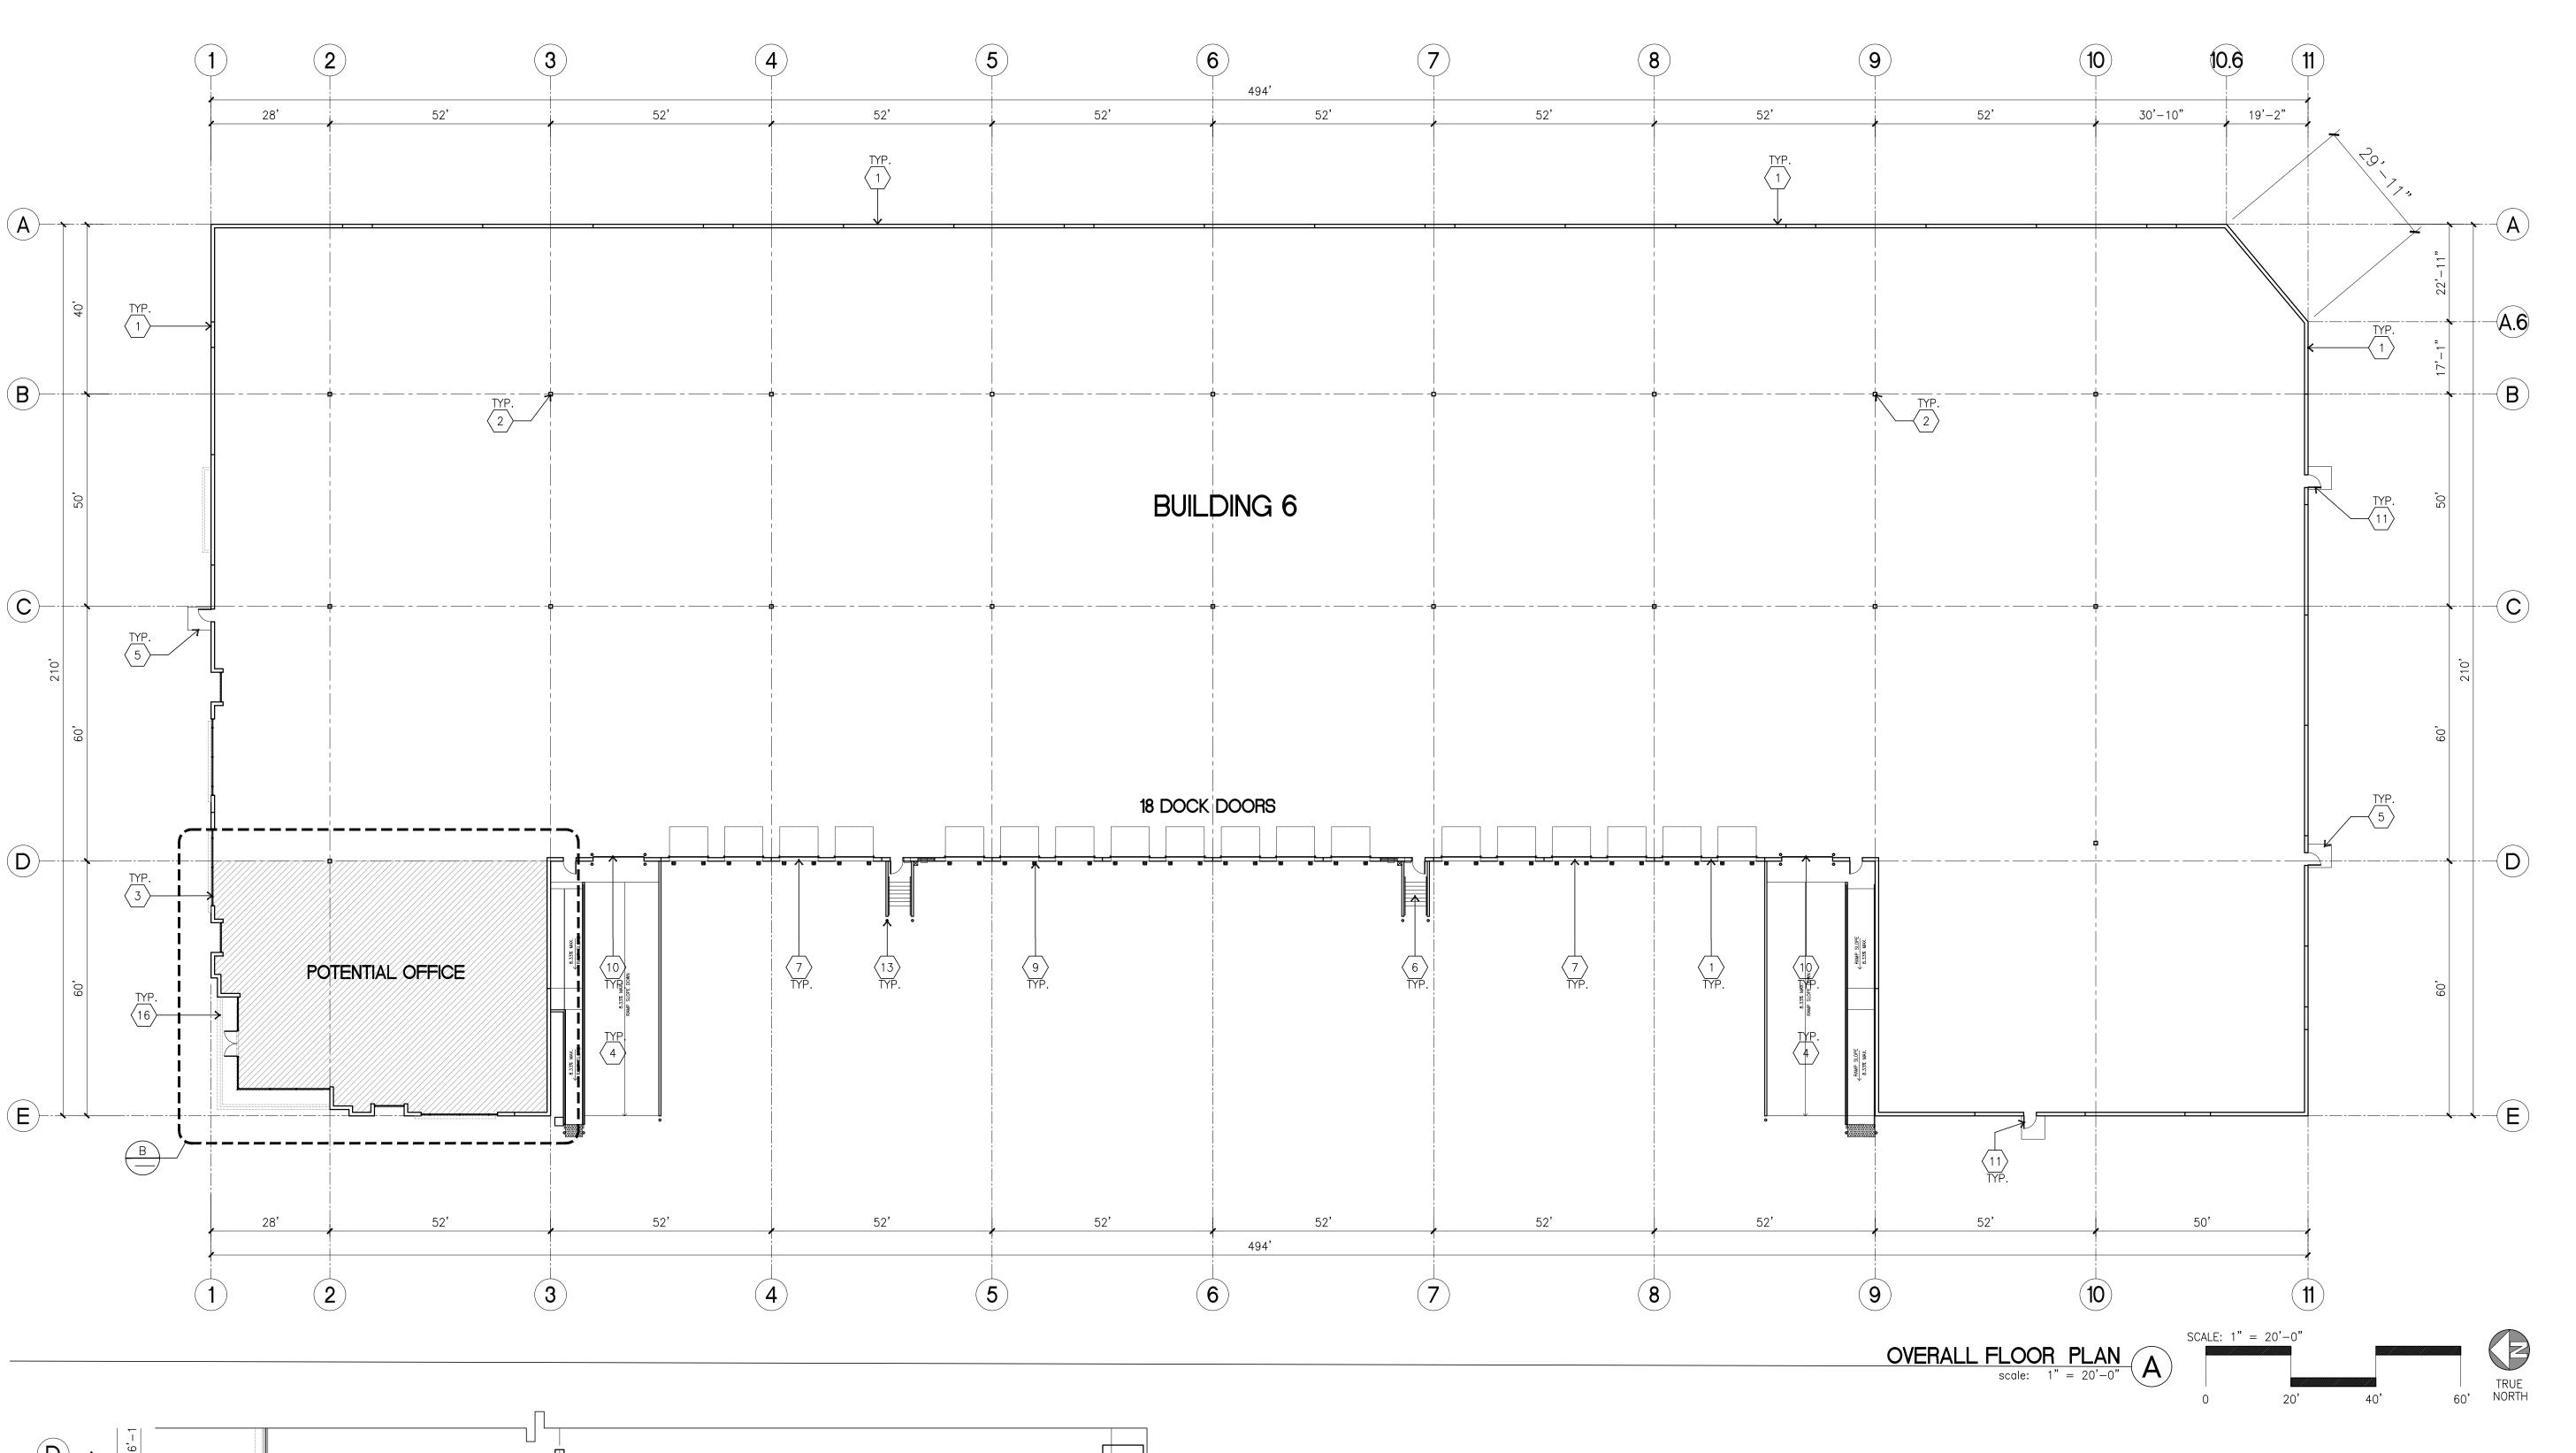

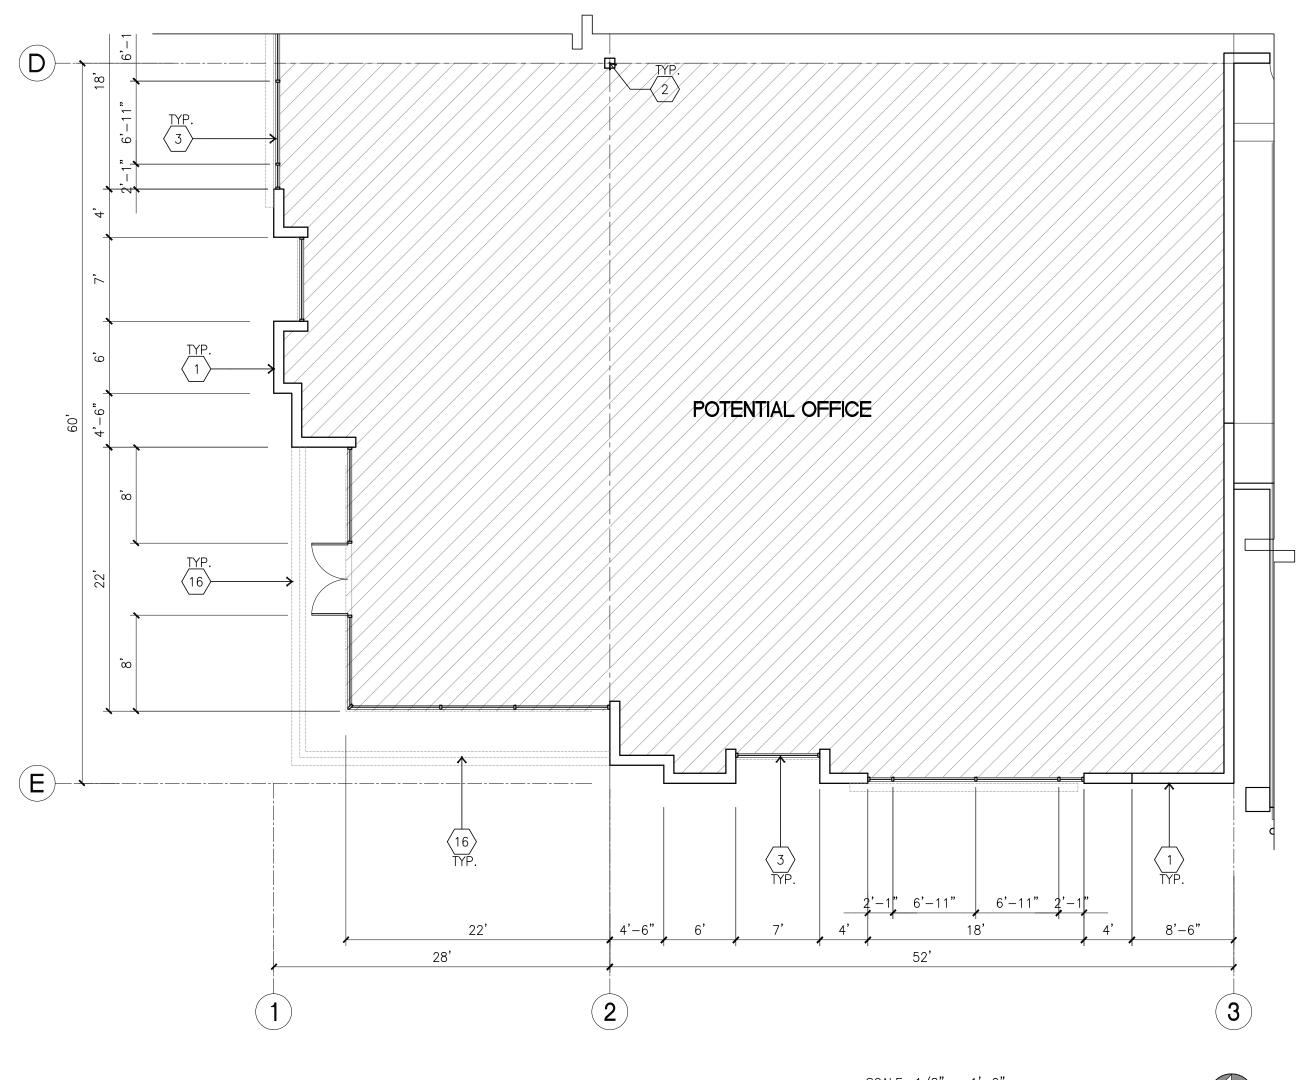

1 CONCRETE TILT-UP PANEL.

2 STRUCTURAL STEEL COLUMN.

TYPICAL STOREFRONT SYSTEM WITH GLAZING. SEE OFFICE BLOW-UP AND ELEVATIONS FOR SIZE, COLOR AND LOCATIONS.

CONCRETE RAMP W/ 42"HIGH CONC TILT-UP GUARD WALL OR BUILDING WALL ON BOTH SIDE OF RAMP.

5 5'-6" x 5'-6" x 4" THICK CONCRETE EXTERIOR LANDING PAD TYP. AT ALL EXTERIOR MAN DOORS TO LANDSCAPED AREAS. FINISH TO BE MEDIUM

BROOM FINISH.

6 EXTERIOR CONCRETE STAIR.

 $\sqrt{7}$ 9' x 10' TRUCK DOOR, SECTIONAL O.H., STANDARD GRADE.

8 LOUVERED OPENING FOR VENTILATION.

9 DOCK DOOR BUMPER TYPICAL.

10 12' X 14' DRIVE THRU. SECTIONAL O.H., STANDARD GRADE.

(11) 3' X 7' HOLLOW METAL EXTERIOR MAN DOOR.

12 SOFFIT LINE ABOVE

(13) CONC. FILLED GUARD POST. 6" DIA. U.N.O. AT 42"H.

(14) EXTERIOR DOWNSPOUT WITH 2 OVERFLOW SCUPPER.

(15) Z GUARD.

(16) METAL CANOPY ABOVE.

17) NOT USED.

18 METAL POP OUT HORIZONTAL FACADE ABOVE

19 42" CONCRETE GUARDWALL

FLOOR PLAN GENERAL NOTES

1. THIS BUILDING IS DESIGNED FOR HIGH PILE STORAGE WITH FIRE ACCESS MAN DOORS AT APPROXIMATELY 100' +/-. A SEPARATE PERMIT WILL BE REQUIRED FOR ANY RACKING/CONVEYER SYSTEMS. INSURE HEAT AND SMOKE VENTS AS REQ'D COMPLY WITH TABLE 910.3 CBC.

2. FIRE HOSE LOCATIONS SHALL BE APPROVED PER FIRE DEPARTMENT.

3. SEE "C" DRAWINGS FOR FINISH SURFACE ELEVATIONS.

4. WAREHOUSE INTERIOR CONCRETE WALLS ARE PAINTED WHITE. COLUMNS ARE TO RECEIVE PRIMER ONLY. ALL GYP. BD. WALLS IN WAREHOUSE TO RECEIVE 1 COAT OF WHITE TO COVER.

5. SLOPE POUR STRIP 1/2" TO EXTERIOR AT ALL MANDOOR EXITS. SEE "S" DRAWINGS FOR POUR STRIP LOCATION.

6. ALL DIMENSIONS ARE TO THE FACE OF CONCRETE PANEL WALL, GRID LINE, OR FACE OF STUD U.N.O.

7. PROVIDE 6" DIA. CONCRETE BOLLARD AT ALL FIRE RISER AND UNPROTECTED INTERIOR ROOF DRAIN.

8. SEE CIVIL DRAWINGS FOR POINT OF CONNECTIONS TO OFF-SITE UTILITIES. CONTRACTOR TO VERIFY ACTUAL UTILITY LOCATIONS. PLUMBING/ELECTRICAL COORDINATION.

9. FOR DOOR TYPES AND SIZES, SEE DETAIL SHEET A5.1. NOTE: ALL DOORS PER DOOR SCHEDULE ARE FINISH OPENINGS.

10. CONTRACTOR TO PROTECT AND KEEP THE FLOOR SLAB CLEAN. ALL EQUIPMENT TO BE DIAPERED INCLUDING CARS AND TRUCKS.

11. ALL EXIT MAN DOORS IN WAREHOUSE TO HAVE ILLUMINATED EXIT SIGN W/

PANIC HARDWARE. | 12. HIGHLY FLAMMABLE AND COMBUSTIBLE MATERIAL SHALL NOT BE USED OR STORED IN THIS BUILDING.

13. EACH EXTERIOR EXIT DOOR SHALL BE IDENTIFIED BY A TACTILE EXIT SIGN WITH THE WORDS "EXIT". THE MOUNTING HEIGHT FOR SUCH SIGNAGE SHALL BE 60" FROM FINISH FLOOR LEVEL TO THE CENTER OF THE SIGN.

14. FFIX AN INTERNATIONAL ACCESSIBILITY SYMBOL ON ALL ACCESSIBLE ENTRANCES AND ALL INTERIOR AND EXTERIOR WALKING SURFACES TO BE

15. NON-ACCESSIBLE DOOR. PROVIDE WARNING SIGN LOCATED IN THE INTERIOR SIDE PER CBC 11B-703.5

16. ALL ROOF MOUNTED MATERIALS SHALL BE FULLY SCREENED FROM PUBLIC VIEW, SEE A/A4.1 OFFICE SECTION.

FLOOR SLAB & POUR STRIPS REQ.

THESE NOTES ARE VERY MIN. REQUIREMENT. SEE "S" DWGS FOR ADDITIONAL REQUIREMENTS

1. FLOOR COMPACTION - 95%

2. TRENCH COMPACTION - 90%
3. BUILDING FLOOR SLAB: SEE STRUCTURAL DRAWINGS.

4. CONTRACTOR TO BUILD FOR CLASS V FLOOR PER A.C.I. 302-IR-96 5. CONCRETE SLAB TO HAVE STEEL FLOAT HARD TROWEL BURNISHED FINISH.

6. CONTRACTOR TO CURE SLAB TO BE WET CURING USING BURLINE FOR 7 DAYS MIN.

7. ALL EQUIPMENT & MOVING VEHICLES SHALL BE DIAPERED. 8. NO CRANES, CONCRETE TRUCKS, OR ANYTHING HEAVIER WILL BE PLACED ON

9. SLAB TO BE FF50 FL35 MEASURED WITHIN 24 HOURS. 10. NO FLY ASH IN THE CONCRETE

11. WHERE INDICATED, PROVIDE VAPOR BARRIER (15MIL STEGO
OR EQUAL) UNDER THE CONCRETE SLAB. PROVIDE SAND
PER SOILS ENGINEER OR MANUFACTURER'S RECOMMENDATION.
CONCRETE SLAB IN FUTURE OFFICE AREAS, WHERE SAND OVER VIQUEEN ARE
REQUIRED, SHALL BE NATURALLY HYDRATED WITHOUT USE OF BURLENE, CURING
COMPOUND, OR RELEASE AGENTS. CONTROL/CONSTRUCTION JOINTS SHALL NOT
BE FILLED WITH MM-80 JOINT FILLER IN FUTURE OFFICE AREAS.

12. SEAL CONCRETE SLAB W/ "LIPIDOLITH" SEALER
13. 10' POUR STRIP AT TRUCK DOOR. 4FT. MAX. ELSEWHERE.
14. ALL FLOOR SLAB NAIL OR BRACE FRAME HOLES FILLED WITH APPROVED 2 PART EPOXY COMPOUND TO MATCH CONCRETE COLOR. PEGA BOND LV 2000, BURKE

EPOXY INJECTION RESIN OR EQUAL.

15. PROVIDE FIRE EXTINGUISHERS PER FIRE DEPARTMENT REQUIREMENT.

16. MM-80 AT SPEED BAY ONLY



hpa, inc.

18831 bardeen avenue - ste.

#100 irvine, ca

92612

tel: 949 •863 •1770

fax: 949 • 863 • 0851

email: hpa@hparchs.com

Owner:
DAWSON
CANYON LLC.

11777 San Vicente Blvd, Ste. 780 Los Angeles, CA 90049 tel: (949) 296-7006 fax: (949) 842-3074

TEMESCAL VALLEY
COMMERCE CENTER

DAWSON CANYON RD. CORONA, CA 92883

Civil: THIENES
Structural: Mechanical: TBD
Plumbing: TBD
Electrical: TBD
Landscape: HUNTER LANDSCAPE

Fire Protection:

Soils Engineer:

DCW3

OVERALL ELOOP PLAN

Title: OVERALL FLOOR PLAN

Project Number: 19277


Drawn by: AW


Date: 11/10/22


Revision:

Sheet:

6-DAB-A2.1

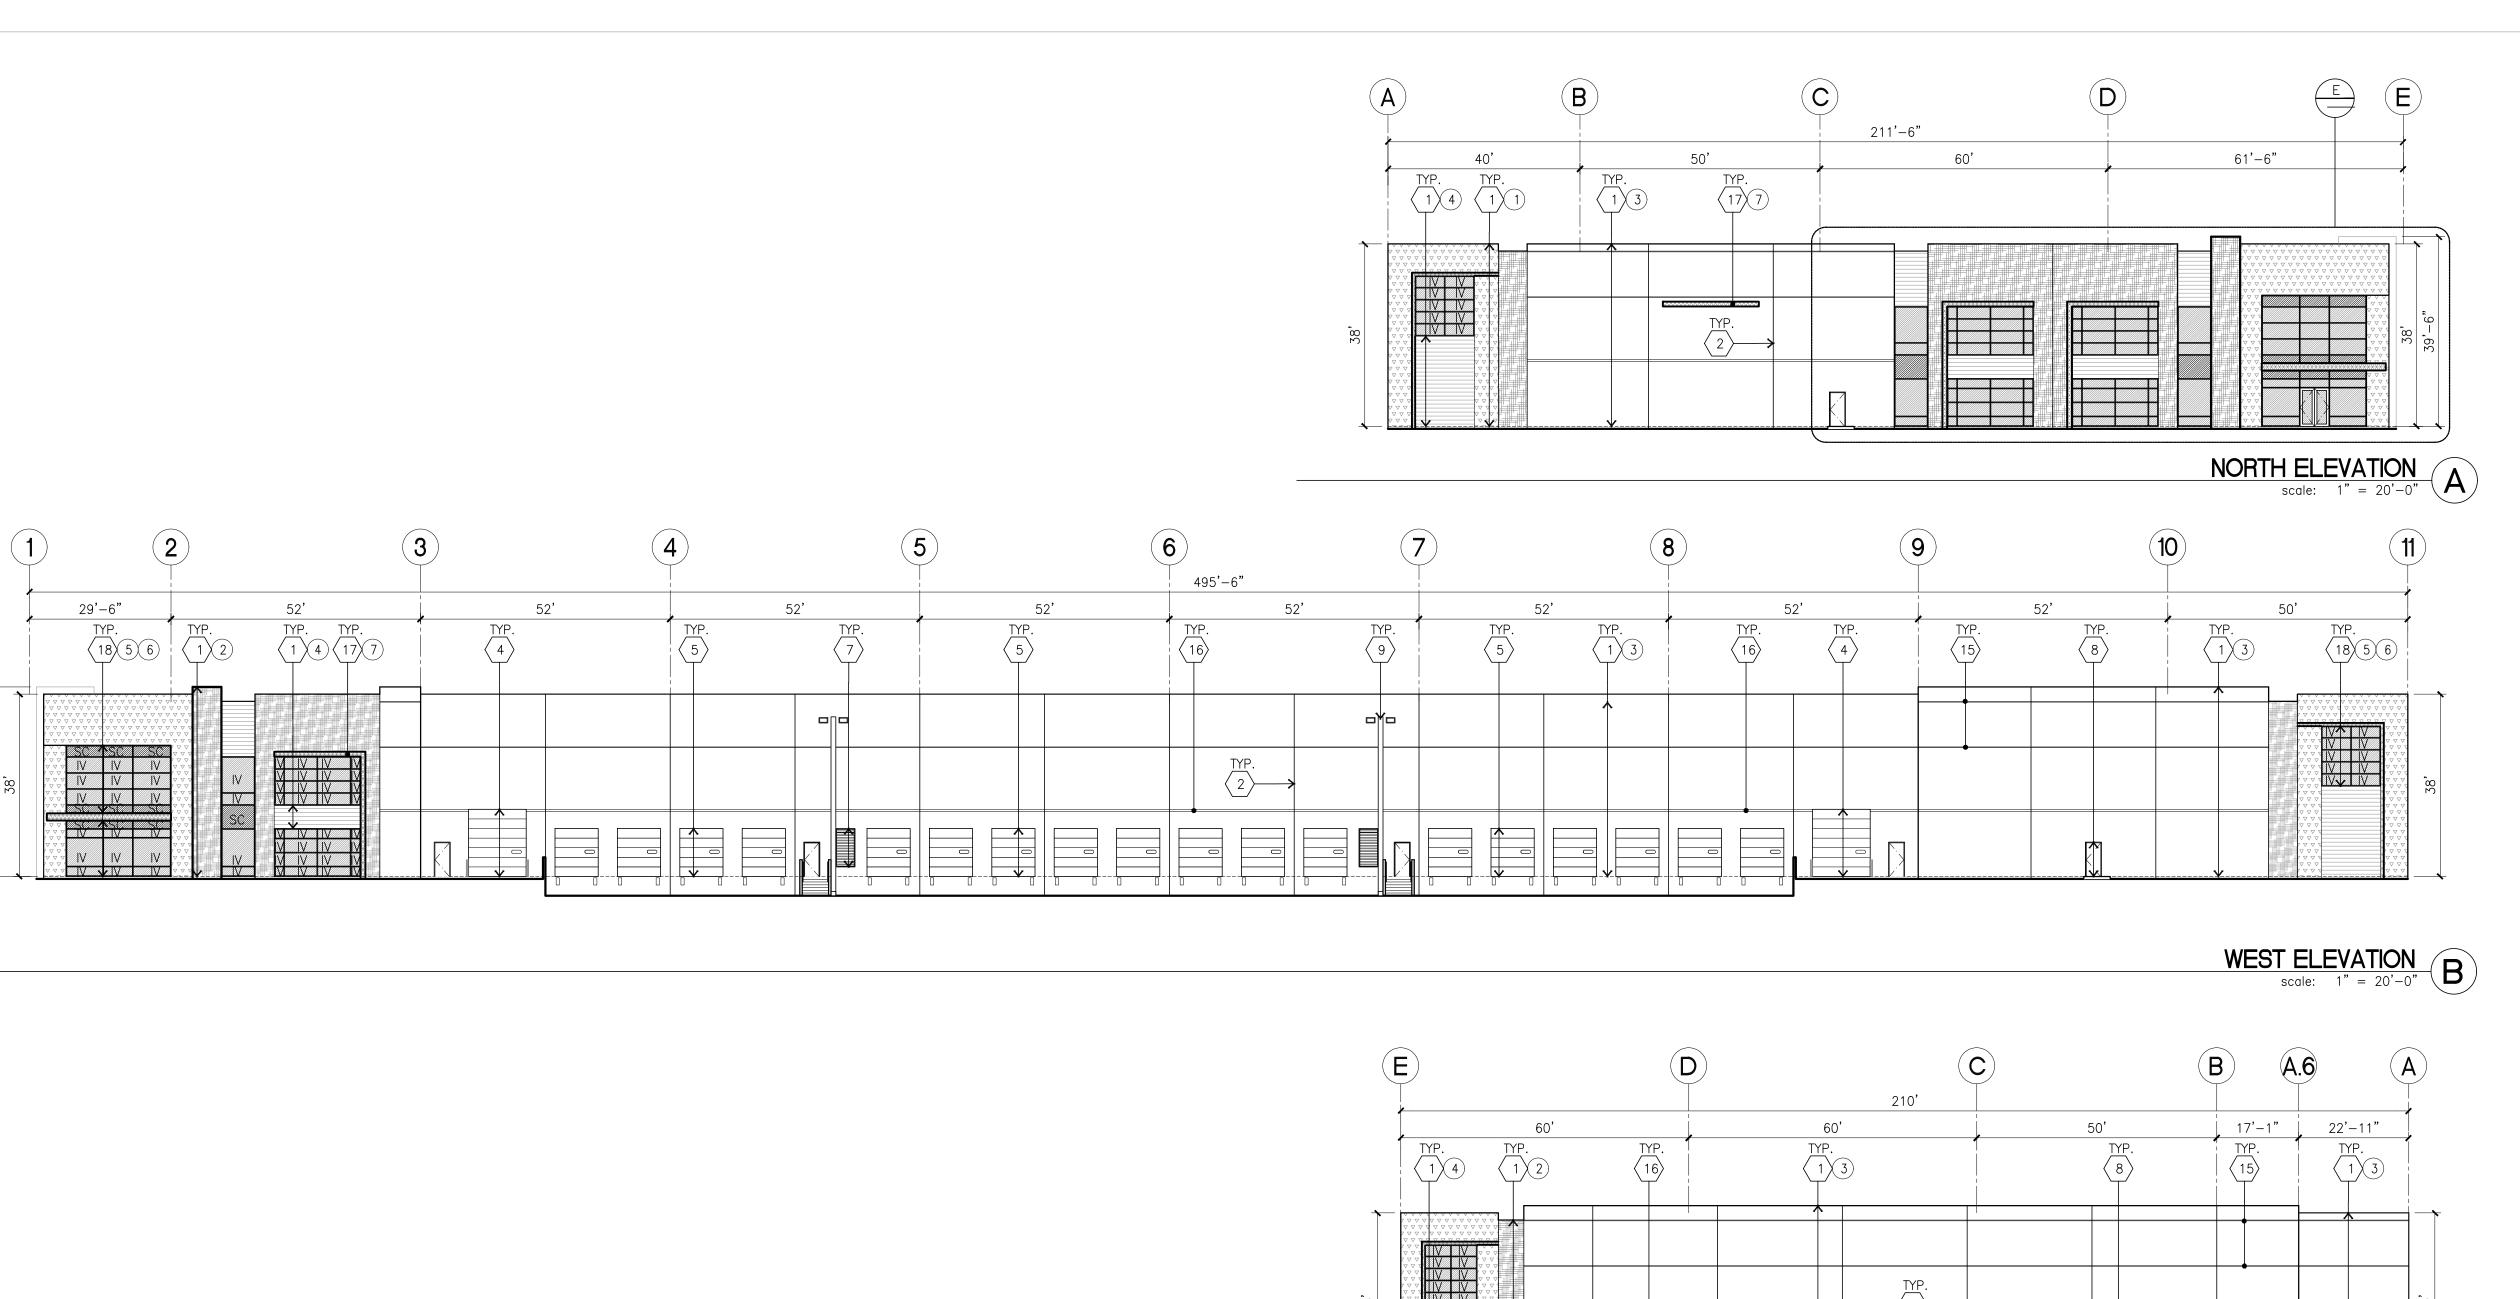

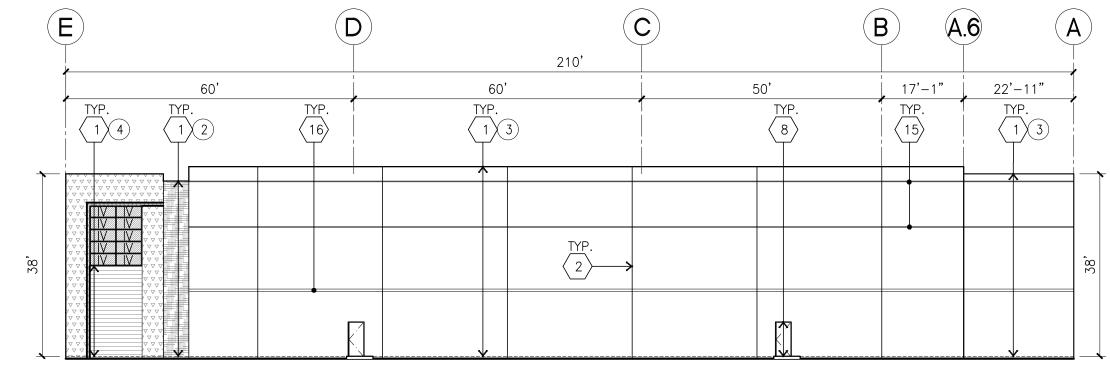


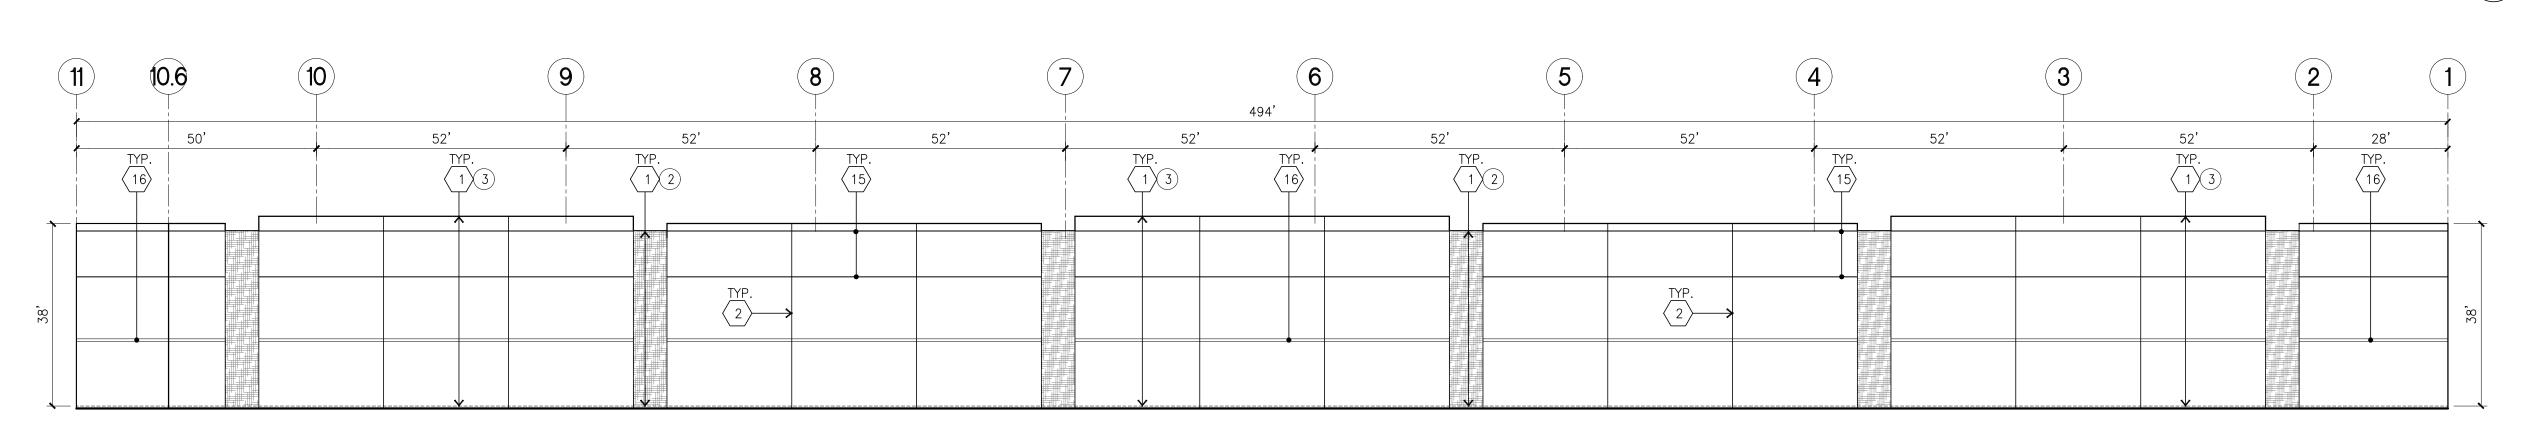

scale: 1" = 20'-0"

SOUTH ELEVATION

scale: 1" = 20'-0"

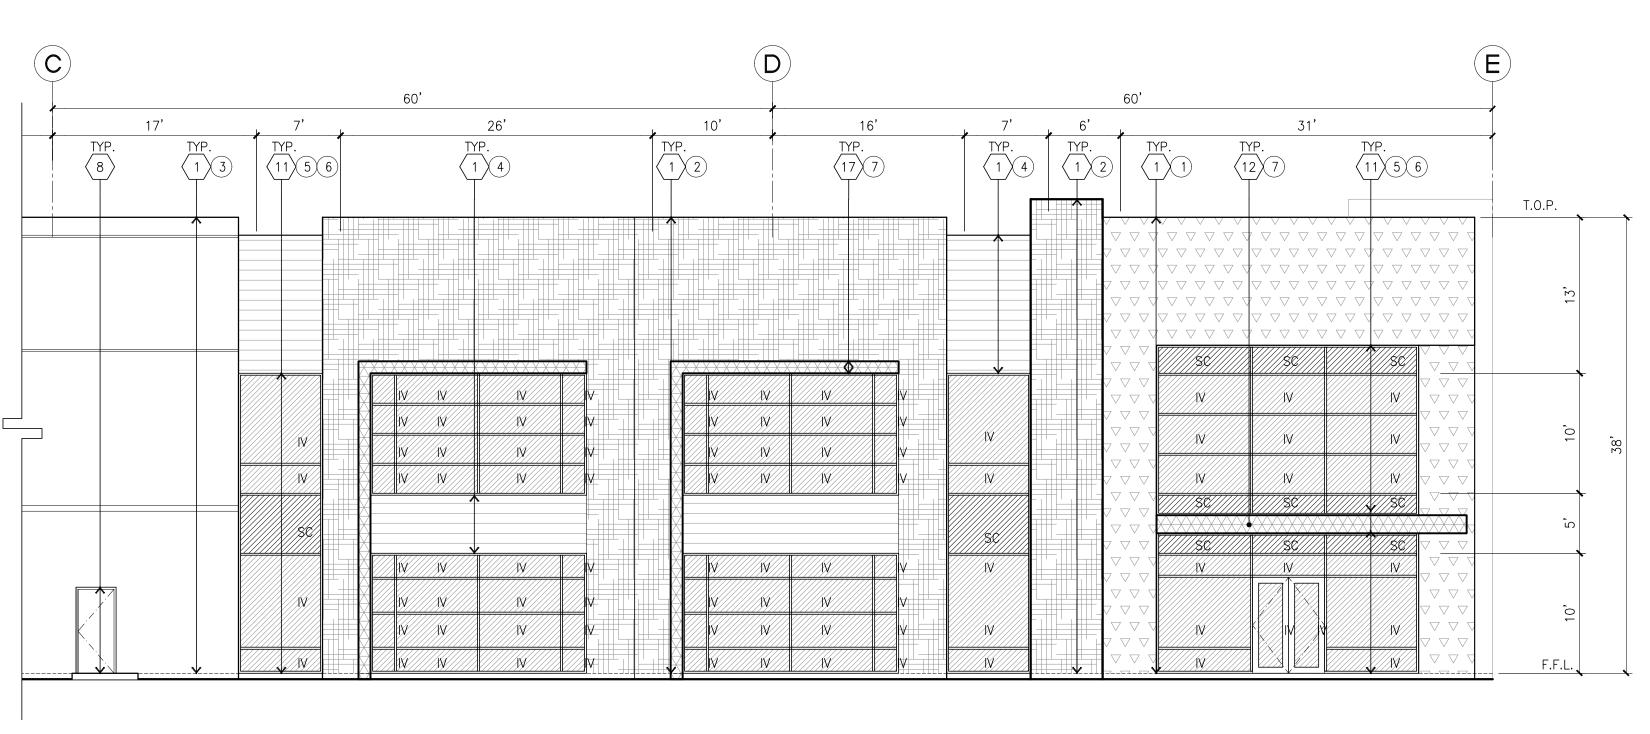

ENLARGED NORTH ELEVATION

scale: 1/8" = 1'-0"

ELEVATION KEYNOTES

- (1) CONCRETE TILT-UP PANEL.
- $\langle 2 \rangle$ PANEL JOINT.
- $\langle 3 \rangle$ NOT USED.
- 4 12' X 14' OVERHEAD DOOR @ DRIVE THRU. PROVIDE COMPLETE WEATHER-STRIPPING PROTECTION ALL AROUND.
- 9' X 10' OVERHEAD DOOR @ DRIVE THRU. PROVIDE COMPLETE / WEATHER-STRIPPING PROTECTION ALL AROUND.
- 6 CONCRETE STAIR, LANDING AND GUARDRAIL W/ METAL PIPE HANDRAIL. PROVIDE NON SKID NOSING TO MEET ADA REQUIREMENTS. PROVIDE CONTRASTING COLORED 3" WIDE WARNING STRIPE INTEGRAL TO CONCRETE AT TOP LANDING AND BOTTOM TREAD PER ADA REQUIREMENTS.
- 7 4' X 8' METAL LOUVER OPENING FOR VENTILATION. PAINT TO MATCH $\stackrel{\checkmark}{}$ BUILDING COLOR.
- 8 HOLLOW METAL DOORS. PROVIDE COMPLETE WEATHER STRIPING ALL AROUND DOOR.
- \langle 9 \rangle EXTERIOR DOWN SPOUTS W/ 2 OVERFLOW SCUPPERS.
- 10 DOCK DOOR BUMPER TYPICAL.
- ALUMINUM STOREFRONT FRAMING WITH TEMPERED GLAZING AT ALL DOORS, 18" ABOVE FINISH FLOOR ELEVATION.
- $\langle 12 \rangle$ METAL CANOPY.
- $\langle 13 \rangle$ INTERIOR ROOF DRAIN W/ 2 OVERFLOW SCUPPERS.
- (14) CONC. FILLED GUARD POST. 6" DIA. U.N.O. AT 42"H.
- 2" HORIZONTAL REVEAL WITH 3/8" CHAMFER. REVEAL COLOR TO MATCH $\stackrel{5}{\longrightarrow}$ adjacent building field colór. U.N.O.
- 6" HORIZONTAL REVEAL WITH 3/8" CHAMFER. REVEAL COLOR TO MATCH ADJACENT BUILDING FIELD COLOR. U.N.O.
- $\langle 17 \rangle$ METAL POP OUT HORIZONTAL FACADE ABOVE
- (18) ALUMINUM STOREFRONT FRAMING WITH GLAZING

ELEVATION GENERAL NOTES

- 1. ALL PAINT COLOR CHANGES TO OCCUR AT INSIDE CORNERS UNLESS NOTED OTHERWISE.
- 2. ALL PAINT FINISHES ARE TO BE FLAT UNLESS NOTED OTHERWISE.
- 3. T.O.P. EL.= TOP OF PARAPET ELEVATION.
- 4. F.F. = FINISH FLOOR ELEVATION.
- 5. STOREFRONT CONSTRUCTION: GLASS, METAL ATTACHMENTS AND LINTELS SHALL BE DESIGNED TO RESIST - MPH. EXPOSURE "C" WINDS. CONTRACTOR SHALL SUBMIT SHOP DRAWINGS PRIOR TO INSTALLATION.
- 6. CONTRACTOR SHALL FULLY PAINT ONE CONCRETE PANEL W/ SELECTED COLORS. ARCHITECT AND OWNER SHALL APPROVE PRIOR TO PAINTING REMAINDER OF BUILDING.
- 7. BACK SIDE OF PARAPETS TO HAVE SMOOTH FINISH AND BE PAINTED WITH ELECTROMETRIC PAINT. 8. FOR SPANDREL GLAZING, ALLOW SPACE BEHIND SPANDREL TO BREATH.
- PROVIDE 1" DIAMETER HOLES AT CONCRETE WALL.
- 9. USE ADHESIVE BACK WOOD STRIPS FOR ALL REVEAL FORMS. 10. THE FIRST COAT OF PAINT TO BE ROLLED-ON AND THE SECOND COAT TO BE SPRAYED-ON
- 11. ALL ROLL-UP DOORS AND SERVICE DOORS TO BE PAINTED TO MATCH BUILDING COLOR.

ELEVATION COLOR LEGEND/SCHED.

- PAINT. COLOR: SW 7525 TREE BRANCH (288C7)
- PAINT. COLOR: SW 7638 JOGGING PATH (247-C2)
- PAINT. COLOR: SW 9166 DRIFT OF MIST (238-C2)
- PAINT. COLOR: SW METAL PANEL LONGBOARD LIGHT BAMBOO
- MULLIONS COLOR : CLEAR ANODIZED
- GLAZING COLOR : BLUE REFLECTIVE
- METAL CANOPY WITH DUNN EDWARDS DEA 160 HOPE CHEST

GLAZING LEGEND

NOTE: ALL EXTERIOR AND INTERIOR GLAZING SHALL BE TEMPERED.

SPANDREL GLASS WITH CONCRETE BEHIND

SINGLE LITE VISION GLASS

- IV: INSULATED VISION GLASS

 1/4" VISTACOOL PACIFICA + 1/4" SOLARBAN 60 CLEAR

 1" INSULATED GLASS UNIT WITH 1/2" AIRSPACE AND 1/4" LITES
 U: 0.27 SHGC: 0.21 VLT: 26%

 MINIMUM VT TO BE 0.42 PER 2016 CEC TABLE 140.3—B
- SC: SPANDREL WITH CONCRETE BEHIND 1/4" VISTACOOL PACIFICA WITH WARM GRAY OPACICOAT PAINTED ON REFLECTIVE. INSTALLED ON CONCRETE.
- V : VISION GLASS 1/4" VISTACOOL PACIFICA
- MULLIONS : ANODIZED CLEAR.



hpa, inc. 18831 bardeen avenue - ste. #100 irvine, ca tel: 949 •863 •1770 fax: 949 • 863 • 0851 email: hpa@hparchs.com

Owner: DAWSON CANYON LLC.

11777 San Vicente Blvd, Ste. 780 Los Angeles, CA 90049 tel: (949) 296-7006 fax: (949) 842-3074

TEMESCAL VALLEY COMMERCE CENTER

> DAWSON CANYON RD. CORONA, CA 92883



THIENES Structural: TBD Mechanical: TBD Plumbing: TBD Electrical: Landscape: HUNTER LANDSCAPE Fire Protection:

DCW3


Soils Engineer:

Title:


ELEVATION

Project Number: Drawn by: 11/10/22 Date:

Revision:

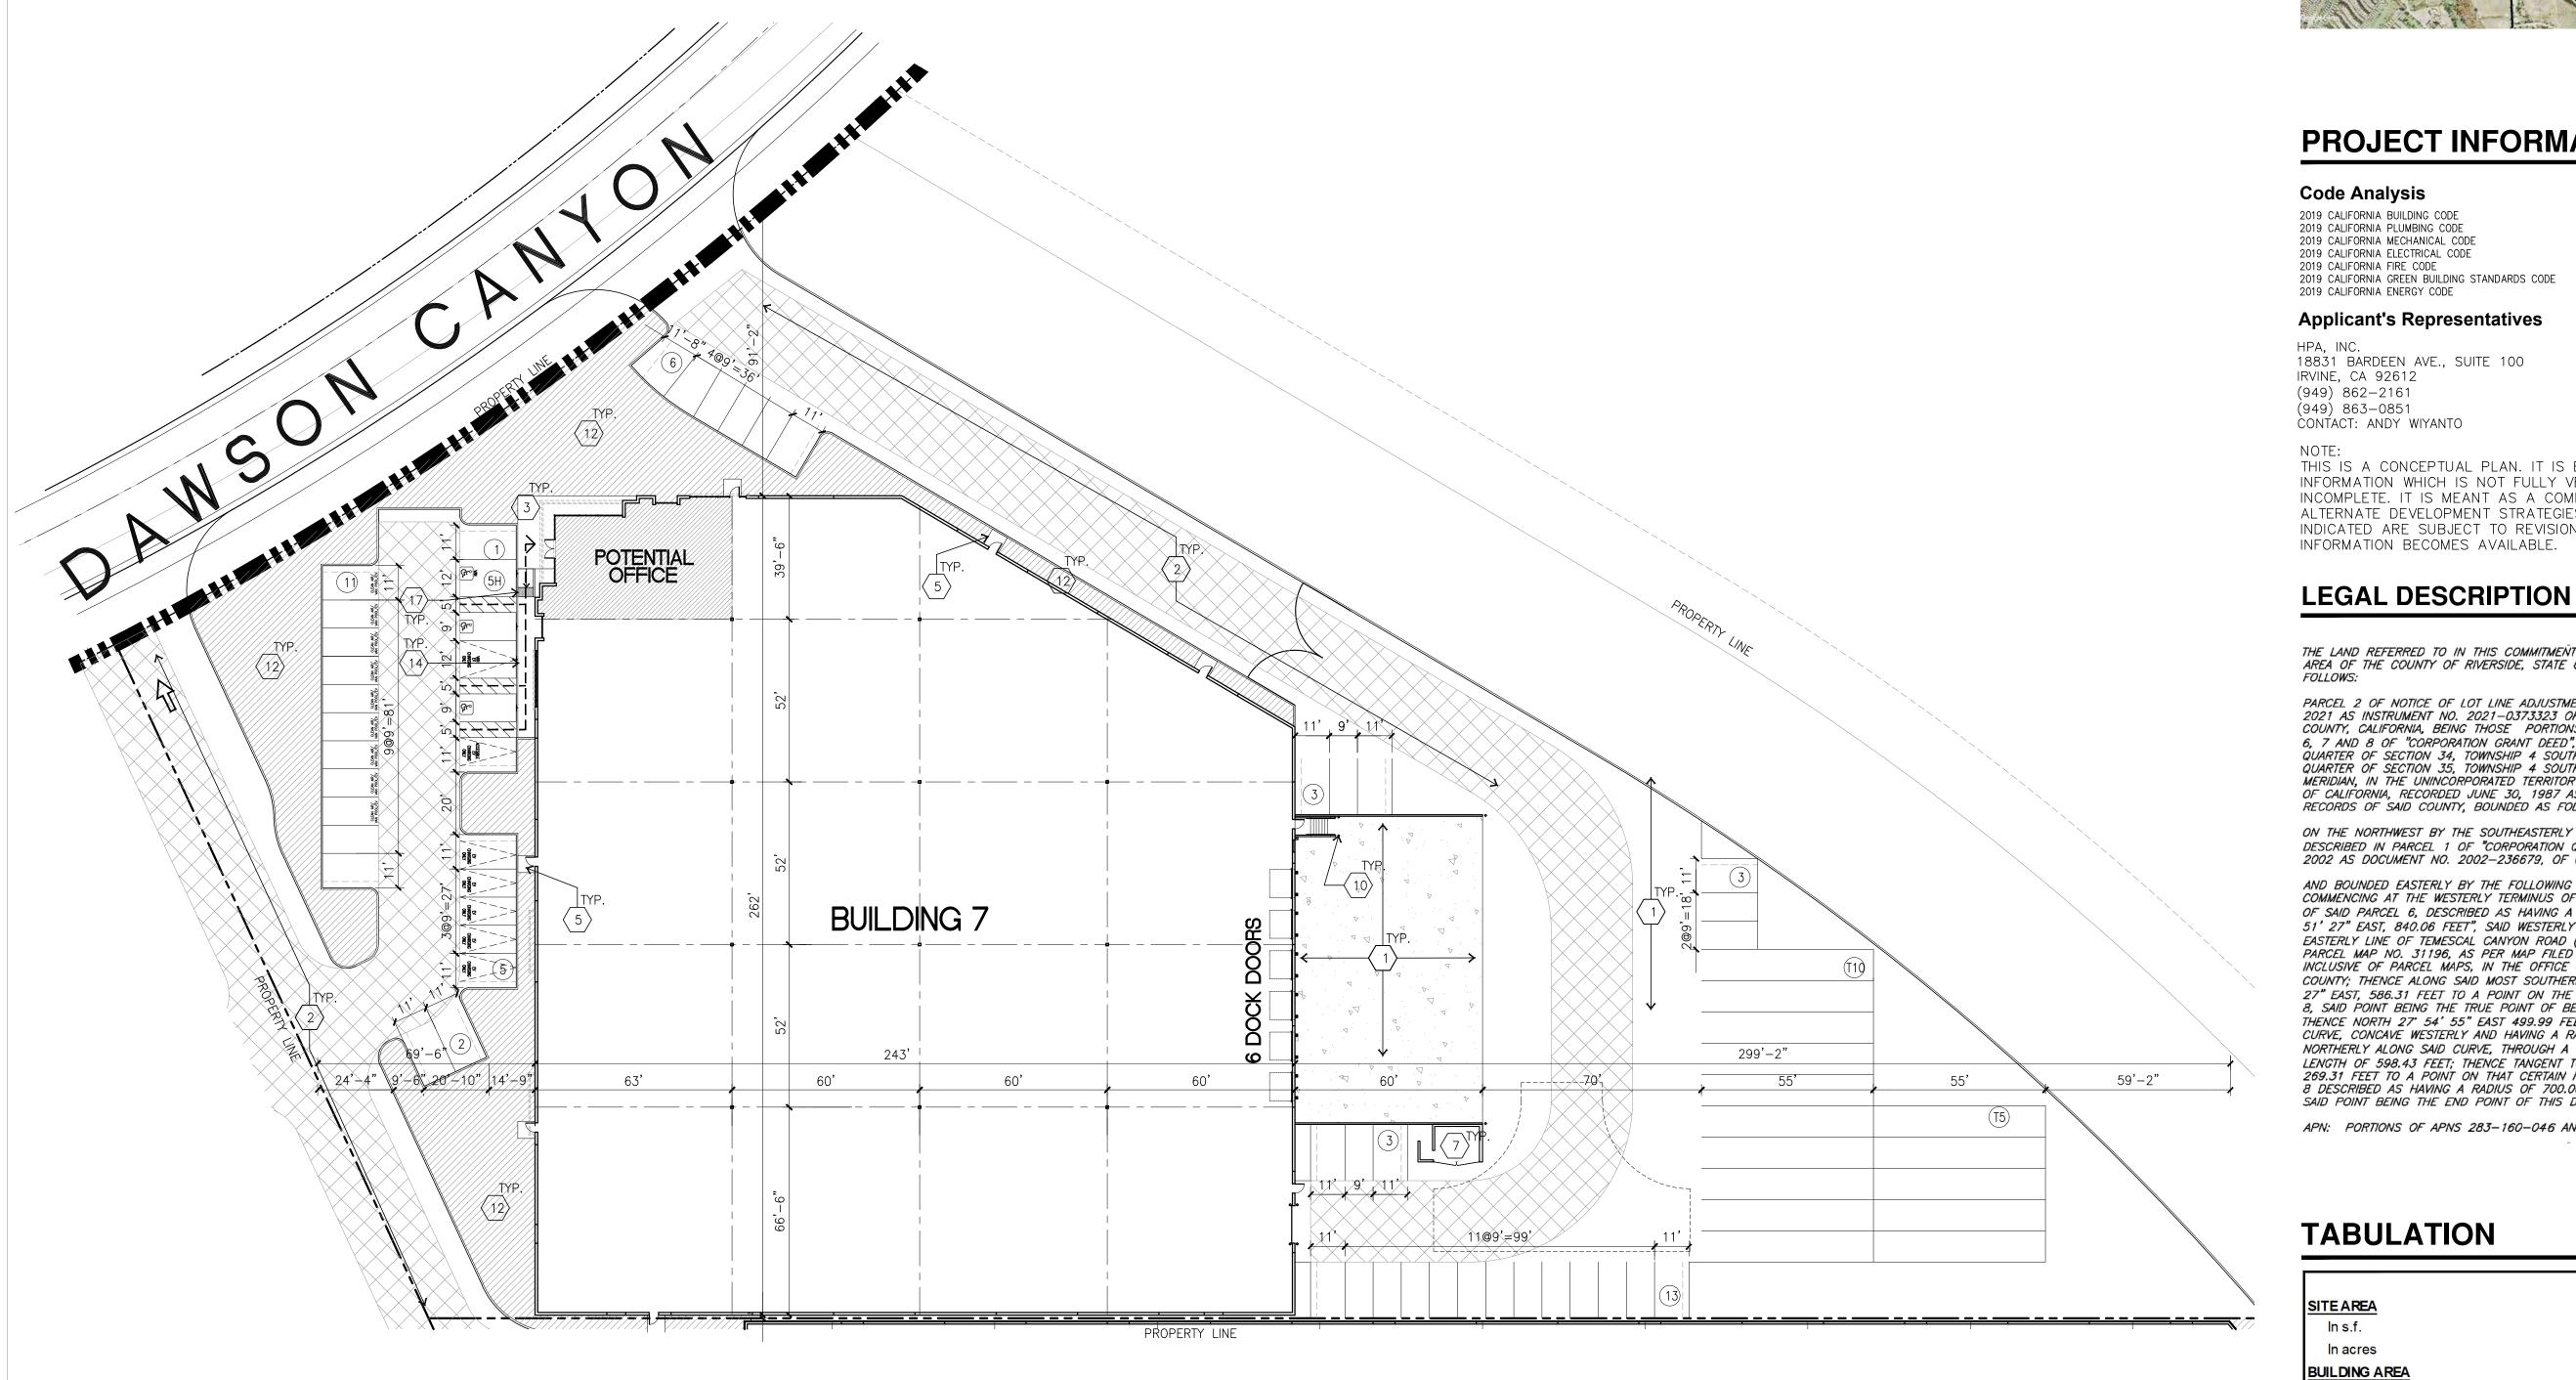

AERIAL MAP

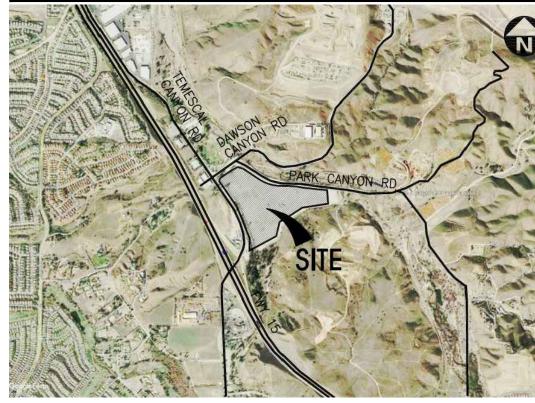

BUILDING OCCUPANCY : S-1 / B

CONSTRUCTION TYPE : III-B

FIRE SPRINKLER BUILDING

APN

283-160-046

283-190-044

PROJECT INFORMATION

Code Analysis 2019 CALIFORNIA BUILDING CODE 2019 CALIFORNIA PLUMBING CODE 2019 CALIFORNIA MECHANICAL CODE 2019 CALIFORNIA ELECTRICAL CODE 2019 CALIFORNIA FIRE CODE 2019 CALIFORNIA ENERGY CODE

2019 CALIFORNIA GREEN BUILDING STANDARDS CODE **Applicant's Representatives**

HPA, INC. 18831 BARDEEN AVE., SUITE 100 IRVINE, CA 92612 (949) 862-2161 (949) 863-0851 CONTACT: ANDY WIYANTO

THIS IS A CONCEPTUAL PLAN. IT IS BASED ON PRELIMINARY INFORMATION WHICH IS NOT FULLY VERIFIED AND MAY BE INCOMPLETE. IT IS MEANT AS A COMPARATIVE AID IN EXAMINING ALTERNATE DEVELOPMENT STRATEGIES AND ANY QUANTITIES INDICATED ARE SUBJECT TO REVISION AS MORE RELIABLE

INFORMATION BECOMES AVAILABLE.

FOLLOWS:

THE LAND REFERRED TO IN THIS COMMITMENT IS SITUATED IN THE UNINCORPORATED AREA OF THE COUNTY OF RIVERSIDE, STATE OF CALIFORNIA, AND IS DESCRIBED AS

PARCEL 2 OF NOTICE OF LOT LINE ADJUSTMENT NO. LLA200028, RECORDED JUNE 21, 2021 AS INSTRUMENT NO. 2021—0373323 OF OFFICIAL RECORDS OF RIVERSIDE COUNTY, CALIFORNIA, BEING THOSE PORTIONS OF THE LAND DESCRIBED IN PARCELS 6, 7 AND 8 OF "CORPORATION GRANT DEED", IN THE EAST HALF OF THE NORTHEAST QUARTER OF SECTION 34, TOWNSHIP 4 SOUTH, RANGE 6 WEST AND THE NORTHWEST QUARTER OF SECTION 35, TOWNSHIP 4 SOUTH, RANGE 6 WEST, SAN BERNARDINO MERIDIAN, IN THE UNINCORPORATED TERRITORY OF THE COUNTY OF RIVERSIDE, STATE OF CALIFORNIA, RECORDED JUNE 30, 1987 AS INSTRUMENT NO. 186951, OF OFFICIAL RECORDS OF SAID COUNTY, BOUNDED AS FOLLOWS:

ON THE NORTHWEST BY THE SOUTHEASTERLY LINE OF DAWSON CANYON ROAD AS DESCRIBED IN PARCEL 1 OF "CORPORATION QUITCLAIM DEED", RECORDED MAY 03, 2002 AS DOCUMENT NO. 2002-236679, OF OFFICIAL RECORDS OF SAID COUNTY;

AND BOUNDED EASTERLY BY THE FOLLOWING DESCRIBED LINE: COMMENCING AT THE WESTERLY TERMINUS OF THAT CERTAIN MOST SOUTHERLY LINE OF SAID PARCEL 6, DESCRIBED AS HAVING A BEARING AND DISTANCE OF "NORTH 89" 51' 27" EAST, 840.06 FEET", SAID WESTERLY TERMINUS ALSO BEING ON THE EASTERLY LINE OF TEMESCAL CANYON ROAD (40.00 FEET HALF-WIDE) AS SHOWN ON PARCEL MAP NO. 31196, AS PER MAP FILED IN BOOK 208, PAGES 50 THROUGH 53, INCLUSIVE OF PARCEL MAPS, IN THE OFFICE OF THE COUNTY RECORDER OF SAID COUNTY; THENCE ALONG SAID MOST SOUTHERLY LINE OF PARCEL 6, NORTH 89' 51' 27" EAST, 586.31 FEET TO A POINT ON THE MOST SOUTHERLY LINE OF SAID PARCEL 8, SAID POINT BEING THE TRUE POINT OF BEGINNING; THENCE NORTH 27" 54' 55" EAST 499.99 FEET TO THE BEGINNING OF A TANGENT CURVE, CONCAVE WESTERLY AND HAVING A RADIUS OF 1080.00 FEET; THENCE NORTHERLY ALONG SAID CURVE, THROUGH A CENTRAL ANGLE OF 31° 44' 51", AN ARC LENGTH OF 598.43 FEET; THENCE TANGENT TO SAID CURVE, NORTH 03' 46' 59" WEST 269.31 FEET TO A POINT ON THAT CERTAIN NORTHERLY CURVED LINE OF SAID PARCEL 8 DESCRIBED AS HAVING A RADIUS OF 700.00 FEET AND A LENGTH OF 143.85 FEET, SAID POINT BEING THE END POINT OF THIS DESCRIPTION.

APN: PORTIONS OF APNS 283-160-046 AND 283-190-044

TABULATION

Side/Rear - None

	BLDG. 7
SITE AREA	
In s.f.	149,280
In acres	3.427
BUILDING AREA	
Office	3,000
Mezzanine	3,000
Warehouse	55,762
TOTAL	61,762
COVERAGE	39.4%
CLEARANCE	32'
AUTO PARKING REQUIRED	
Office: 1/250 s.f.	24
Warehouse: 1/2,000 s.f.	28
TOTAL	52
AUTO PARKING STALLS PROVIDED	
Standard (9' x 18')	33
Accessible Parking (9' x 18')	2
Accessible Van Parking (12' x 18')	1
EV Standard (9' x 18')	5
EV Accessible (9' x 18')	1
EV Van Accessible (12' x 18')	1
EV Ambulatory	
Clean Air Vehicle (9' x 18')	9
TOTAL	52
TRAILER PARKING PROVIDED	
Trailer (10' x 55')	15
ZONING ORDINANCE FOR COUNTY	
M-M Manufacturing Medium	
M-R-A Mineral Resources and Related Manufacturing	
MAXIMUM BUILDING HEIGHT ALLOWED	
Height - 50'	
MAXIMUM FLOOR AREA RATIO	
FAR (Total gross area/site):	41.4%
LANDSCAPE REQUIREMENT	
Required landscape area (10%):	14,928
Provided area:	12,249
SETBACKS	
Building	
Street Front - 25'	

SITE PLAN KEYNOTES

- \langle 1 \rangle HEAVY BROOM FINISH CONCRETE PAVEMENT.
- \langle 2 \rangle ASPHALT CONCRETE (AC) PAVING.
- (3) CONCRETE WALKWAY, MEDIUM BROOM FINISH.
- \langle 4 angle driveway aprons to be constructed per civil drawings.
- \langle 5 \rangle 5'-6" x 5'-6" x 4" THICK CONCRETE EXTERIOR LANDING PAD TYP. AT ALL EXTERIOR MAN DOORS TO LANDSCAPED AREAS. FINISH TO BE MEDIUM BROOM
- PROVIDE 8' HIGH METAL GATES W/ KNOX-BOX PER FIRE DEPARTMENT STANDARDS PER DRIVEWAY.
- \langle 7 \rangle TRASH ENCLOSURE PER CITY STANDARD.
- \langle 8 angle APPROXIMATE LOCATION OF TRANSFORMER. \langle 9 \rangle PRE-CAST CONCRETE WHEEL STOP.
- $\langle 10
 angle$ concrete filled guard post "6 dia. u.n.o. at 42" h.
- $\langle 11 \rangle$ DESIGNATED SMOKING AREA.
- (12) LANDSCAPE. ALL LANDSCAPE AREAS INDICATED BY SHADING.
- (14) ACCESSIBLE PARKING STALL SIGN.
- $\langle 15 \rangle 14'-0"$ SCREEN WALL

13 MONUMENT SIGN.

- (16) 42" HIGH CONCRETE GUARDWALL.
- $\langle 17 \rangle$ TRUNCATED DOME.
- $\langle 18 \rangle$ NOT USED.
- **Construction Type** (19) EXTERIOR CONCRETE STAIR WITH GUARDWALL AND HANDRAIL CONCRETE TILT-UP BUILDING
 - $\langle 20 \rangle$ EXTERIOR BIKE RACK.
 - $\langle 21 \rangle$ 8' HIGH METAL FENCE

SITE PLAN GENERAL NOTES

- 1. THE SITE PLAN BASED ON THE SOILS REPORT PREPARED BY:
- 2. IF SOILS ARE EXPANSIVE IN NATURE, USE STEEL REINFORCING FOR ALL SITE
- 3. ALL DIMENSIONS ARE TO THE FACE OF CONCRETE WALL, FACE OF CONCRETE CURB OR GRID LINE U.N.O.
- 4. SEE "C" PLANS FOR ALL CONCRETE CURBS, GUTTERS AND SWALES.
- 5. THE ENTIRE PROJECT SHALL BE PERMANENTLY MAINTAINED WITH AN AUTOMATIC IRRIGATION SYSTEM.
- 6. SEE "C" DRAWINGS FOR POINT OF CONNECTIONS TO OFF-SITE UTILITIES. CONTRACTOR SHALL VERIFY ACTUAL UTILITY LOCATIONS.
- 7. PROVIDE POSITIVE DRAINAGE AWAY FROM BLDG. SEE "C" DRAWINGS.
- 8. CONTRACTOR TO REFER TO "C" DRAWINGS FOR ALL HORIZONTAL CONTROL DIMENSIONS. SITE PLANS ARE FOR GUIDANCE AND STARTING LAYOUT POINTS.
- 9. SEE "C"DRAWINGS FOR FINISH GRADE ELEVATIONS.
- 10. CONCRETE SIDEWALKS TO BE A MINIMUM OF 4" THICK W/ TOOLED JOINTS AT 6' O.C. EXPANSION/CONSTRUCTION JOINTS SHALL BE A MAXIMUM 12' EA. WAY. EXPANSION JOINTS TO HAVE COMPRESSIVE EXPANSION FILLER MATERIAL OF 1/4". FINISH TO BE A MEDIUM BROOM FINISH U.N.O.
- 11. PAINT CURBS AND PROVIDE SIGNS TO INFORM OF FIRE LANES AS REQUIRED BY FIRE DEPARTMENT.
- 12. CONSTRUCTION DOCUMENTS PERTAINING TO THE LANDSCAPE AND IRRIGATION OF THE ENTIRE PROJECT SITE SHALL BE SUBMITTED TO THE BUILDING DEPARTMENT AND APPROVED BY PUBLIC FACILITIES DEVELOPMENT PRIOR TO ISSUANCE OF
- 13. PRIOR TO FINAL CITY INSPECTION, THE LANDSCAPE ARCHITECT SHALL SUBMIT A CERTIFICATE OF COMPLETION TO PUBLIC FACILITIES DEVELOPMENT.
- 14. ALL LANDSCAPE AND IRRIGATION DESIGNS SHALL MEET CURRENT CITY STANDARDS AS LISTED IN GUIDELINES OR AS OBTAINED FROM PUBLIC FACILITIES
- 15. LANDSCAPED AREAS SHALL BE DELINEATED WITH A MINIMUM SIX INCHES (6")

SITE LEGEND


HIGH CURB.

4 4	CONCRETE PAVING SEE "C" DRWGS. FOR THICKNESS		LANDSCAPED AREA
	ASPHALT CONCRETE PAVING		PATH OF TRAVEL
	SEE "C" DRWGS. FOR THICKNESS		26' WIDE FIRELANE
	STANDARD PARKING STALL (9' X 18')		EXISTING PUBLIC FIRE HYDRANT
	STANDARD PARKING STALL W/ 2' OVERHANG	₽ F.H.	PRIVATE FIRE HYDRANT- APPROXIMATE LOCATION
	COMPACT PARKING STALL (8.5' X 16') MAX. 40% OF REQUIRED		ACCESSIBLE PARKING (V
	ACCESSIBLE PARKING STALL (9' X 18') + 5' W/ ACCESSIBLE AISLE		CTALL (10' V 10') L
A VICENCY /	EV PARKING		
<u></u>	CLEAN AIR/VANPOOL/EV		

KEY MAP

(PROVIDE CONDUIT FOR FUTURE EV CHARGING)

EV AMBULATORY PARKING _____ STALL (10' X 18')

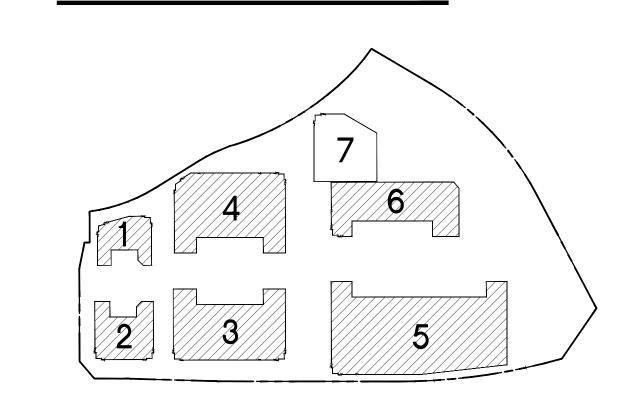



hpa, inc. 18831 bardeen avenue - ste. #100 irvine, ca tel: 949 •863 •1770 fax: 949 • 863 • 0851 email: hpa@hparchs.com



Owner: DAWSON CANYON LLC.

11777 San Vicente Blvd, Ste. 780 Los Angeles, CA 90049 tel: (949) 296-7006 fax: (949) 842-3074

TEMESCAL VALLEY

COMMERCE CENTER

DAWSON CANYON RD. CORONA, CA 92883


THIENES

Mechanical:	TBD
Plumbing:	TBD
Electrical:	TBD
Landscape:	HUNTER LANDSCAPE
Fire Protection:	
Soils Engine	er: DCW3

Structural:

Title: OVERALL SITE PLAN

Project Number: Drawn by: 11/10/22 Date: Revision:

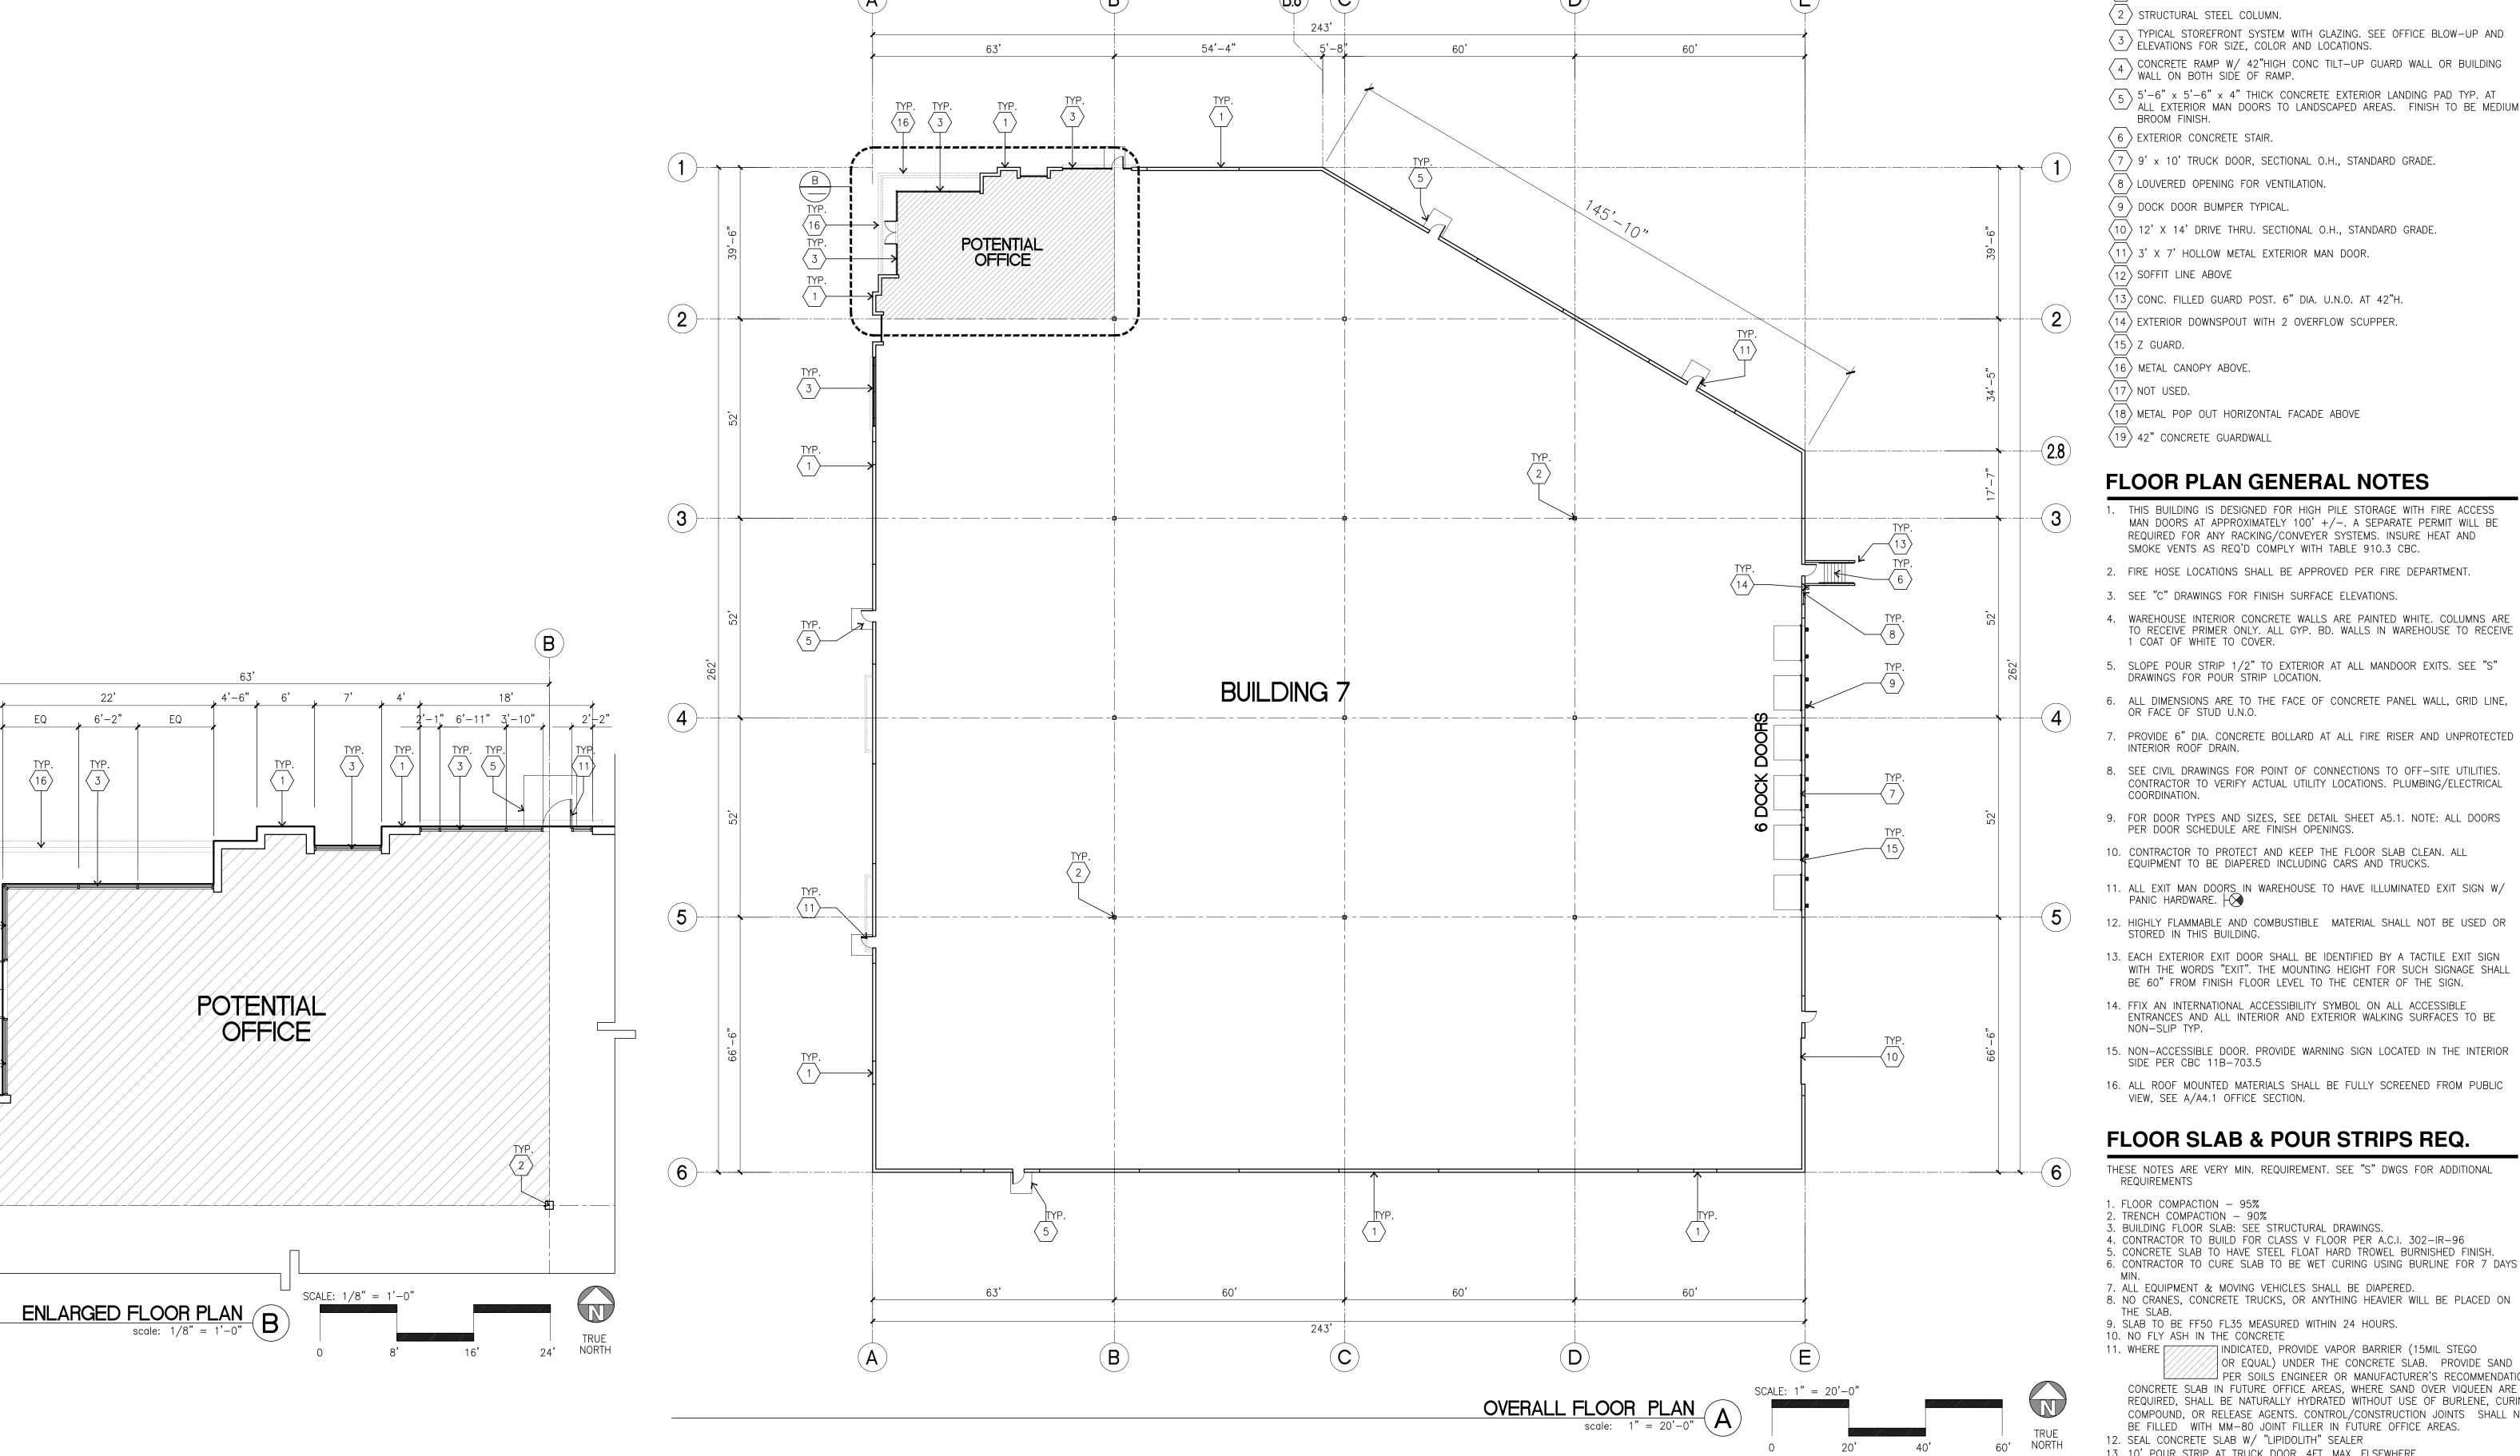

 \langle 1 \rangle CONCRETE TILT-UP PANEL.

(2) STRUCTURAL STEEL COLUMN.

TYPICAL STOREFRONT SYSTEM WITH GLAZING. SEE OFFICE BLOW-UP AND $\stackrel{3}{>}$ ELEVATIONS FOR SIZE, COLOR AND LOCATIONS. CONCRETE RAMP W/ 42"HIGH CONC TILT-UP GUARD WALL OR BUILDING WALL ON BOTH SIDE OF RAMP.

5 5'-6" x 5'-6" x 4" THICK CONCRETE EXTERIOR LANDING PAD TYP. AT ALL EXTERIOR MAN DOORS TO LANDSCAPED AREAS. FINISH TO BE MEDIUM

BROOM FINISH. $\langle 6 \rangle$ EXTERIOR CONCRETE STAIR.

 $\langle 7 \rangle$ 9' x 10' TRUCK DOOR, SECTIONAL O.H., STANDARD GRADE.

 \langle 8 \rangle LOUVERED OPENING FOR VENTILATION.

(9) DOCK DOOR BUMPER TYPICAL.

(10) 12' X 14' DRIVE THRU. SECTIONAL O.H., STANDARD GRADE.

 $\langle 11 \rangle$ 3' X 7' HOLLOW METAL EXTERIOR MAN DOOR.

(12) SOFFIT LINE ABOVE

13 CONC. FILLED GUARD POST. 6" DIA. U.N.O. AT 42"H. $\langle 14 \rangle$ EXTERIOR DOWNSPOUT WITH 2 OVERFLOW SCUPPER.

 $\langle 15 \rangle$ Z GUARD.

 $\langle 16 \rangle$ METAL CANOPY ABOVE.

 $\langle 17 \rangle$ NOT USED.

(18) METAL POP OUT HORIZONTAL FACADE ABOVE $\langle 19 \rangle$ 42" CONCRETE GUARDWALL

FLOOR PLAN GENERAL NOTES

1. THIS BUILDING IS DESIGNED FOR HIGH PILE STORAGE WITH FIRE ACCESS MAN DOORS AT APPROXIMATELY 100' +/-. A SEPARATE PERMIT WILL BE REQUIRED FOR ANY RACKING/CONVEYER SYSTEMS. INSURE HEAT AND SMOKE VENTS AS REQ'D COMPLY WITH TABLE 910.3 CBC.

2. FIRE HOSE LOCATIONS SHALL BE APPROVED PER FIRE DEPARTMENT.

3. SEE "C" DRAWINGS FOR FINISH SURFACE ELEVATIONS.

4. WAREHOUSE INTERIOR CONCRETE WALLS ARE PAINTED WHITE. COLUMNS ARE TO RECEIVE PRIMER ONLY. ALL GYP. BD. WALLS IN WAREHOUSE TO RECEIVE 1 COAT OF WHITE TO COVER.

5. SLOPE POUR STRIP 1/2" TO EXTERIOR AT ALL MANDOOR EXITS. SEE "S" DRAWINGS FOR POUR STRIP LOCATION.

6. ALL DIMENSIONS ARE TO THE FACE OF CONCRETE PANEL WALL, GRID LINE, OR FACE OF STUD U.N.O.

INTERIOR ROOF DRAIN. 8. SEE CIVIL DRAWINGS FOR POINT OF CONNECTIONS TO OFF-SITE UTILITIES. CONTRACTOR TO VERIFY ACTUAL UTILITY LOCATIONS. PLUMBING/ELECTRICAL

COORDINATION. 9. FOR DOOR TYPES AND SIZES, SEE DETAIL SHEET A5.1. NOTE: ALL DOORS

PER DOOR SCHEDULE ARE FINISH OPENINGS. 10. CONTRACTOR TO PROTECT AND KEEP THE FLOOR SLAB CLEAN. ALL

EQUIPMENT TO BE DIAPERED INCLUDING CARS AND TRUCKS.

11. ALL EXIT MAN DOORS IN WAREHOUSE TO HAVE ILLUMINATED EXIT SIGN W/PANIC HARDWARE. +

12. HIGHLY FLAMMABLE AND COMBUSTIBLE MATERIAL SHALL NOT BE USED OR STORED IN THIS BUILDING.

13. EACH EXTERIOR EXIT DOOR SHALL BE IDENTIFIED BY A TACTILE EXIT SIGN WITH THE WORDS "EXIT". THE MOUNTING HEIGHT FOR SUCH SIGNAGE SHALL BE 60" FROM FINISH FLOOR LEVEL TO THE CENTER OF THE SIGN.

14. FFIX AN INTERNATIONAL ACCESSIBILITY SYMBOL ON ALL ACCESSIBLE ENTRANCES AND ALL INTERIOR AND EXTERIOR WALKING SURFACES TO BE

15. NON-ACCESSIBLE DOOR. PROVIDE WARNING SIGN LOCATED IN THE INTERIOR SIDE PER CBC 11B-703.5

16. ALL ROOF MOUNTED MATERIALS SHALL BE FULLY SCREENED FROM PUBLIC VIEW, SEE A/A4.1 OFFICE SECTION.

FLOOR SLAB & POUR STRIPS REQ.

THESE NOTES ARE VERY MIN. REQUIREMENT. SEE "S" DWGS FOR ADDITIONAL REQUIREMENTS

1. FLOOR COMPACTION - 95%

2. TRENCH COMPACTION - 90% 3. BUILDING FLOOR SLAB: SEE STRUCTURAL DRAWINGS.

4. CONTRACTOR TO BUILD FOR CLASS V FLOOR PER A.C.I. 302-IR-96 5. CONCRETE SLAB TO HAVE STEEL FLOAT HARD TROWEL BURNISHED FINISH.


6. CONTRACTOR TO CURE SLAB TO BE WET CURING USING BURLINE FOR 7 DAYS 7. ALL EQUIPMENT & MOVING VEHICLES SHALL BE DIAPERED.

8. NO CRANES, CONCRETE TRUCKS, OR ANYTHING HEAVIER WILL BE PLACED ON

9. SLAB TO BE FF50 FL35 MEASURED WITHIN 24 HOURS. 10. NO FLY ASH IN THE CONCRETE

11. WHERE ///// INDICATED, PROVIDE VAPOR BARRIER (15MIL STEGO OR EQUAL) UNDER THE CONCRETE SLAB. PROVIDE SAND PER SOILS ENGINEER OR MANUFACTURER'S RECOMMENDATION. CONCRETE SLAB IN FUTURE OFFICE AREAS, WHERE SAND OVER VIQUEEN ARE REQUIRED, SHALL BE NATURALLY HYDRATED WITHOUT USE OF BURLENE, CURING COMPOUND, OR RELEASE AGENTS. CONTROL/CONSTRUCTION JOINTS SHALL NOT BE FILLED WITH MM-80 JOINT FILLER IN FUTURE OFFICE AREAS.

13. 10' POUR STRIP AT TRUCK DOOR. 4FT. MAX. ELSEWHERE. 14. ALL FLOOR SLAB NAIL OR BRACE FRAME HOLES FILLED WITH APPROVED 2 PART EPOXY COMPOUND TO MATCH CONCRETE COLOR. PEGA BOND LV 2000, BURKE

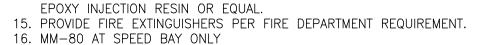



hpa, inc. 18831 bardeen avenue - ste. #100 irvine, ca tel: 949 •863 •1770 fax: 949 • 863 • 0851 email: hpa@hparchs.com



11777 San Vicente Blvd, Ste. 780 Los Angeles, CA 90049 tel: (949) 296-7006 fax: (949) 842-3074

TEMESCAL VALLEY COMMERCE CENTER

> DAWSON CANYON RD. CORONA, CA 92883



DCW3


Structural: Mechanical: TBD Plumbing: Electrical: Landscape: HUNTER LANDSCAPE Fire Protection:


Title: OVERALL FLOOR PLAN

Project Number: Drawn by: 11/10/22 Date:

Revision:


Soils Engineer:

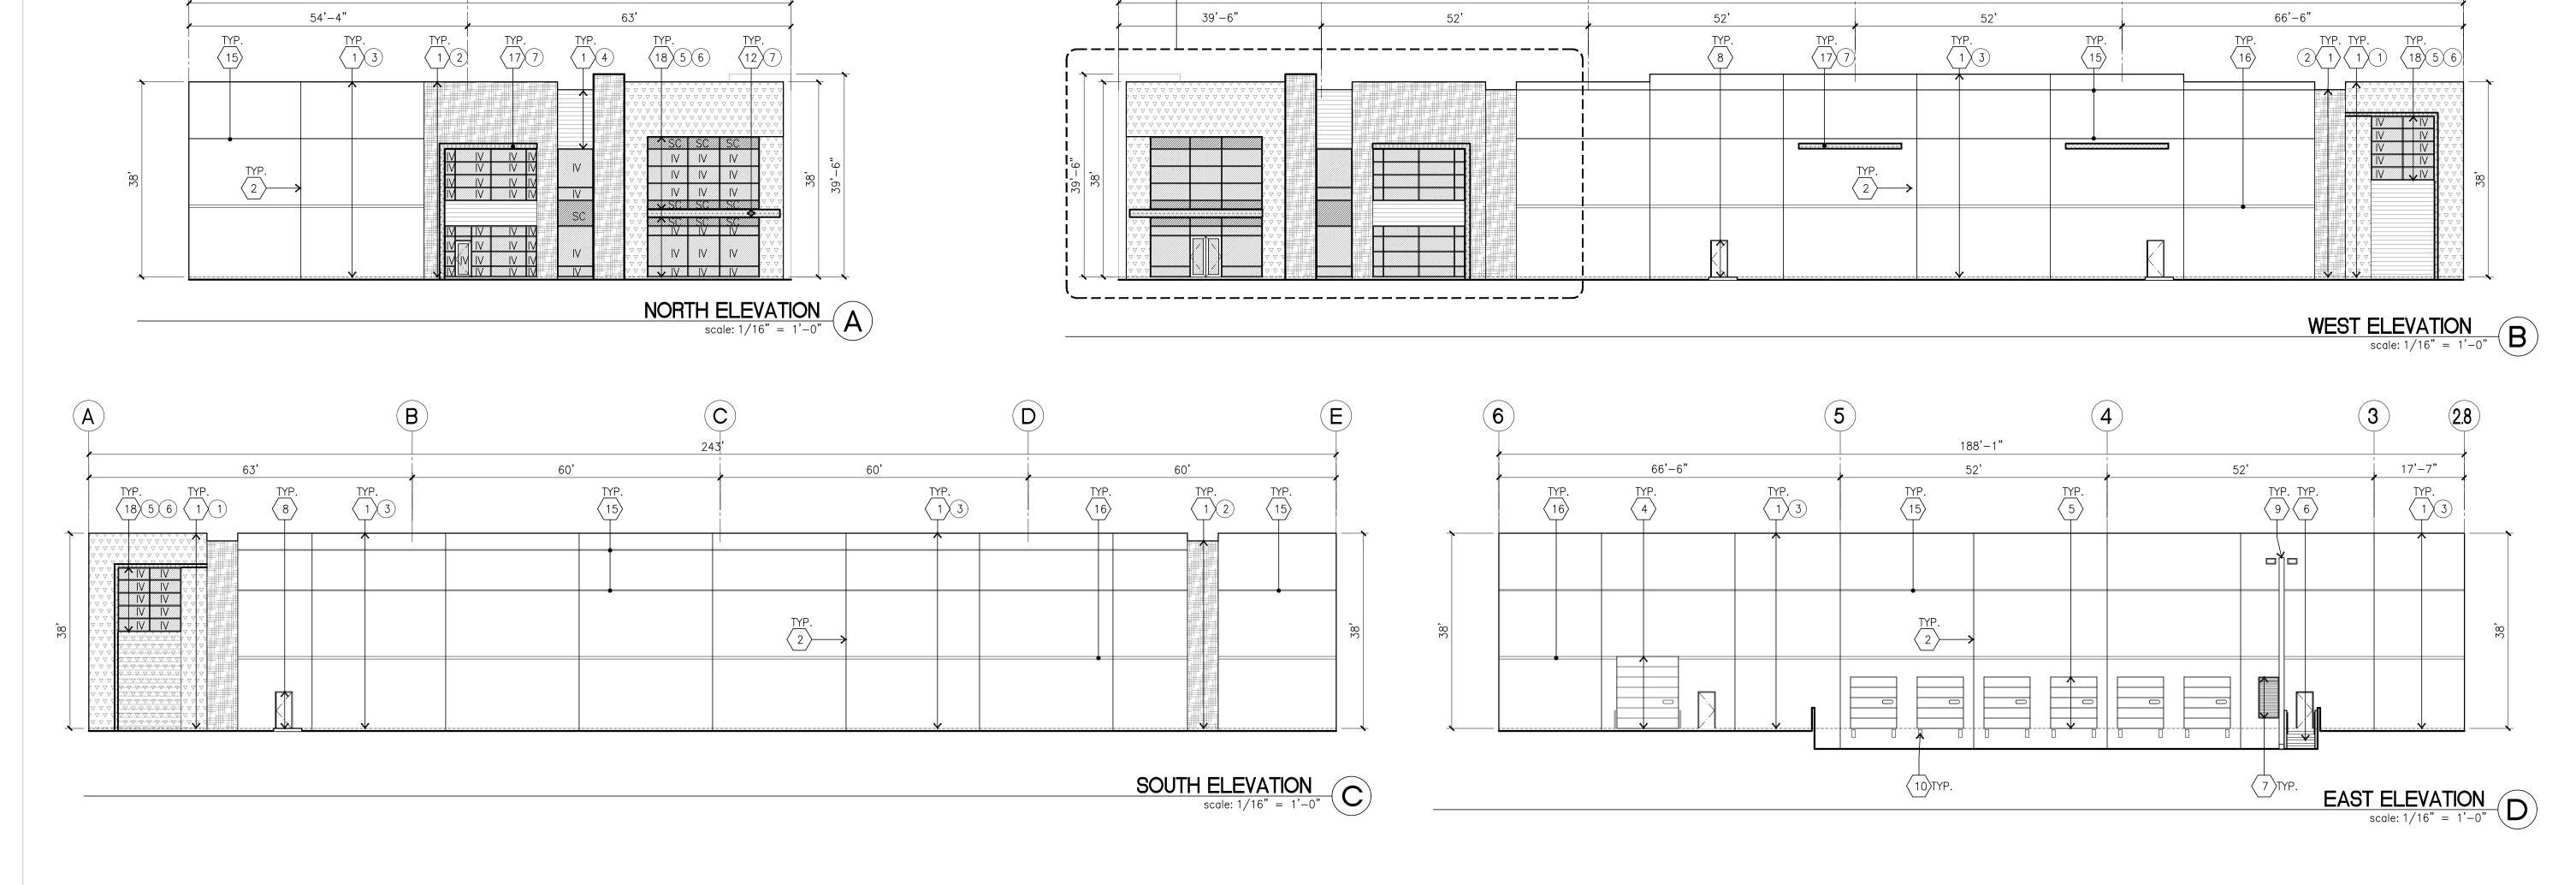

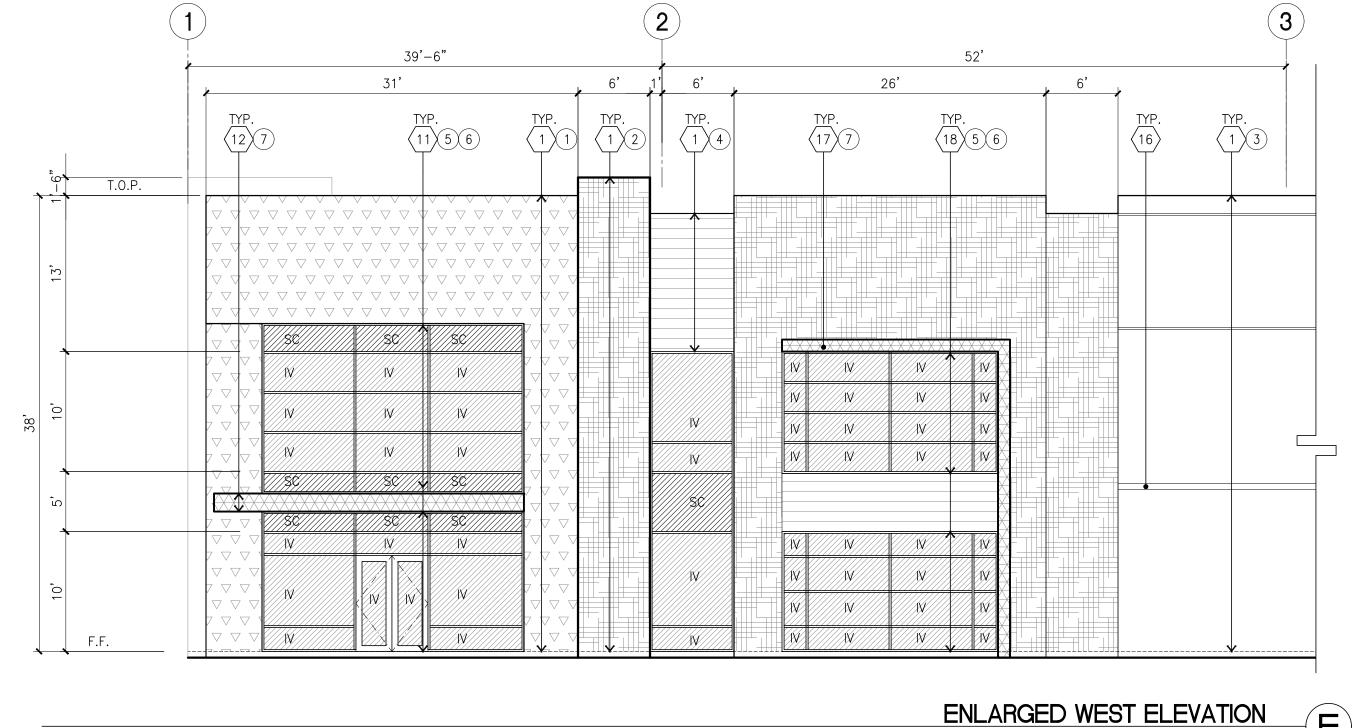

(B.8)

117'-4"

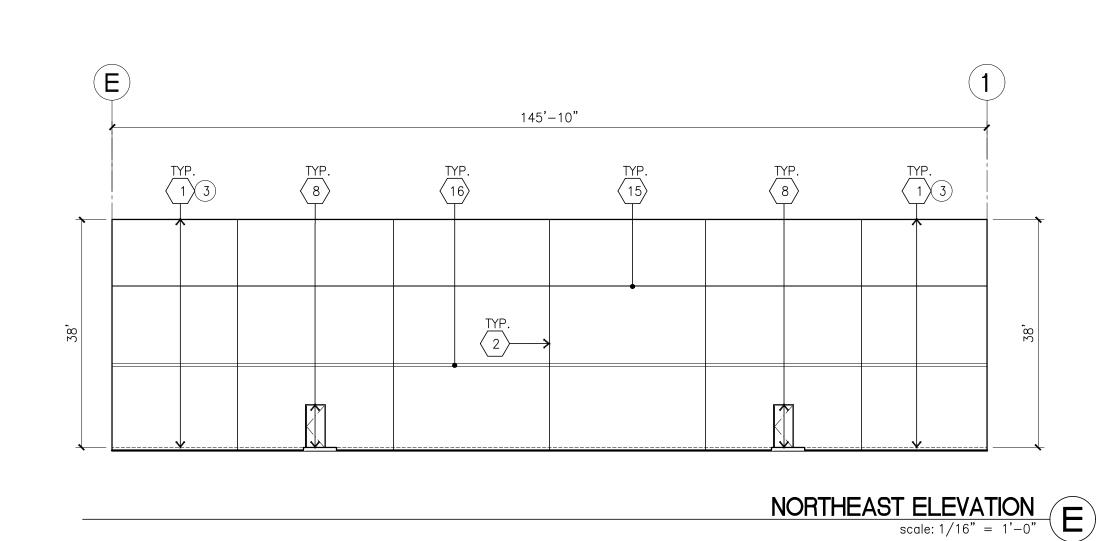

ELEVATION KEYNOTES

- 1 CONCRETE TILT-UP PANEL.
- $\langle 2 \rangle$ PANEL JOINT.
- $\overline{\langle 3 \rangle}$ NOT USED.
- 4 12' X 14' OVERHEAD DOOR @ DRIVE THRU. PROVIDE COMPLETE WEATHER-STRIPPING PROTECTION ALL AROUND.
- 9' X 10' OVERHEAD DOOR @ DRIVE THRU. PROVIDE COMPLETE
- WEATHER-STRIPPING PROTECTION ALL AROUND.

 CONCRETE STAIR, LANDING AND GUARDRAIL W/ METAL PIPE HANDRAIL.

 PROVIDE NON SKID NOSING TO MEET ADA REQUIREMENTS. PROVIDE
 CONTRASTING COLORED 3" WIDE WARNING STRIPE INTEGRAL TO CONCRETE
- AT TOP LANDING AND BOTTOM TREAD PER ADA REQUIREMENTS.

 7 4' X 8' METAL LOUVER OPENING FOR VENTILATION. PAINT TO MATCH BUILDING COLOR.
- 8 HOLLOW METAL DOORS. PROVIDE COMPLETE WEATHER STRIPING ALL AROUND DOOR.
- $\overline{\left(9\right)}$ EXTERIOR DOWN SPOUTS W/ 2 OVERFLOW SCUPPERS.
- 10 DOCK DOOR BUMPER TYPICAL.
- ALUMINUM STOREFRONT FRAMING WITH TEMPERED GLAZING AT ALL DOORS, SIDELITES ADJACENT TO DOORS AND GLAZING WITH BOTTOMS LESS THAN 18" ABOVE FINISH FLOOR ELEVATION.
- $\langle 12 \rangle$ METAL CANOPY.
- 13 INTERIOR ROOF DRAIN W/ 2 OVERFLOW SCUPPERS.
- (14) CONC. FILLED GUARD POST. 6" DIA. U.N.O. AT 42"H.
- 2" HORIZONTAL REVEAL WITH 3/8" CHAMFER. REVEAL COLOR TO MATCH ADJACENT BUILDING FIELD COLOR. U.N.O.
- 6" HORIZONTAL REVEAL WITH 3/8" CHAMFER. REVEAL COLOR TO MATCH ADJACENT BUILDING FIELD COLOR. U.N.O.
- 17) ADJACENT BUILDING FIELD COLOR. U.N.O.

 17) METAL POP OUT HORIZONTAL FACADE ABOVE
- $\langle 18 \rangle$ ALUMINUM STOREFRONT FRAMING WITH GLAZING

ELEVATION GENERAL NOTES

- ALL PAINT COLOR CHANGES TO OCCUR AT INSIDE CORNERS UNLESS NOTED OTHERWISE.
- 2. ALL PAINT FINISHES ARE TO BE FLAT UNLESS NOTED OTHERWISE.
- 3. T.O.P. EL.= TOP OF PARAPET ELEVATION.
- 4. F.F. = FINISH FLOOR ELEVATION.
- 5. STOREFRONT CONSTRUCTION: GLASS, METAL ATTACHMENTS AND LINTELS SHALL BE DESIGNED TO RESIST MPH. EXPOSURE "C" WINDS. CONTRACTOR SHALL SUBMIT SHOP DRAWINGS PRIOR TO INSTALLATION.
- CONTRACTOR SHALL FULLY PAINT ONE CONCRETE PANEL W/ SELECTED COLORS. ARCHITECT AND OWNER SHALL APPROVE PRIOR TO PAINTING REMAINDER OF BUILDING.
- 7. BACK SIDE OF PARAPETS TO HAVE SMOOTH FINISH AND BE PAINTED WITH ELECTROMETRIC PAINT.8. FOR SPANDREL GLAZING, ALLOW SPACE BEHIND SPANDREL TO BREATH.
- PROVIDE 1" DIAMETER HOLES AT CONCRETE WALL.

 9. USE ADHESIVE BACK WOOD STRIPS FOR ALL REVEAL FORMS.
- 10. THE FIRST COAT OF PAINT TO BE ROLLED-ON AND THE SECOND COAT TO BE SPRAYED-ON
- 11. ALL ROLL-UP DOORS AND SERVICE DOORS TO BE PAINTED TO MATCH BUILDING COLOR.

ELEVATION COLOR LEGEND/SCHED.

- PAINT. COLOR: SW 7525 TREE BRANCH (288C7)
- 2 PAINT. COLOR: SW 7638 JOGGING PATH (247-C2)
- PAINT. COLOR: SW 9166 DRIFT OF MIST (238-C2)

 PAINT. COLOR: SW METAL PANEL LONGBOARD LIGHT BAMBOO
- 5 MULLIONS COLOR : CLEAR ANODIZED
- 6 GLAZING COLOR: BLUE REFLECTIVE
- METAL CANOPY WITH DUNN EDWARDS DEA 160 HOPE CHEST

GLAZING LEGEND

NOTE: ALL EXTERIOR AND INTERIOR GLAZING SHALL BE TEMPERED.

INSULATED VISION GLASS

SPANDREL GLASS WITH CONCRETE BEHIND

SINGLE LITE VISION GLASS

- IV: INSULATED VISION GLASS

 1/4" VISTACOOL PACIFICA + 1/4" SOLARBAN 60 CLEAR

 1" INSULATED GLASS UNIT WITH 1/2" AIRSPACE AND 1/4" LITES

 U: 0.27 SHGC: 0.21 VLT: 26%

 MINIMUM VT TO BE 0.42 PER 2016 CEC TABLE 140.3—B
- SC: SPANDREL WITH CONCRETE BEHIND 1/4" VISTACOOL PACIFICA WITH WARM GRAY OPACICOAT PAINTED ON REFLECTIVE. INSTALLED ON CONCRETE.
- INSTALLED ON CONCRETE.

 V : VISION GLASS

 1/4" VISTACOOL PACIFICA
- 1/4" VISTACOOL PACIFICA

 MULLIONS : ANODIZED CLEAR.



hpa, inc.

18831 bardeen avenue - ste.


#100 irvine, ca

92612

tel: 949 • 863 • 1770

fax: 949 • 863 • 0851

email: hpa@hparchs.com

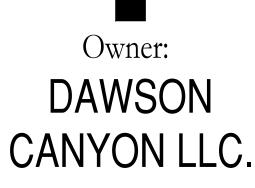

11777 San Vicente Blvd, Ste. 780 Los Angeles, CA 90049 tel: (949) 296-7006 fax: (949) 842-3074

TEMESCAL VALLEY
COMMERCE CENTER

DAWSON CANYON RD. CORONA, CA 92883



THIENES

DCW3

Structural:

Mechanical:

TBD

Plumbing:

TBD

Electrical:

TBD

Landscape: HUNTER LANDSCAPE

Fire Protection:

Soils Engineer:

Title:

Project Number: 19277
Drawn by: AW


ELEVATION

Date: 11/10/22
Revision:


Revision:

Sheet:


7-DAB-A3.1

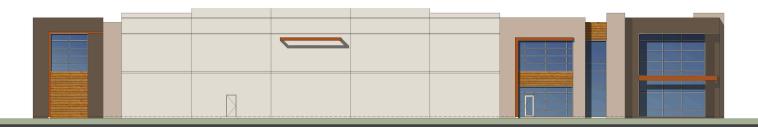

Building 1 - North Elevation - Dawson Canyon Road

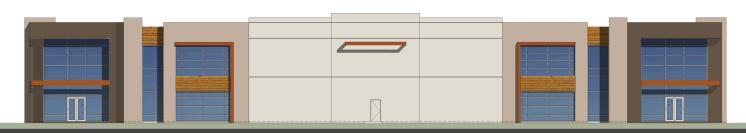

Building 1 - West Elevation - Temescal Canyon Road

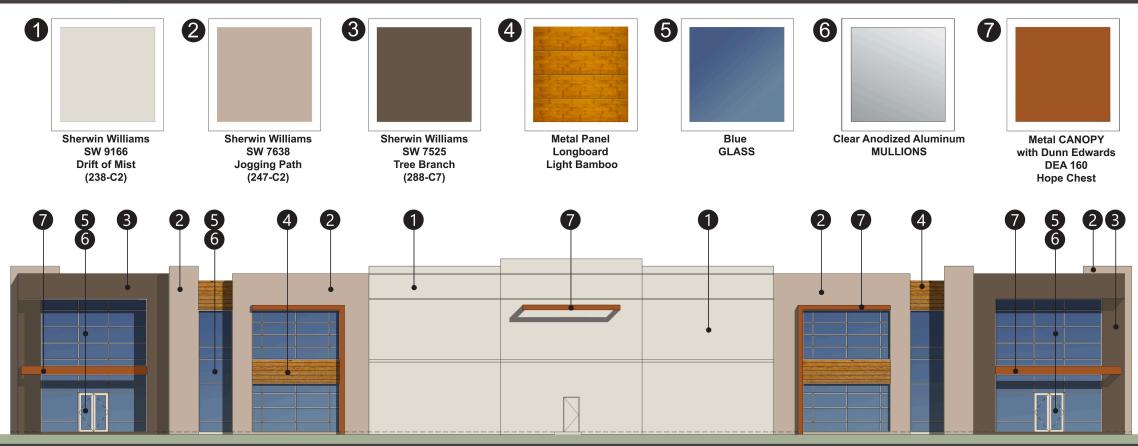

Enlarged View of Building 1 - West Elevation - Temescal Canyon Road

















TEMESCAL CANYON RD. & DAWSON CANYON RD. CORONA, CA.












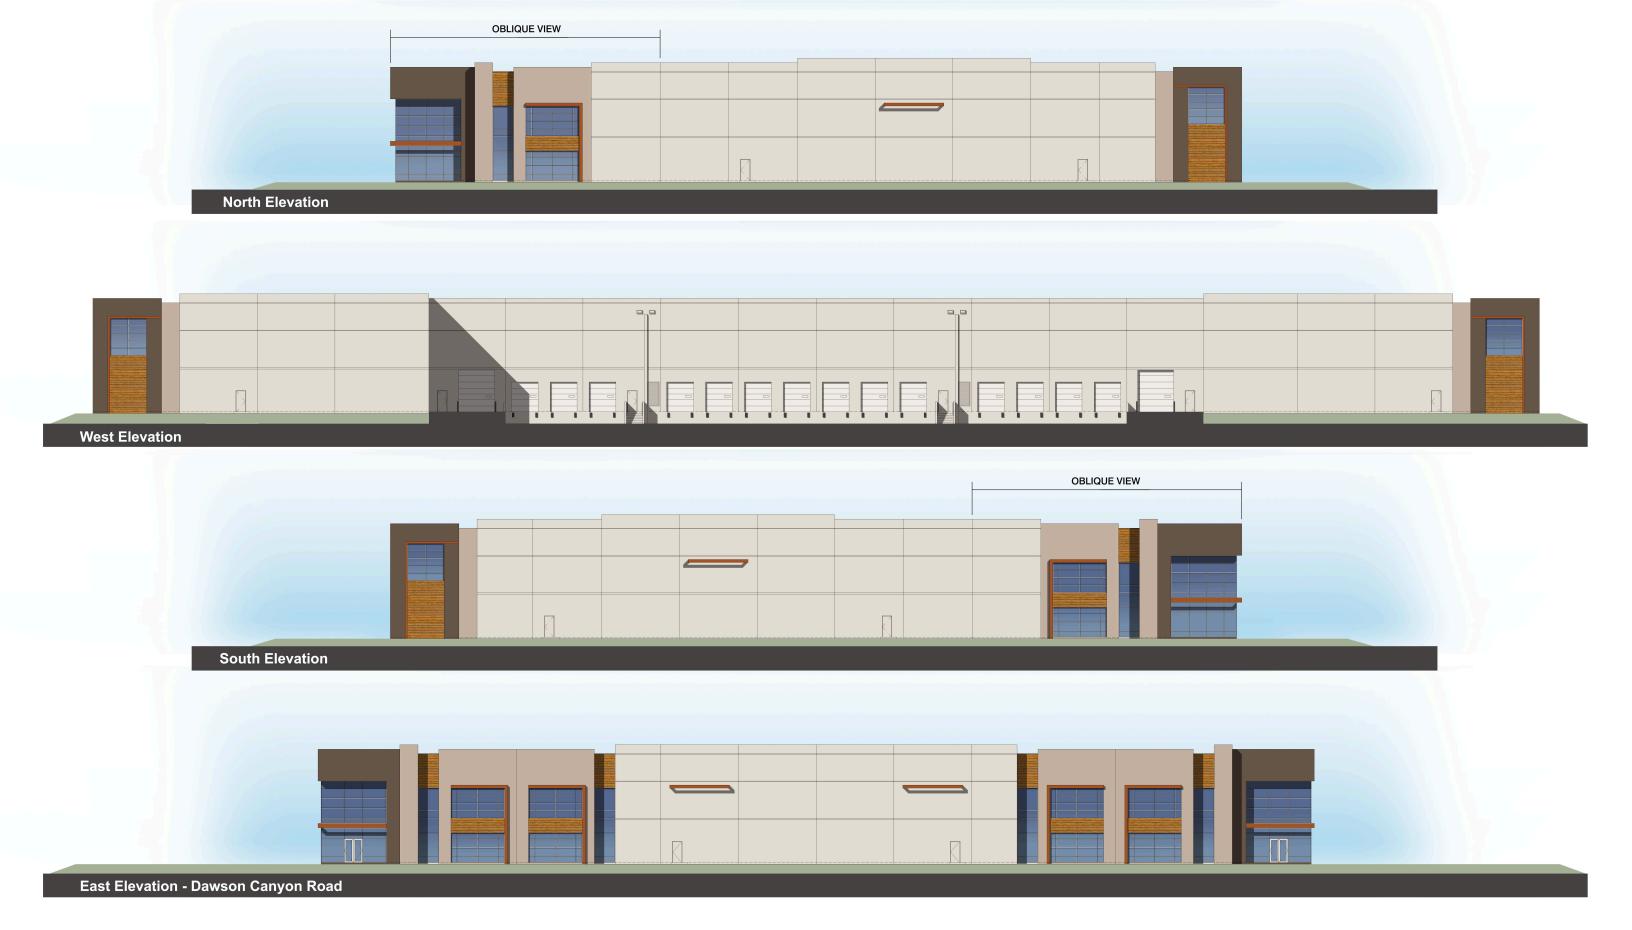



TEMESCAL CANYON RD. & DAWSON CANYON RD. CORONA, CA.












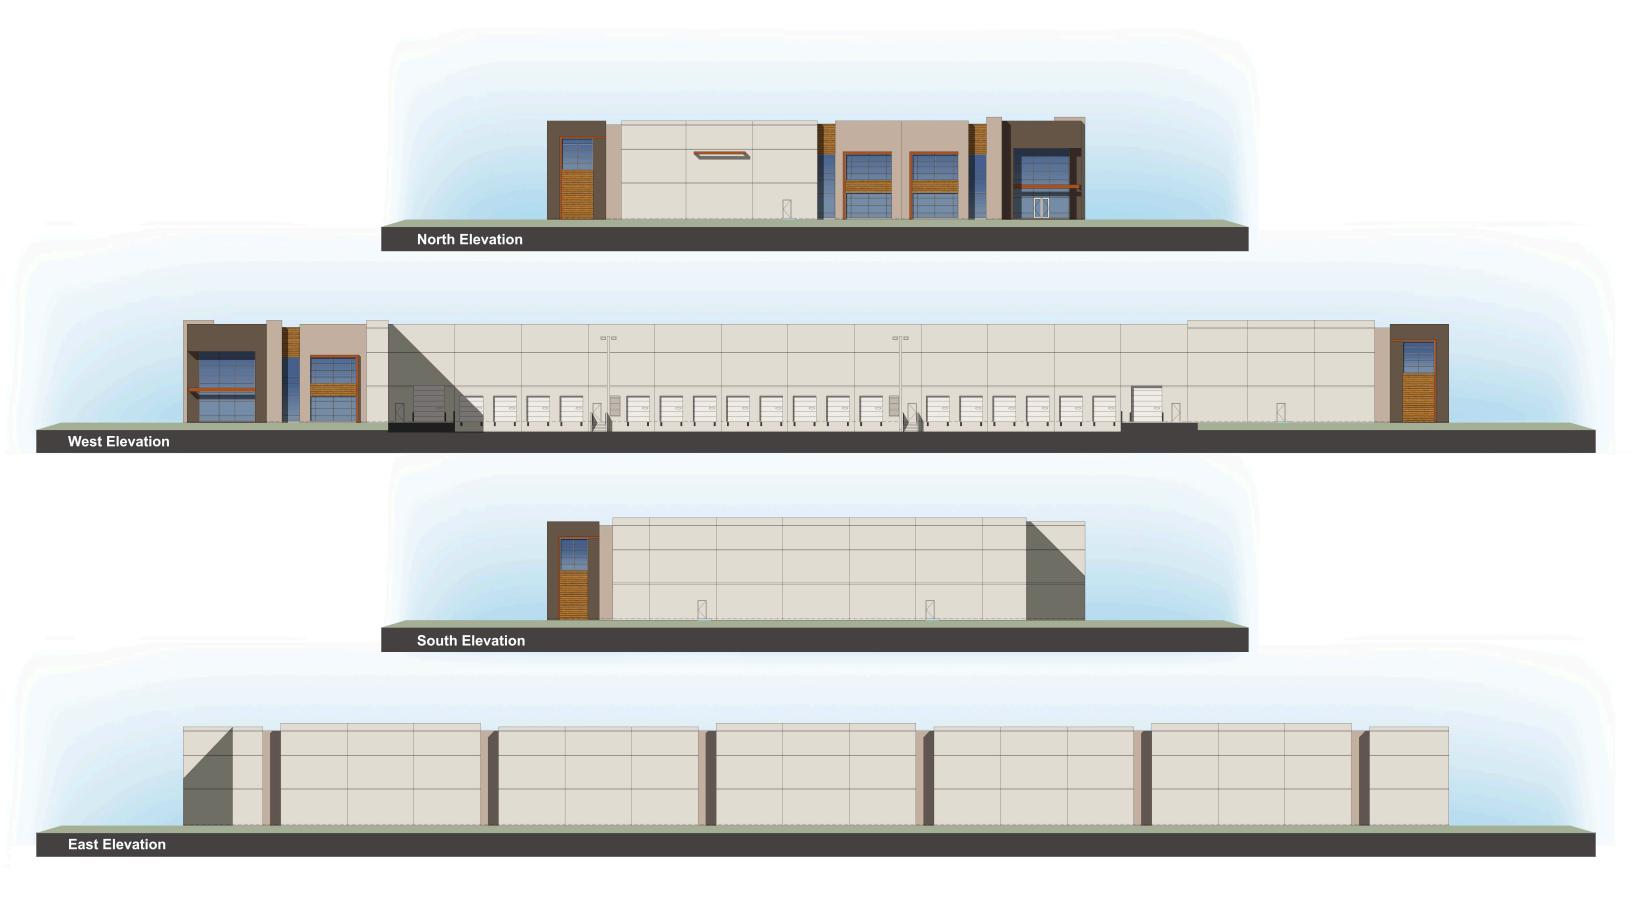



TEMESCAL CANYON RD. & DAWSON CANYON RD. CORONA, CA.









